# WOODLAND PARK - EUCLID IMPROVEMENTS



# PROJECT DIRECTORY

## APPLICANT:

Woodland Park Communities 5 Newell Court East Palo Alto, CA 94303 ATTN: Michael Kramer mkramer@wlpcommunities.com

## ARCHITECT:

**David Baker Architects** 461 2nd Street, Loft C-127 San Francisco, CA 94107 ATTN: Daniel Simons danielsimons@dbarchitect.com

# LANDSCAPE ARCHITECT:

Hood Design Studio 3016 Filbert Street #2 Oakland, CA 94608 ATTN: Alma du Solier alma@hooddesignstudio.com

# **CIVIL ENGINEER:**


**BKF** Engineers 150 California Street, Ste 600 San Francisco, CA 94111 ATTN: Cole Gaumnitz cgaumnitz@bkf.com

# PROJECT DESCRIPTION

With <u>no displacement</u>, this project proposes the replacement of several aging, outdated structures containing 160 rent-stabilized housing units and one single family rental (non-RSO) with new mixed-income buildings containing 605 apartments, 26% of which will be deed-restricted rentcontrolled, replacing the existing apartments one-for-one.

Note: No portion of the property is located in a Flood Zone as designated by the Federal Emergency Managment Agency (FEMA).

# **VICINITY MAP**

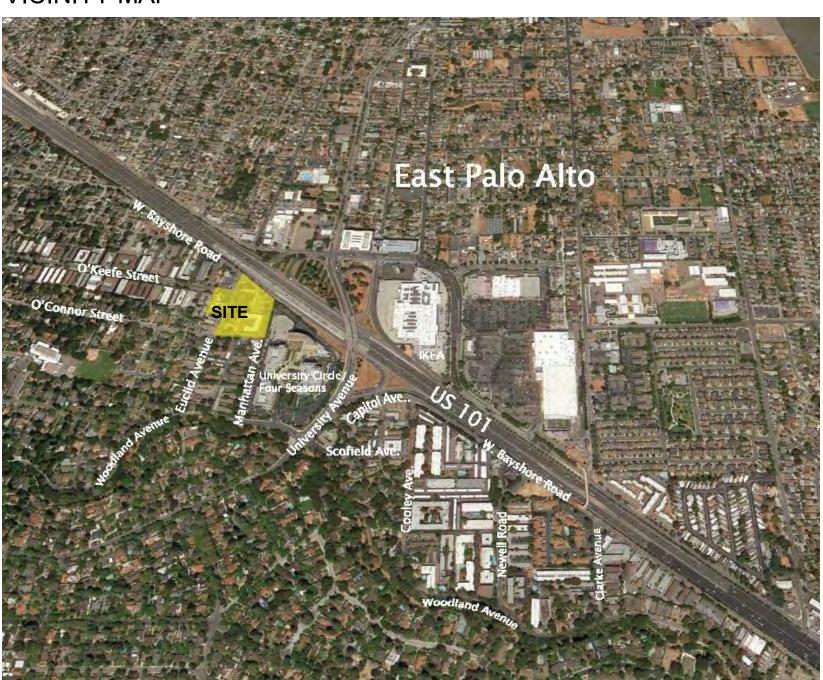

## PROJECT SITE

**ZONING:** 

R-HD-5, R-UHD

**GENERAL PLAN DESIGNATION:** HIGH DENSITY RESIDENTIAL / **URBAN RESIDENTIAL** 

**TOTAL SITE AREA:** 170.941 SF = 3.92 ACRES

#### **EXISTING LOTS:**

ADDRESSES: 063282010 501 O'Connor St. 2012 Euclid Ave. 063282020 063282030 2032 Euclid Ave. 063282040 2036 Euclid Ave. 2040 & 2042 Euclid Ave. 063282050 2044 Euclid Ave. 2054 Euclid Ave. 2033 Manhattan Ave. 063282080 2001 Manhattan Ave. 063282090 2021 Euclid Ave. 063281020 2025 Euclid Ave. 063281030 2031 Euclid Ave. 063281040 2043 Euclid Ave. 063281100

2041 Euclid Ave./420 E O'Keefe St.

# SHEET INDEX

#### **GENERAL**

TITLE SHEET CONTEXT PERSPECTIVE VIEWS PERSPECTIVE VIEWS **AERIAL VIEW** FIRE DIAGRAMS

**CODE ANALYSIS - GENERAL** CODE ANALYSIS - LEVEL 1

### ARCHITECTURE

SITE PLAN - EXISTING SITE PLAN - PROPOSED FLOOR PLAN - BASEMENT FLOOR PLAN - LEVEL 1 FLOOR PLAN - LEVEL 2 FLOOR PLAN - LEVELS 3 FLOOR PLAN - LEVELS 4-9 FLOOR PLAN - LEVELS 10-13 **BUILDING ELEVATIONS BUILDING ELEVATIONS** BUILDING SECTIONS **EXTERIOR MATERIALS** 

TYPICAL UNIT PLANS - BUILDING A TYPICAL UNIT PLANS - BUILDING A TYPICAL UNIT PLANS - BUILDING B TYPICAL UNIT PLANS - BUILDING C

UNIT PRECEDENTS OPEN SPACE DIAGRAMS GROUND FLOOR CHARACTER

### LANDSCAPE

LANDSCAPE SITE PLAN L-1.1 LANDSCAPE DETAILS PLANTING PLAN TREE PROTECTION AND REMOVALS LIST AND T-0.1

TREE PROTECTION & REMOVAL PLAN

### CIVIL

EXISTING CONDITIONS AND DEMOLITION PLAN PRELIMINARY SITE PLAN PRELIMINARY GRADING AND DRAINAGE PLAN PRELIMINARY UTILITY PLAN

PRELIMINARY STORMWATER MANAGEMENT PLAN PRELIMINARY STORMWTER MANAGEMENT PLAN

PRELIMINARY FIRE ACCESS PLAN

VESTING TENTATIVE PARCEL MAP - TITLE SHEET **VESTING TENTATIVE PARCEL MAP - MAPPING** SHEET

# PROJECT DATA

#### **GROSS AREAS**

CIRCULATION	84,315 SF
COMMON	18,931 SF
GARAGE	213,857 SF
RESIDENTIAL	425,336 SF
RETAIL	5,187 SF
SERVICE	14,462 SF
STAIRS / ELEV.	37,385 SF
Total	799,472 SF

#### **UNIT MIX**

TYPE	CURRENT*	MIX	PROPOSED	MIX	AVG. AREA
STUDIO	53	33%	228	38%	405 sf
1 BR	102	64%	197	33%	650 sf
2 BR	4	2%	178	29%	960 sf
3 - 4 BR	2	<1%	2	<1%	1,825 sf
TOTAL	161		605		

STALLS	CURRENT	PROPOSED
OFF-STREET	155	625
ON-STREET	52	52

(17 of the proposed spaces are ADA, including 2 ADA Van spaces) Parking Ratio = 1.03 spaces/unit

CLASS I: BUILDING B (@ EUCLID AVE.): 108 STALLS BUILDING C (@ W.BAYSHORE RD.): 144 STALLS TOTAL: 324 STALLS

CLASS II: 45 STALLS

TOTAL SITE AREA = 31,596 SF + 139,345 SF = 170,941 SF

TOTAL BUILDING FOOTPRINT AREA = 13,870 SF + 73,725 SF = 96,860 SF

LOT COVERAGE = 96,860 / 170,941 SF = **57%** 

### F.A.R. REQUIRED: N/A

(PER DEVELOPMENT CODE SECTION 18.10 TABLE 2-2)

TYPE	CURRENT*	MIX	PROPOSED	MIX	AVG. AREA
STUDIO	53	33%	228	38%	405 sf
1 BR	102	64%	197	33%	650 sf
2 BR	4	2%	178	29%	960 sf
3 - 4 BR	2	<1%	2	<1%	1,825 sf
TOTAL	161		605		

\* There are 160 current rent-stabilized units and one 2 BR single-family rental (non-RSO)

#### **PARKING**


STALLS	CURRENT	PROPOSED
OFF-STREET	155	625
ON-STREET	52	52

### **BIKE PARKING**

BUILDING A (@ O'KEEFE ST.): 72 STALLS

### LOT COVERAGE CALCULATIONS

# Woodland Park Euclid Improvements

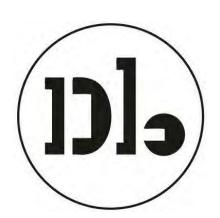

## **David Baker Architects**

dbarchitect.com 461 Second St, Loft c127 San Francisco, CA 94107 415.896.6700

License Stamp

09/25/2019

	Issuances
Description	Date
Entitlements Submission	09/25/2019

		Revisions
Rev.	Description	Date
1 R	esponse to Comments	11-20-2020

Application -September 2019

**Drawing Title** 

TITLE SHEET

G000

01-08-2021 Project No. 21620

1- VIEW OF PARK FROM O'CONNOR ST.



2- VIEW OF EUCLID LOOKING TOWARDS O'KEEFE ST.



**David Baker Architects** 

dbarchitect.com 461 Second St, Loft c127 San Francisco, CA 94107 415.896.6700

License Stamp

	Issuances
Description	Date
Entitlements Submission	09/25/2019

		Revisions
Rev.	Description	Date

Set Little

Application - September 2019

Drawing Title

PERSPECTIVE VIEWS

G101


 Date
 01-08-2021

 Project No.
 21620


MANHATTAN AVE.

KEY PLAN

1- VIEW DOWN EUCLID AVE. LOOKING NORTH

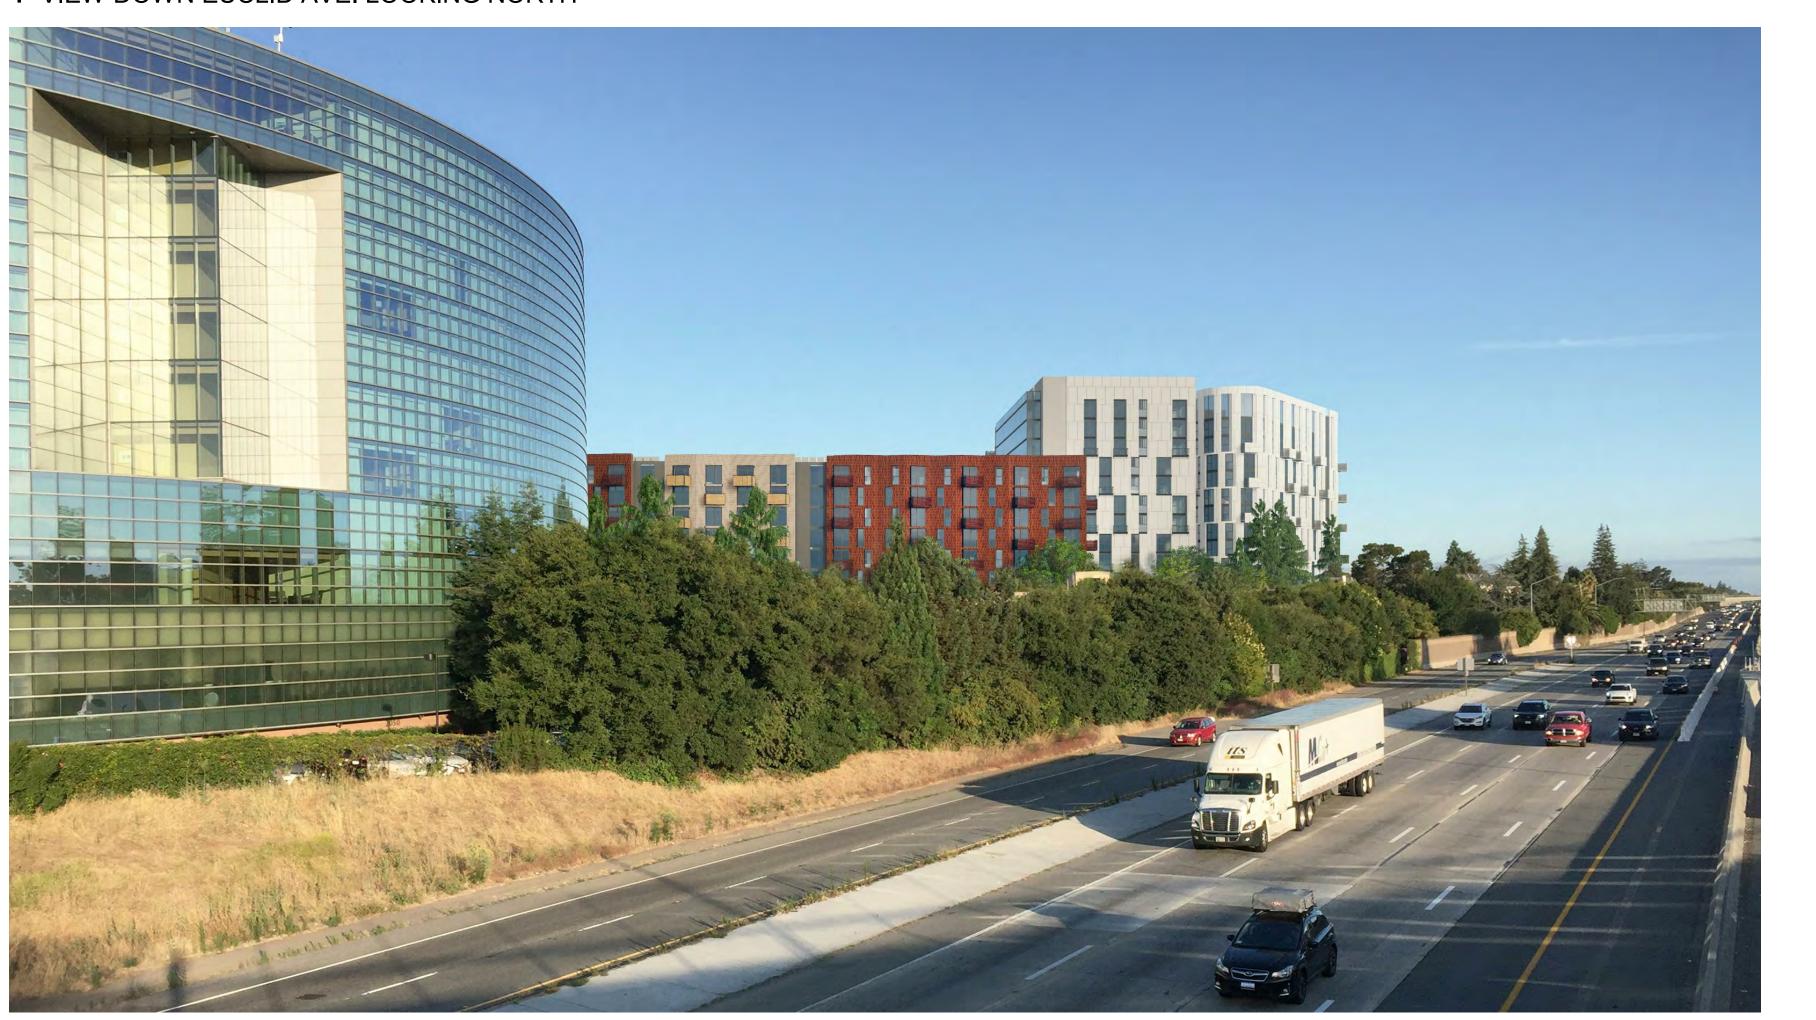

2- VIEW FROM US 101/ UNIVERSITY AVE OVERPASS (FOUR SEASONS HOTEL IN FOREGROUND)

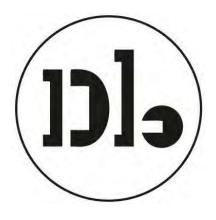

**David Baker Architects** 

dbarchitect.com 461 Second St, Loft c127 San Francisco, CA 94107 415.896.6700

License Stamp

	Issuances
Description	Date
Entitlements Submission	09/25/2019

		Revisions
Rev.	Description	Date
1 R	esponse to Comments	11-20-2020

Set Titl

Application -September 2019

Drawing Title

PERSPECTIVE VIEWS

Sheet No

G102

 Date
 01-08-2021

 Project No.
 21620

EUCLID AVE.

MANHATTAN AVE.


KEY PLAN



# PROJECT



# Woodland Park Euclid Improvements

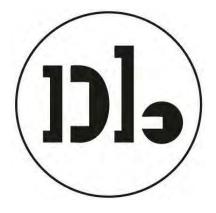

# **David Baker Architects**

dbarchitect.com 461 Second St, Loft c127 San Francisco, CA 94107 415.896.6700

License Stamp

	Issuances
Description	Date
Entitlements Submission	09/25/2019

		Revision
Rev.	Description	Dat

Set T

Application -September 2019

Drawing Title

**AERIAL VIEW** 

Sheet No.

G103

# RED DASH: 150' ACCESS \_\_\_\_<u>Level 5</u> - <u>C</u>\_\_\_\_\_ \_\_\_\_\_ \_\_\_\_\_ -\_\_<u>Level 4</u> -<u>C</u>\_\_\_ 125' - BUILDING A : AERIAL ACCESS LANE REQUIRED 15'-30' FROM BUILDING PER CFC FIRE APPARATUS SECTION D105 ROAD UNOBSTRUCTED AREA REQUIRED: 20' WIDE BY 13'-6" HIGH PER CFC 503.2.1 **BUILDING A** 1/16" = 1'-0" SECTION - FIRE LANE - BUILDING A **EXISTING FIRE** HYDRANT -EXISTING FIRE -HYDRANT FIRE APPARATUS ACCESS LANE RED DASH: 150' ACCESS EUCLID AVENUE PROPOSED PROPOSED FIRE HYDRANT RED DASH: 150' ACCESS <u>Level 1 - A</u> 0' - 0" 7' 3' 4' 8' 4' E RÈMOTENESS ÇFC D106.3 T BÈ GREATER THAN (1/2 OF THE AREA TO BE SERVED) **BUILDING C** 26' SIDEWALK -1/16" = 1'-0" SECTION - FIRE DIAGRAM @ E. O'KEEFE SETBACK VARIES (MOST CONSERVATIVE CONDITION SHOWN) **BUILDING B** BUILDING C IS HIGH RISE THEREFORE FIRE SERVICE ELEVATOR PROPOSED AS ALTERNATIVE TO AERIAL APPARATUS ACCESS LANE (SEE SHEET A201 FOR LOCATION) G200 - 3 HR FIRE SEPARATION BETWEEN BUILDINGS B & C PROPOSED FIRE HYDRANT – PROPOSÉD //FIRE HYDRANT AERIAL APPARATUS ACCESS LANE MANHATTAN AVE. BUILDING B: GREATER THAN 200 UNITS, 2 FIRE APPARATUS \_\_\_\_ACCESS LANES REQUIRED\_\_ | PER CFC SECTION D106 (MANHATTAN & EUCLID AVE) -Level 1 0' - 0" 8' 8' 4' 8' 4' 15' FOUR SEASONS / UNIVERSITY CIRCLE COMPLEX ACCESS LANE PARKING LANE 1" = 30'-0" 1/16" = 1'-0" Date FIRE DIAGRAM 3 SECTION - FIRE DIAGRAM @ MANHATTAN

# Woodland Park Euclid Improvements



# **David Baker Architects**

dbarchitect.com 461 Second St, Loft c127 San Francisco, CA 94107 415.896.6700

License Stamp

	Issuances
Description	Date
Entitlements Submission	09/25/2019

		Revisions
Rev.	Description	Date

Set Title

Application - September 2019

Drawing Title

FIRE DIAGRAMS

Sheet No.





#### **David Baker Architects**

dbarchitect.com 461 Second St, Loft c127 San Francisco, CA 94107 415.896.6700

License Stamp

DescriptionDateEntitlements Submission09/25/2019

Rev.DescriptionDate

Set Title

Application -September 2019

**Drawing Title** 

CODE ANALYSIS - GENERAL

G201



# **Existing properties:**

2021 Euclid Avenue (11 rent-stabilized units)

11 x Studio Units

2025 Euclid Avenue (7 rent-stabilized units)

6 x Studio Units 1 x 1 Bedroom Unit

2031 Euclid Avenue (12 rent-stabilized units)

12 x 1 Bedroom Units

2032 Euclid Avenue

1 x 2 Bedroom Single-Family-House (non-RSO)

2036 Euclid Avenue (4 rent-stabilized units)

2 x Studio Units 1 x 1 Bedroom Unit

2040 & 2042 Euclid Avenue (2 rent-stabilized units)

1 x 2 Bedroom Unit 1 x 4 Bedroom Unit

2041 Euclid Avenue (also known as 420 O'Keefe)

Community Engagement Office

2043 Euclid Avenue

Resident Services Office and Community Technology Center

2044 Euclid Avenue (2 rent-stabilized units)

1 x 2 Bedroom Unit 1 x 3 Bedroom Unit

2054 Euclid Avenue

(8 rent-stabilized units)

8 x 1 Bedroom Units

2012 Euclid Avenue/501 O'Connor Street (22 rent-stabilized units)


22 x 1 Bedroom Units

2001 Manhattan Avenue (60 rent-stabilized units)


> 8 x Studio Units 52 x 1 Bedroom Units

2033 Manhattan Avenue (32 rent-stabilized units)

26 x Studio Units 6 x 1 Bedroom Units

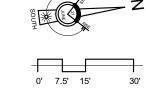

# Woodland Park Euclid Improvements

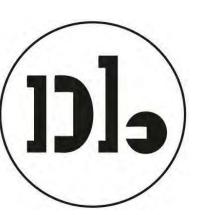

**David Baker Architects** 

dbarchitect.com 461 Second St, Loft c127 San Francisco, CA 94107 415.896.6700

License Stamp

Issuances Date Description **Entitlements Submission** 09/25/2019

Revisions Rev. Description Date

Set Title

Application -September 2019

**Drawing Title** 

SITE PLAN -**EXISTING** 

> Sheet No. A100

01-08-2021

Date

Project No.

21620

# LOBBY/ COMMON EUCLID AVENUE SEE LANDSCAPE PLANS FOR NEW SURFACE TREATMENTS, PLANTINGS AND SITE ELEMENTS SETBACK - PROPERTY BOUNDARIES SETBACK NEW BUS STOP DROP-OFF / LOADING AREA COWORKING LOBBY/ LOUNGE PKG RM. O'CONNOR ST. COMMUNITY SPACE/ NEIGHBORHOOD SERVING RETAIL 1 BR TH 1 BR TH 1 BR TH SHIGHNA TRASH 1 BR 1 BR TH TH 1 BR TH THINNER DASHED LINE INDICATES BUILDING OVERHANG ABOVE RED FILL REGIONS INDICATE CORNER VISION TRIANGLE MANHATTAN AVE. FOUR SEASONS / UNIVERSITY CIRCLE COMPLEX

# Woodland Park Euclid Improvements



## **David Baker Architects**

dbarchitect.com 461 Second St, Loft c127 San Francisco, CA 94107 415.896.6700

License Stamp

	Issuances
Description	Date
Entitlements Submission	09/25/2019

		Revisions
Rev.	Description	Date
1 R	esponse to Comments	11-20-2020

Set Title

Application -September 2019

**Drawing Title** 

SITE PLAN -PROPOSED

A101

01-08-2021 Project No. 21620

Z Z

# ELEC. / MAINT. 846 SF

# Woodland Park Euclid Improvements



vid Baker Architects

dbarchitect.com 461 Second St, Loft c127 San Francisco, CA 94107 415.896.6700

License Stamp

Description Date

Entitlements Submission 09/25/2019

Rev.DescriptionDate

Set Title

Application -September 2019

Drawing Title

FLOOR PLAN -BASEMENT

Sheet No.

A200

# SERVICE 292 SF ST. LOBBY/ COMMON 1361 SF EUCLID AVENUE NEW BUS STOP DROP-OFF / LOADING AREA GAMES COWORKING LIBRARY 2777 SF SERVICE ACCESS ELEV. LOBBY 915 SF W.C. O'CONNOR ST. COMMUNITY SPACE/ IEIGHBORHOOD SERVING RETAIL 6624 SF SHICHHAR SERVICE 858 SF 1 BR TH 1 BR 1 BR TH TH 1 BR 1 BR TH TH MANHATTAN AVE. 24' - 0" 37' - 6" 263' - 0" FOUR SEASONS / UNIVERSITY CIRCLE COMPLEX

# Woodland Park Euclid Improvements



# **David Baker Architects**

dbarchitect.com 461 Second St, Loft c127 San Francisco, CA 94107 415.896.6700

License Stamp

	Issuances
Description	Date
Entitlements Submission	09/25/2019

		Revisions
Rev.	Description	Date
1 R	esponse to Comments	11-20-2020

Set Title

Application - September 2019

Drawing Title

FLOOR PLAN -LEVEL 1

Sheet No.

A201


 Date
 01-08-2021

 Project No.
 21620

SOUTH Z

# E. O'KEEFE ( EUCLID AVENUE 175' - 5" PARKING GARAGE MANHATTAN AVE. 201' - 6" 24' - 0" 37' - 6" FOUR SEASONS / UNIVERSITY CIRCLE COMPLEX

# Woodland Park Euclid Improvements

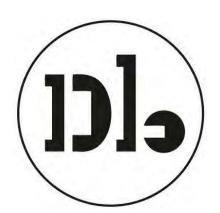

# **David Baker Architects**

dbarchitect.com 461 Second St, Loft c127 San Francisco, CA 94107 415.896.6700

License Stamp

	Issuances
Description	Date
Entitlements Submission	09/25/2019

		Revisions
Rev.	Description	Date

Set Title

Application - September 2019

**Drawing Title** 

FLOOR PLAN -LEVEL 2

Sheet No

A202


 Date
 01-08-2021

 Project No.
 21620

South Z

# 243' - 0" EUCLID AVENUE 135' - 3" PARKING GARAGE ROOF TERRACE MANHATTAN AVE. 269' - 4" FOUR SEASONS / UNIVERSITY CIRCLE COMPLEX

# Woodland Park Euclid Improvements

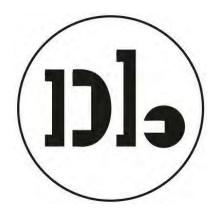

# **David Baker Architects**

dbarchitect.com 461 Second St, Loft c127 San Francisco, CA 94107 415.896.6700

License Stamp

	Issuances
Description	Date
Entitlements Submission	09/25/2019

		Revisions
Rev.	Description	Date

Set Title

Application - September 2019

Drawing Title

FLOOR PLAN -LEVELS 3

Sheet No


A203

 Date
 01-08-2021

 Project No.
 21620

# NOTE: WEST BUILDING ONLY LEVELS 4 & 5 EUCLID AVENUE 66' - 0" O'CONNOR ST. M. BASHOPERO. PARKING GARAGE MANHATTAN AVE. 269' - 4" FOUR SEASONS / UNIVERSITY CIRCLE COMPLEX

# Woodland Park Euclid Improvements

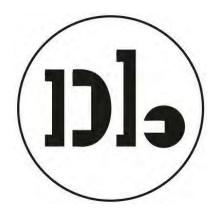

# **David Baker Architects**

dbarchitect.com 461 Second St, Loft c127 San Francisco, CA 94107 415.896.6700

License Stamp

	Issuances
Description	Date
Entitlements Submission	09/25/2019

		Revisions
Rev.	Description	Date

Set Title

Application - September 2019

Drawing Title

FLOOR PLAN -LEVELS 4-9

Sheet No

A204

 Date
 01-08-2021

 Project No.
 21620





# **David Baker Architects**

dbarchitect.com 461 Second St, Loft c127 San Francisco, CA 94107 415.896.6700

License Stamp

	Issuances
Description	Date
Entitlements Submission	09/25/2019

		Revisions
Rev.	Description	Date

Set Titl

Application -September 2019

Drawing Title


FLOOR PLAN -LEVELS 10-13

Sheet No

A205

# **MATERIAL LEGEND**


- 1 Textured Concrete with Vine Cover
- 2 Vertical Wood Siding
- 3 Storefront System
- 4 Cement Board (Dark)
- 5 Cement Board (Light)
- 6 Perforated Metal Screen (Painted) 7 - GFRC
- 8 Thin Brick
- 9 Aluminum Windows
- 10 Balconies with Perforated Metal Guardrails
- 11 Corten Steel Panels
- 12 Smooth Concrete
- 13 Metal Sunshade

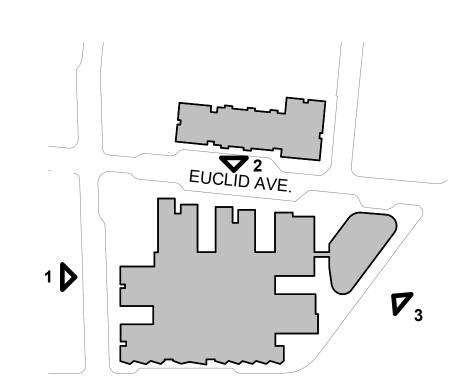


MANHATTAN AVE.

Key Plan
1" = 160'-0"


NOTE: PLEASE REFER TO LANDSCAPE PLAN FOR PLANTING LOCATIONS

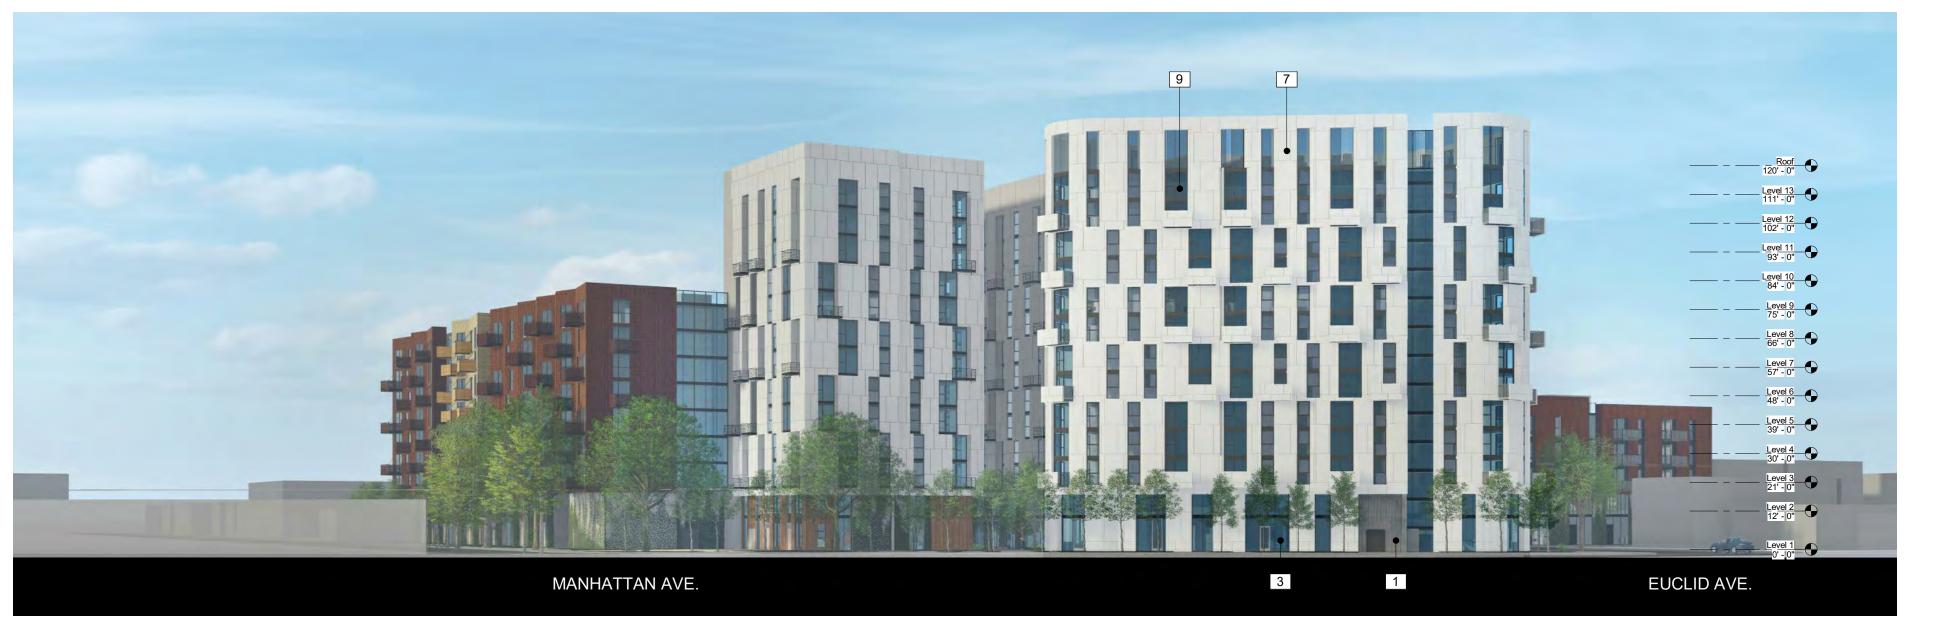

W. Bayshore Rd. Elevation - East Building
1" = 30'-0"

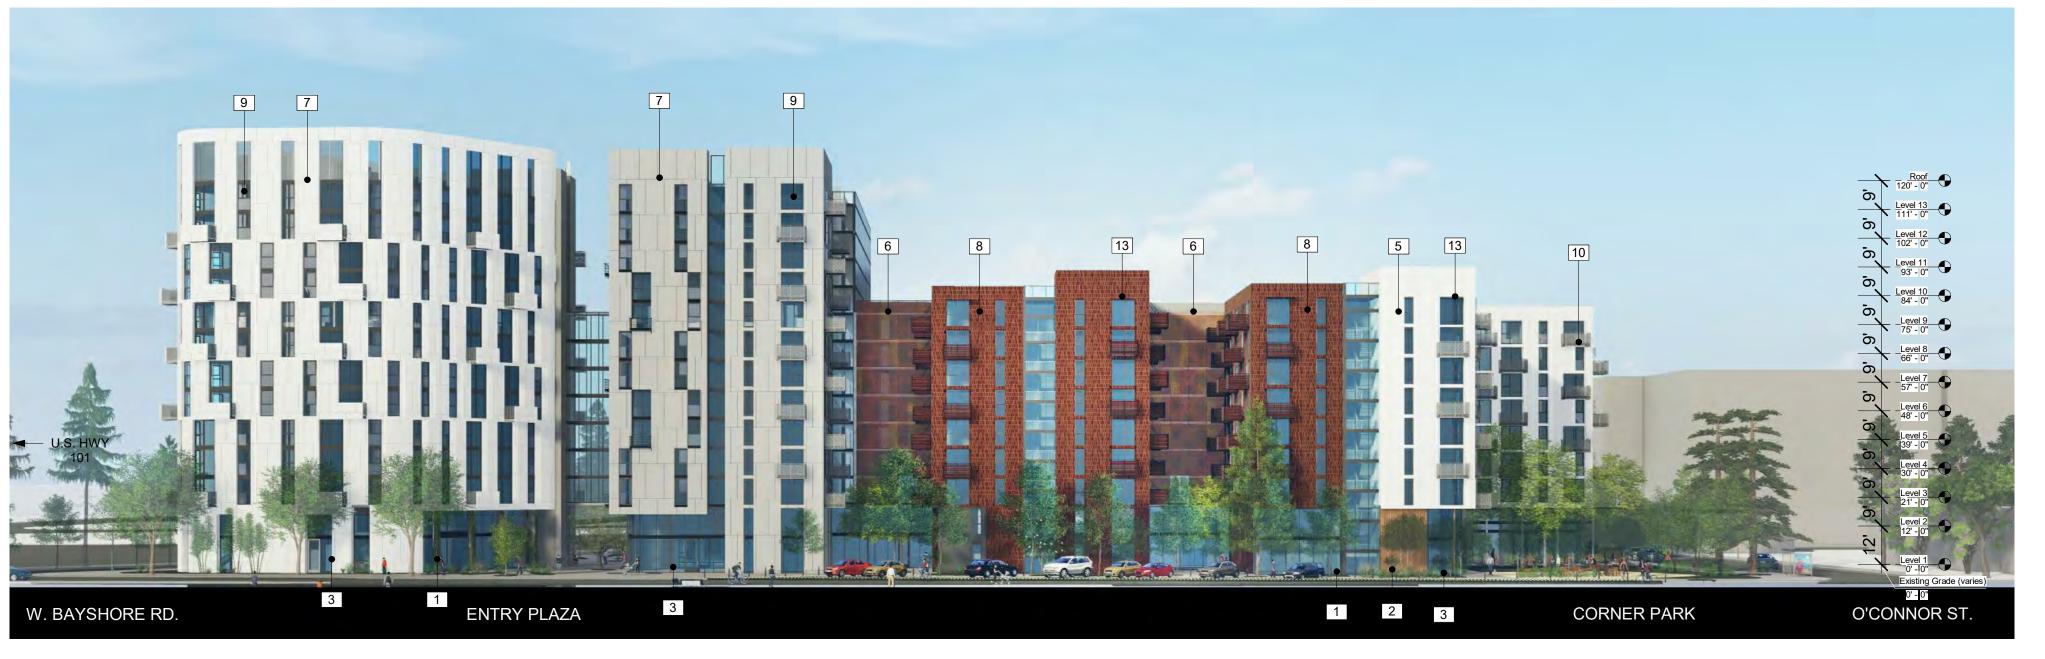

2 Euclid Ave. Elevation - East Building
1" = 30'-0"

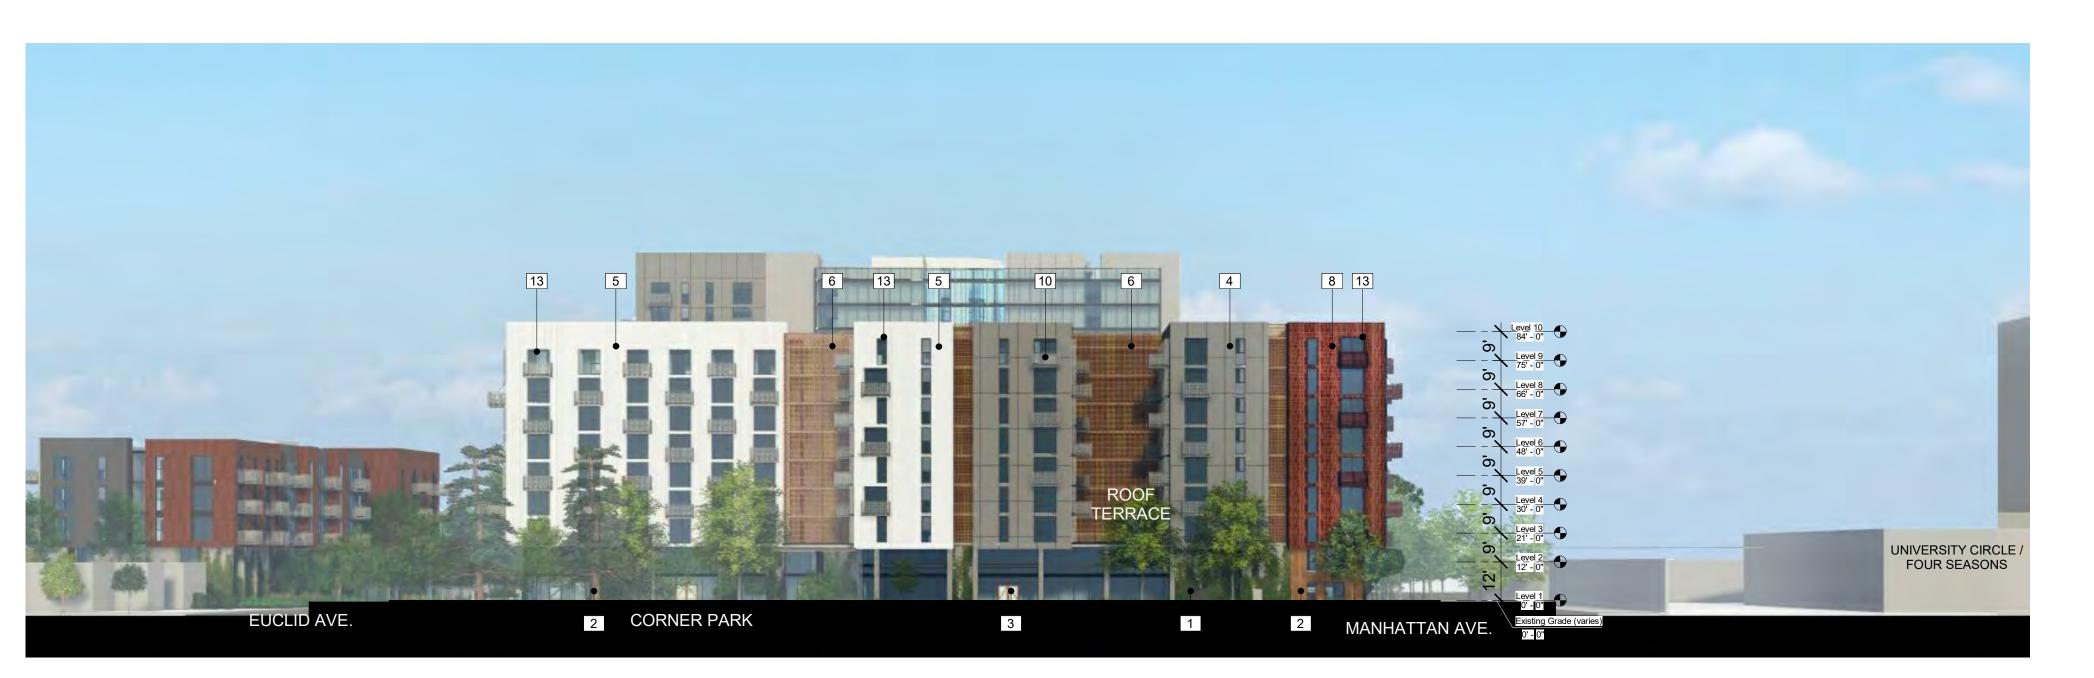

O'Connor St. Elevation - East Building
1" = 30'-0"

# Woodland Park Euclid Improvements



#### **David Baker Architects**

dbarchitect.com 461 Second St, Loft c127 San Francisco, CA 94107 415.896.6700

License Stamp

	Issuances
Description	Date
Entitlements Submission	09/25/2019

		Revisions
Rev.	Description	Date

Set Title

Application -September 2019

> **Drawing Title** BUILDING **ELEVATIONS**

> > Sheet No. A300


01-08-2021 Date Project No. 21620

# **MATERIAL LEGEND**


- 1 Textured Concrete with Vine Cover
- 2 Vertical Wood Siding 3 Storefront System 4 Cement Board (Dark)

- 5 Cement Board (Light)
- 6 Perforated Metal Screen (Painted) 7 - GFRC
- 8 Thin Brick
- 9 Aluminum Windows
- 10 Balconies with Perforated Metal Guardrails
- 11 Corten Steel Panels12 Smooth Concrete13 Metal Sunshade



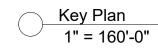



NOTE: PLEASE REFER TO LANDSCAPE PLAN FOR PLANTING LOCATIONS

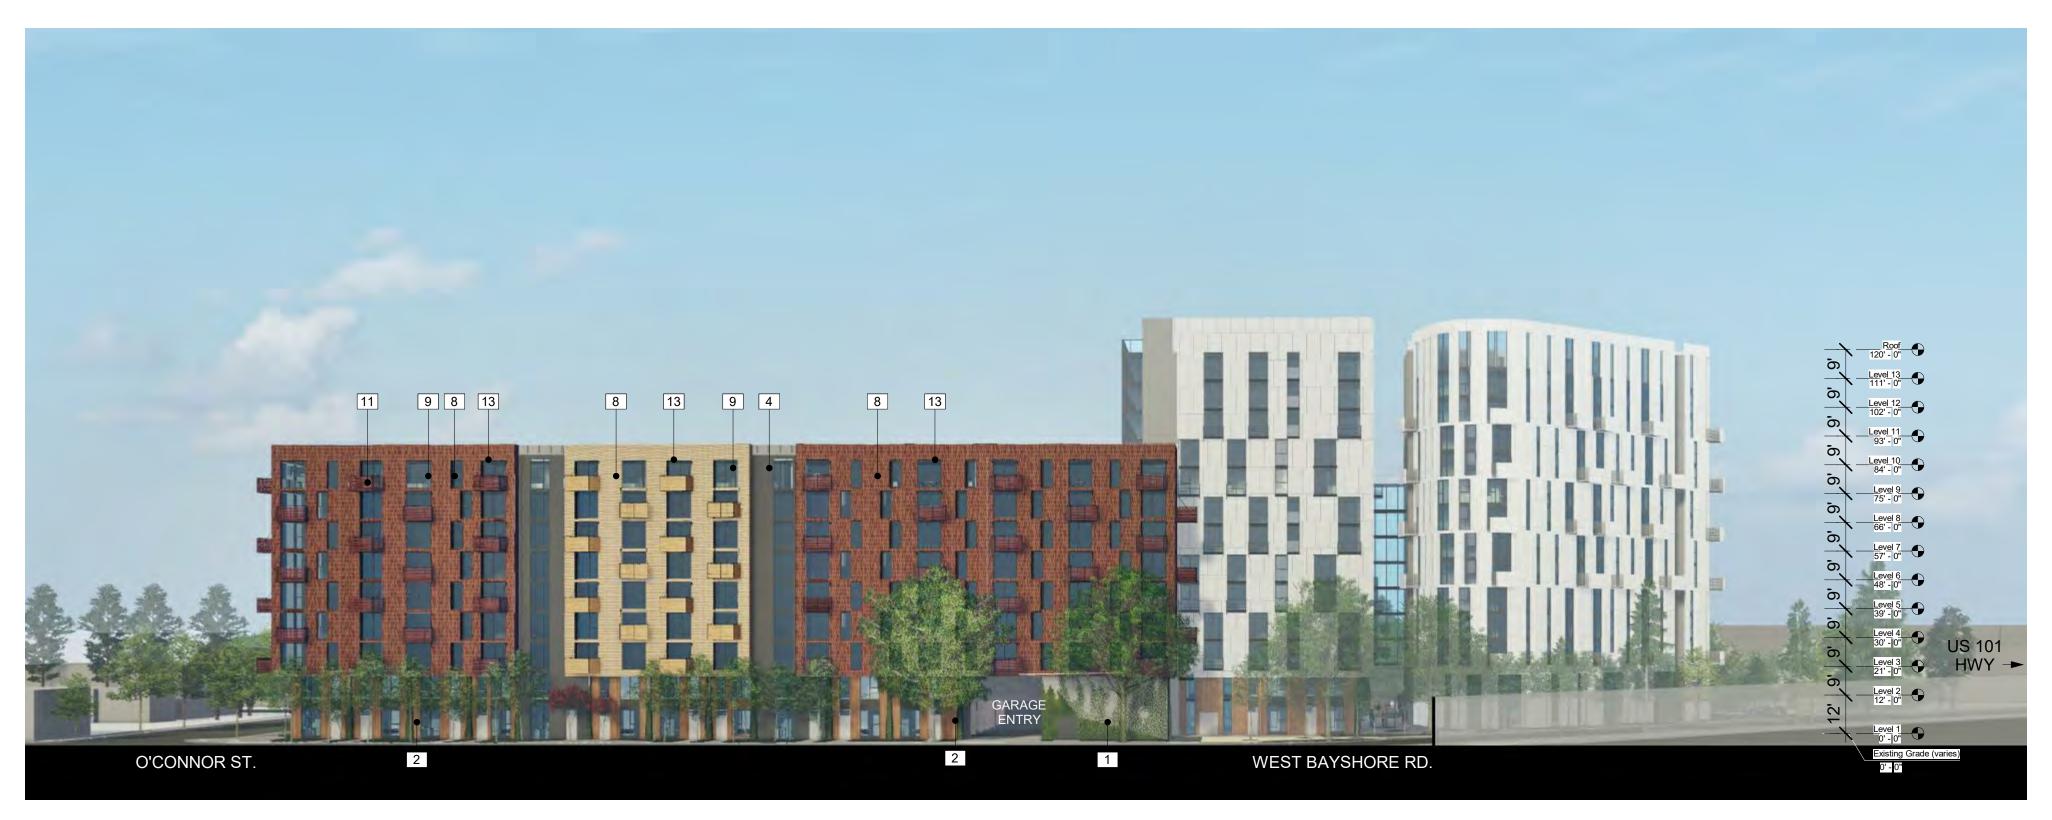





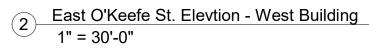

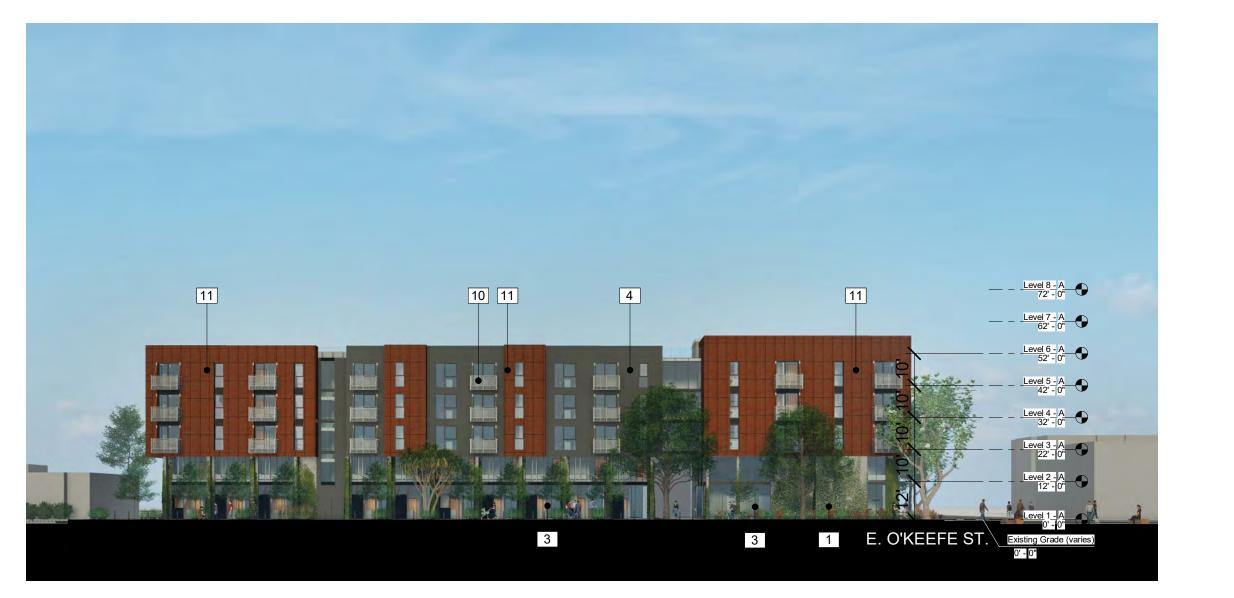

1 Euclid Ave. Elevation - West Building
1" = 30'-0"

# Woodland Park Euclid Improvements



# **David Baker Architects**

dbarchitect.com 461 Second St, Loft c127 San Francisco, CA 94107 415.896.6700

License Stamp

	Issuances
Description	Date
Entitlements Submission	09/25/2019

		Revisions
Rev.	Description	Date

Set Title

Application -September 2019


> **Drawing Title** BUILDING **ELEVATIONS**

> > Sheet No. A301

01-08-2021 Date Project No. 21620

# 5' - 7" 17' - 0" 13' - 0" 17' - 0" 13' - 0" 1/4" = 1'-0" 1/4" = 1'-0" 1/4" = 1'-0" 1 BR TOWNHOME - LEVEL 1 (BLDG A) 2 BR TOWNHOME - LEVEL 2 (BLDG A) 1 BR TOWNHOME - LEVEL 2 (BLDG A) 2 BR TOWNHOME - LEVEL 1 (BLDG A) 5

# Woodland Park Euclid Improvements

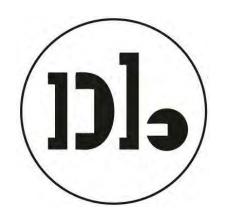

# **David Baker Architects**

dbarchitect.com 461 Second St, Loft c127 San Francisco, CA 94107 415.896.6700

License Stamp

	Issuances
Description	Date
Entitlements Submission	09/25/2019

		LACAISIONS
Rev.	Description	Date
1 R	esponse to Comments	11-20-202

### Set Titl

Application - September 2019

**Drawing Title** 

TYPICAL UNIT PLANS -BUILDING A

Sheet No

A400

# 38' - 0" 7' - 0" 7' - 0" 5' - 2" 5' - 2" 11' - 11" 10' - 0" 2' - 0" 11' - 11" 1/4" = 1'-0" TWO TYPICAL NESTED 1 BEDROOM UNITS (BLDG A) 17' - 4" 2' - 0" 10' - 0" 13' - 4" 10' - 3" 1' - 11 3/4" 9' - 8" 7' - 0" 1/4" = 1'-0" 3/16" = 1'-0" 2 BR - TYPICAL UPPER LEVELS (BLDG A) 5 STUDIO - TYPICAL UPPER LEVELS (BLDG A)

# Woodland Park Euclid Improvements



# **David Baker Architects**

dbarchitect.com 461 Second St, Loft c127 San Francisco, CA 94107 415.896.6700

License Stamp

	Issuances
Description	Date
Entitlements Submission	09/25/2019

		Revisions
Rev.	Description	Date
1 R	esponse to Comments	11-20-2020

Set Title

Application - September 2019


**Drawing Title** 

TYPICAL UNIT PLANS -BUILDING A

Sheet N

A401



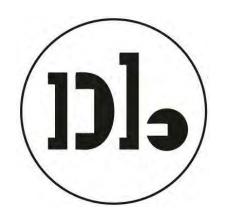

# David Baker Architects

dbarchitect.com 461 Second St, Loft c127 San Francisco, CA 94107 415.896.6700

License Stamp

	Issuances
Description	Date
Entitlements Submission	09/25/2019

			Revisions
Re	ev.	Description	Date
1	R	esponse to Comments	11-20-2020

Set Title

# Application - September 2019

**Drawing Title** 

TYPICAL UNIT PLANS -BUILDING B

Sheet No

A402

Project No. 2162	Date	01-08-202 <sup>2</sup>
	Project No.	21620





# **David Baker Architects**

dbarchitect.com 461 Second St, Loft c127 San Francisco, CA 94107 415.896.6700

License Stamp

	Issuances
Description	Date
Entitlements Submission	09/25/2019

			Revisions
Re	ev.	Description	Date
1 Response to Comments		esponse to Comments	11-20-2020

Set Title


Application - September 2019

Drawing Title


TYPICAL UNIT PLANS -BUILDING C

Sheet No

A403

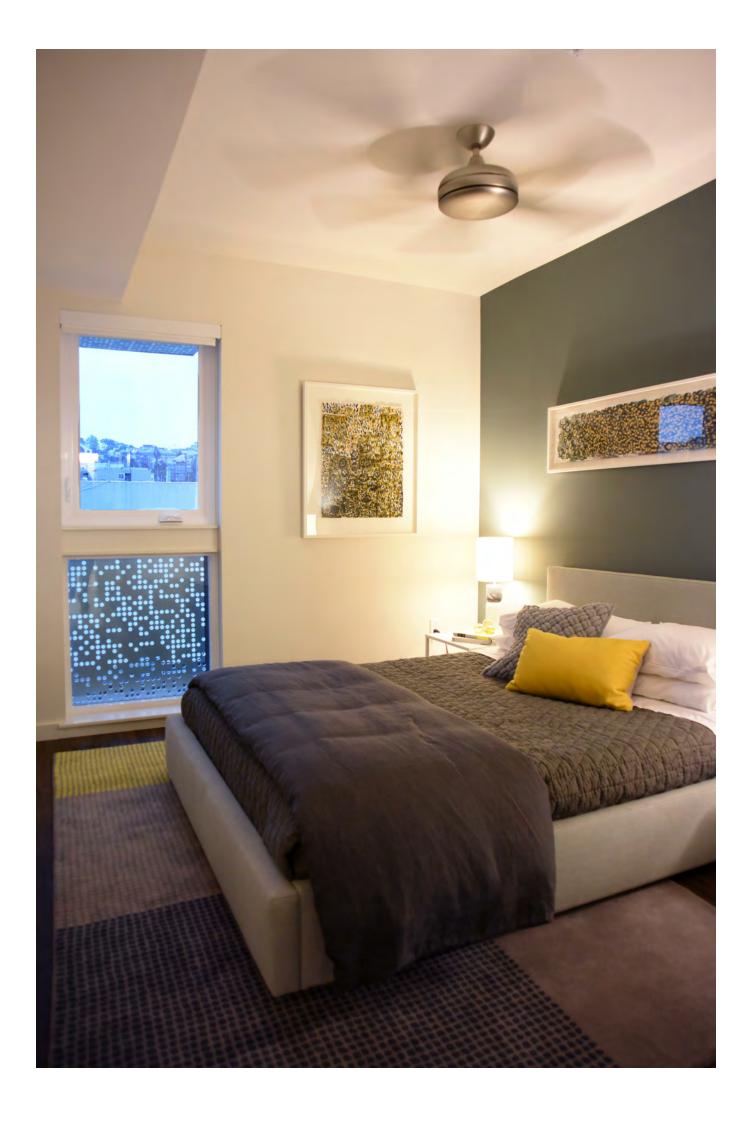


1 & 2 BR UNITS

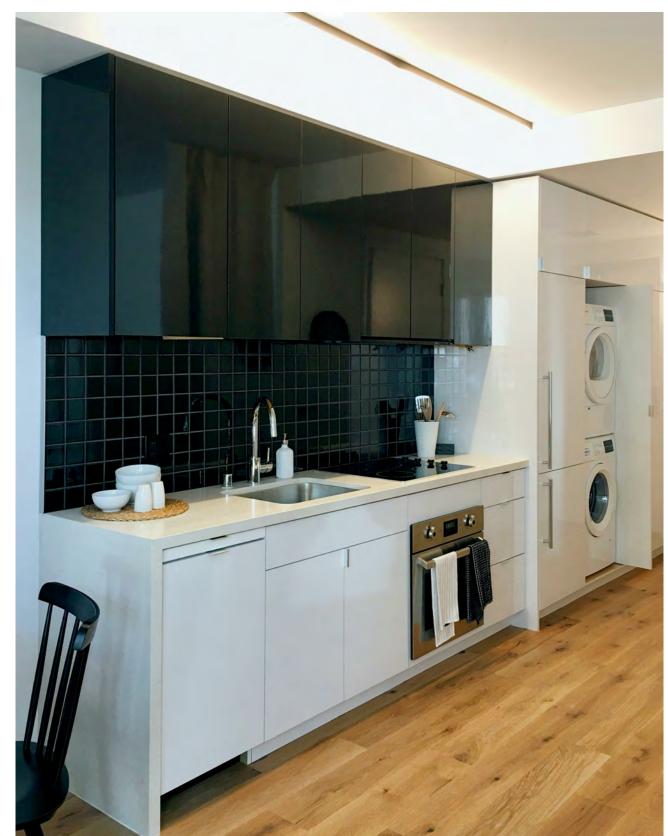



STUDIO UNITS

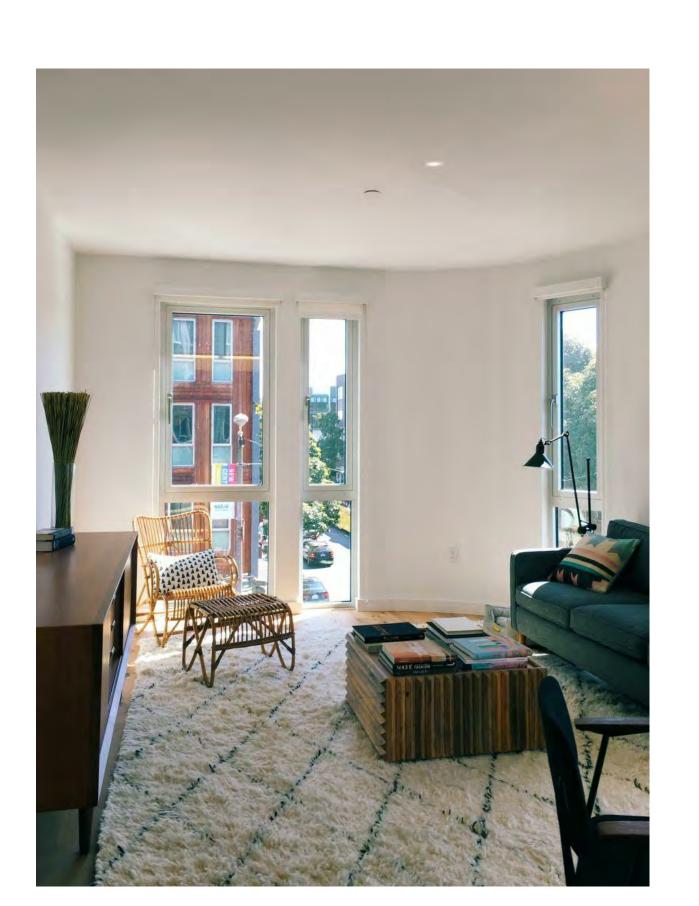



# **David Baker Architects**

dbarchitect.com 461 Second St, Loft c127 San Francisco, CA 94107 415.896.6700

License Stamp

	Issuances
Description	Date
Entitlements Submission	09/25/2019

		Revisions
Rev.	Description	Date
1 R	esponse to Comments	11-20-202

Set Title

Application - September 2019

**Drawing Title** 

UNIT **PRECEDENTS** 

A404

01-08-2021 21620 Date Project No.

# OPEN SPACE -COMMON OPEN SPACE -COMMON 1241 SF FLEX SPACE FLEX SPACE CORNER PARK OPEN SPACE -PUBLIC ENTRY PLAZA 9355 SF OPEN SPACE - PUBLIC 15169 SF OPEN SPACE -COMMON 2294 SF OPEN SPACE -— PUBLIC 3143 SF OPEN SPACE COMMON 1131 SF 1 LEVEL 1 PLAN - OPEN SPACE DIAGRAM

# EAST PALO ALTO DEVELOPMENT CODE 18.08.010:

Common Open Space. The land area within a residential or nonresidential development not individually owned or dedicated for public use and designed, intended, and reserved exclusively for the shared enjoyment or use by all the residents and their guests. Does not include enclosed spaces/facilities (e.g., community center, meeting rooms, etc.)

Private Open Space. An outdoor or unenclosed area directly adjoining and accessible to a dwelling unit, reserved for the exclusive private enjoyment and use of residents of the dwelling unit and their guests (e.g., balcony, deck, porch, terrace, etc.). Boundaries are evident through the use of fences, gates, hedges, walls, or other similar methods of controlling access and maintaining privacy.

Publicly Accessible / Usable Open Space. An outdoor or unenclosed area within a residential development on the ground, or on a roof, balcony, deck, porch or terrace, designed and accessible for outdoor living, active or passive recreation, pedestrian access, or landscaping. Parking facilities, driveways, utility or service areas and submerged land do not constitute usable open space.

# **OPEN SPACE - PROVIDED**

# **WEST PARCEL**

#### **COMMON:**

Level 1	OPEN SPACE - COMMON	13,402 SF
		13,402 SF

#### PRIVATE:

#### (BALCONIES)

•	,		
Level 3	OPEN SPACE - PRIVATE	15	720 SF
Level 4	OPEN SPACE - PRIVATE	15	720 SF
Level 5	OPEN SPACE - PRIVATE	15	720 SF
	·	15	0.400.05

## **EAST PARCEL**

#### COMMON:

OPEN SPACE - COMMON	12,851 SF
OPEN SPACE - COMMON	2,669 SF
	15,520 SF

# PRIVATE:

# (BALCONIES)

•	•		
Level 3	OPEN SPACE - PRIVATE	38	1,711 SF
Level 4	OPEN SPACE - PRIVATE	28	1,280 SF
Level 5	OPEN SPACE - PRIVATE	36	1,569 SF
Level 6	OPEN SPACE - PRIVATE	37	1,727 SF
Level 7	OPEN SPACE - PRIVATE	35	1,540 SF
Level 8	OPEN SPACE - PRIVATE	37	1,733 SF
Level 9	OPEN SPACE - PRIVATE	36	1,570 SF
Level 11	OPEN SPACE - PRIVATE	12	475 SF
Level 13	OPEN SPACE - PRIVATE	1	43 SF
		260	11,647 SF

# **USABLE / PUBLIC:**

Level 1	OPEN SPACE - PUBLIC	27,666 \$
		27.666 \$



HATCHED REGION INDICATES "FLEX" MULTIPURPOSE SPACE


# PROJECT TOTAL:

**TOTAL OPEN SPACE PROVIDED:** 15,562 sf + 54,833 sf = **70,395 SF TOTAL** 

- 9,355 SF OF WHICH IS PARK SPACE (COMMUNITY BENEFIT)

= 61,040 SF TOTAL OPEN SPACE (100 SF PER UNIT)

# Woodland Park **Euclid** Improvements

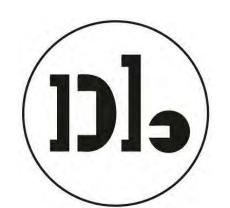

#### **David Baker Architects**

dbarchitect.com 461 Second St, Loft c127 San Francisco, CA 94107 415.896.6700

License Stamp

	Issuances
Description	Date
Entitlements Submission	09/25/2019

		Revisions	
Rev. Description		Date	
1 R	esponse to Comments	11-20-2020	

Application -September 2019

**Drawing Title** 

OPEN SPACE DIAGRAMS

A500

01-08-2021 21620 Project No.




1" = 40'-0"

2 LEVEL 3 PLAN - OPEN SPACE DIGRAM 1" = 30'-0"


COMMUNITY SPACES/NEIGHBORHOOD SERVING RETAIL




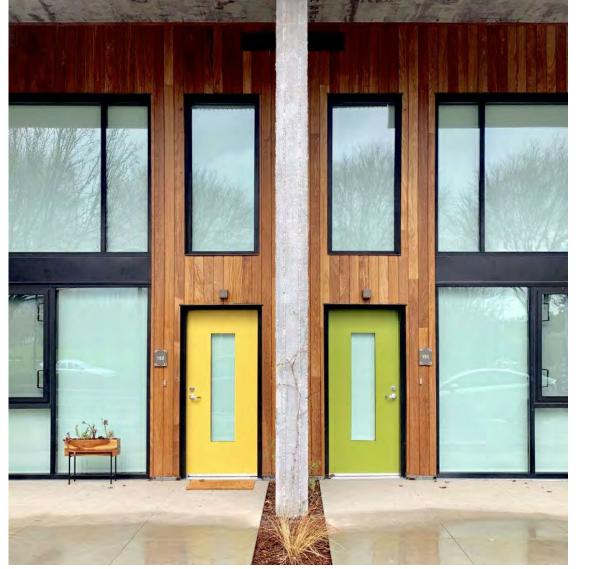




UNIT ENTRIES

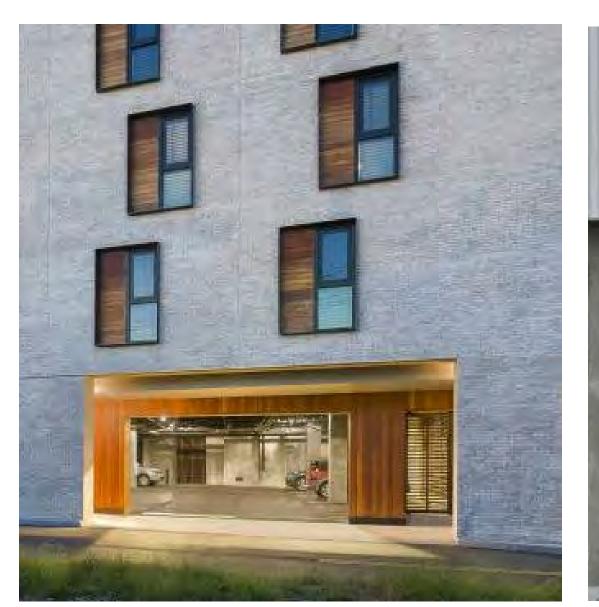

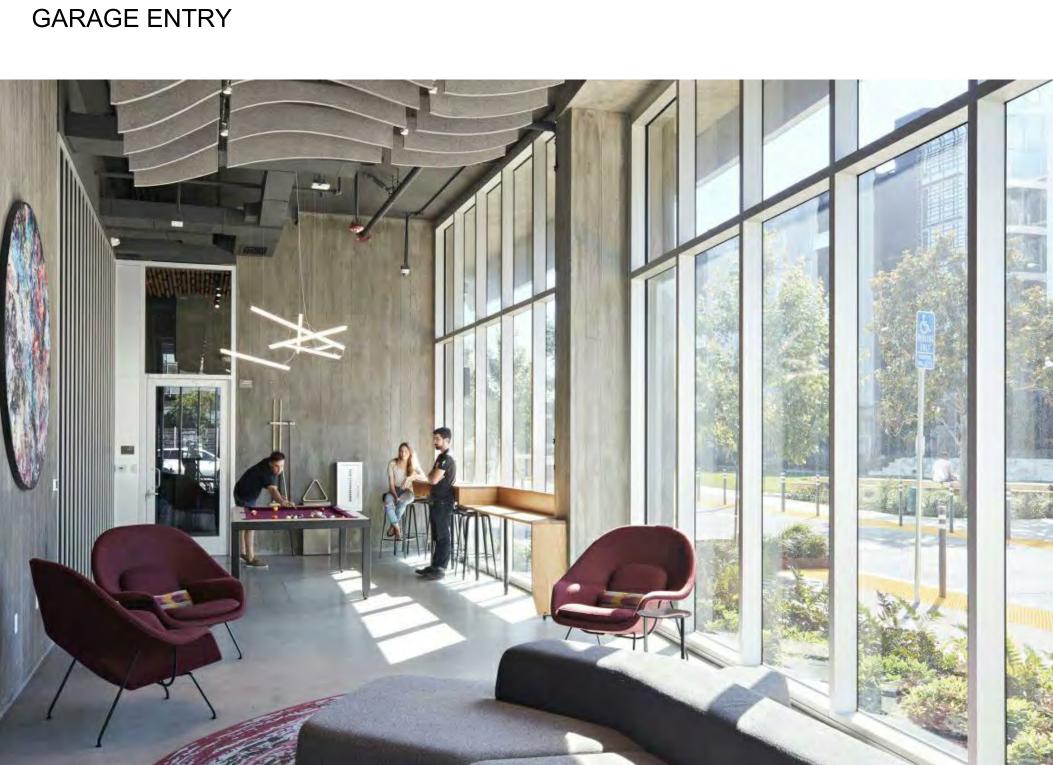

Woodland Park Euclid Improvements

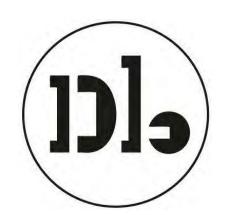

**David Baker Architects** 

dbarchitect.com 461 Second St, Loft c127 San Francisco, CA 94107 415.896.6700

License Stamp

	Issuances
Description	Date
Entitlements Submission	09/25/2019

	Revisions	
Rev.	Description	Date
1 R	esponse to Comments	11-20-2020

Set Title


Application -September 2019

Drawing Title

GROUND FLOOR CHARACTER

A501

01-08-2021 21620 Date Project No.

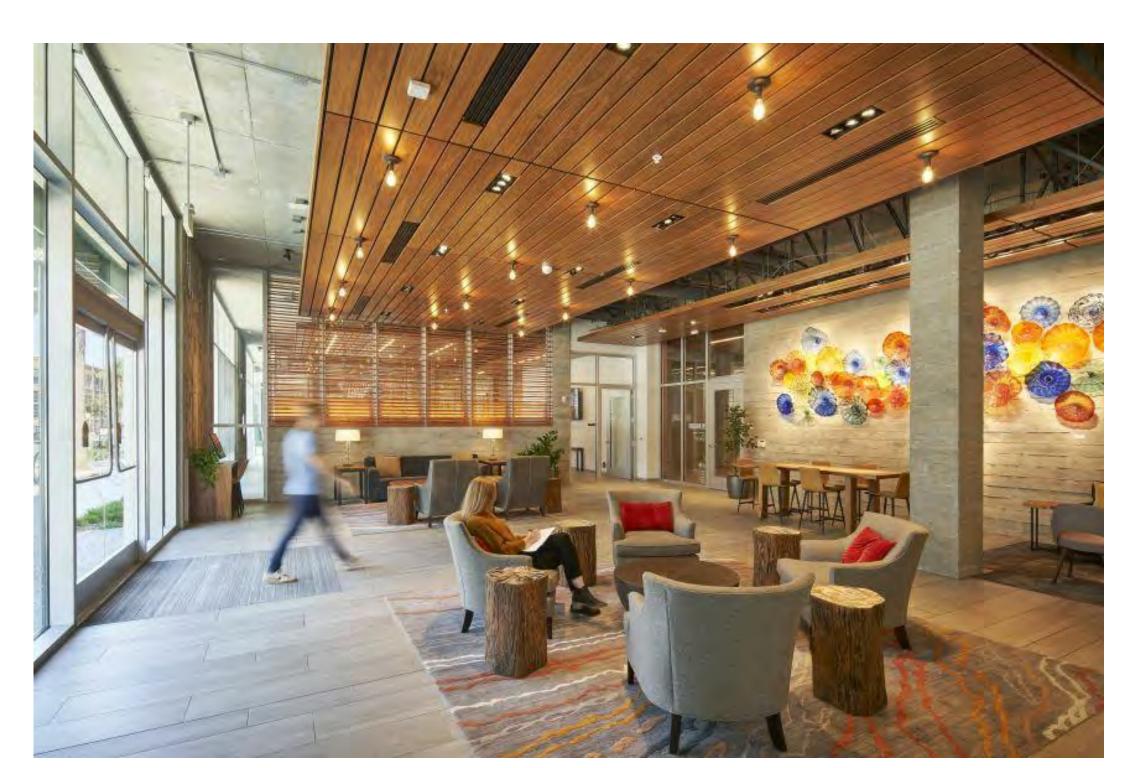

LOBBY



# LEGEND:

LEGEN						
PAVING DESCRIPTION /						
KEY	SYMBOL	DESCRIPTION / LOCATION				
P1		DECOMPOSED GRANITE				
P2	0000	GRAVEL				
РЗ		CIP CONCRETE				
P4		ASPHALT BLOCK PAVER				
P5		CIP COLORED CONCRETE				
P6		STONE PAVERS				
P7		ECO GRID PAVERS AT PARKING				
<u>FURNI</u>	SHINGS					
KEY	SYMBOL	DESCRIPTION / LOCATION				
F1		WOOD BENCH				
F2		PICNIC TABLE				
F3		BBQ GRILL				
F4		CUSTOM PLAY AND SEATING STRUCTURE				
F5		CURVED CONCRETE BENCH				
F6		GARDEN BED				
F7	o	BIKE RACK / BOLLARD				
PLANT	LIST					
TREES	TREES					
KEY	SYMBOL	COMMON NAME				
	And the second s	PROTECTED TREE				
FRAM		WHITE ASH				
ARMA	0	MARINA STRAWBERRY TREE				
		1				

PA PLANTING AREA

RED PUSH PISTACHE

KINDRED SPIRIT OAK

IRONWOOD

QUDO

QUKI

PAPE

# Woodland Park Euclid Improvements



**David Baker Architects** 

dbarchitect.com 461 Second St, Loft c127 San Francisco, CA 94107 415.896.6700



	Issuances
Description	Date
Entitlements Submission	09/25/2019

		LENBIOLIS
Rev.	Description	Date
	Decrease to Commente	10/05/2020

1 Response to Comments 10/05/2020

Set Title


Application -September 2019

**Drawing Title** 


Landscape Site Plan

L-1.0


25 September, 2019 Project No. 21620

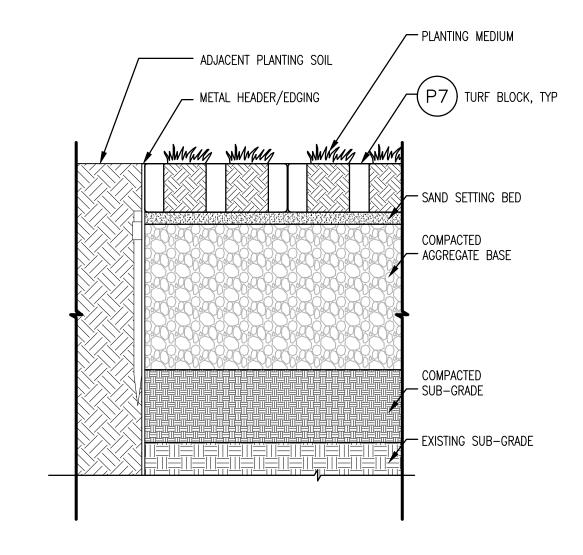

# 5 P7 - ECO-GRID PAVER AT PLANTING SCALE: 1-1/2" = 1' - 0"

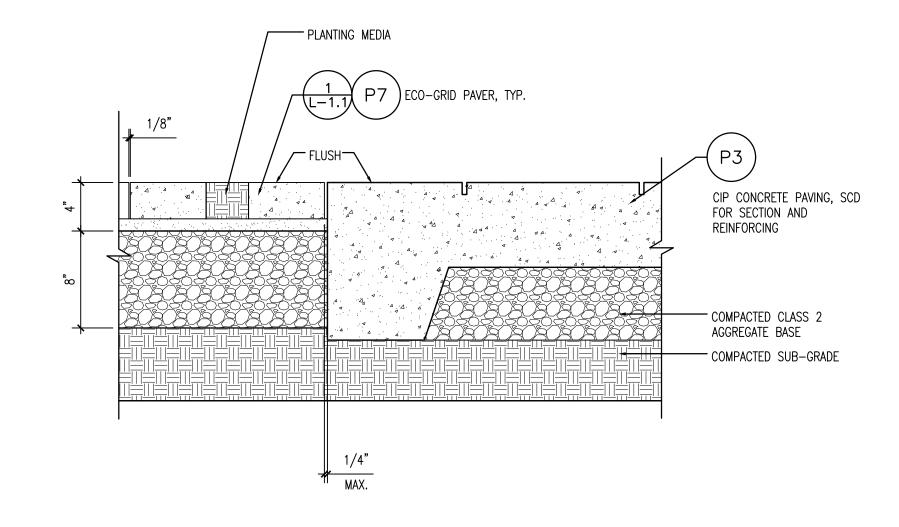

# 4 P7 - ECO-GRID PAVER AT CONCRETE PAVING SCALE: 1-1/2" = 1' - 0"

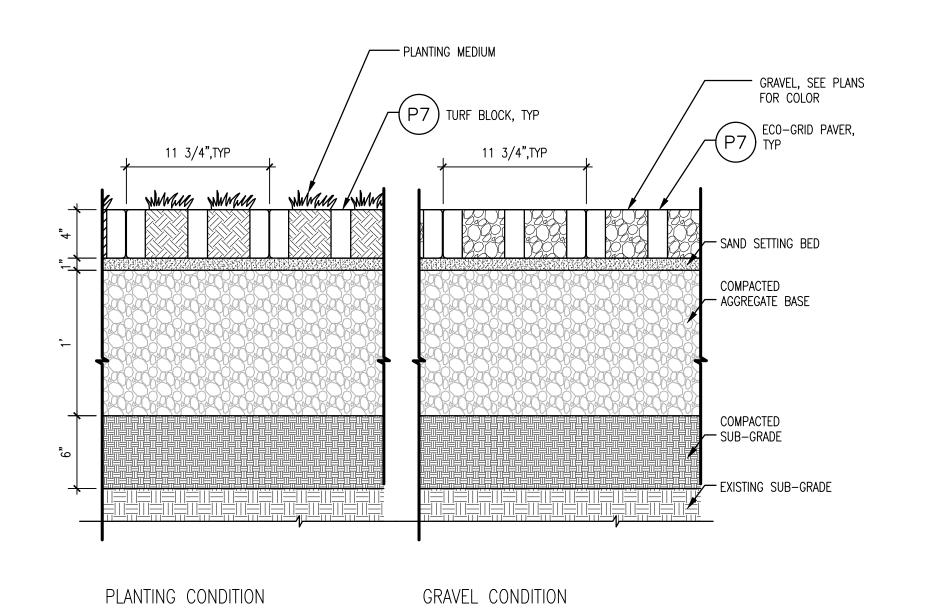











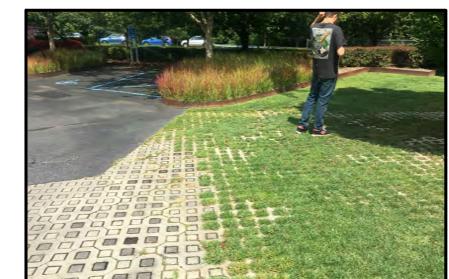







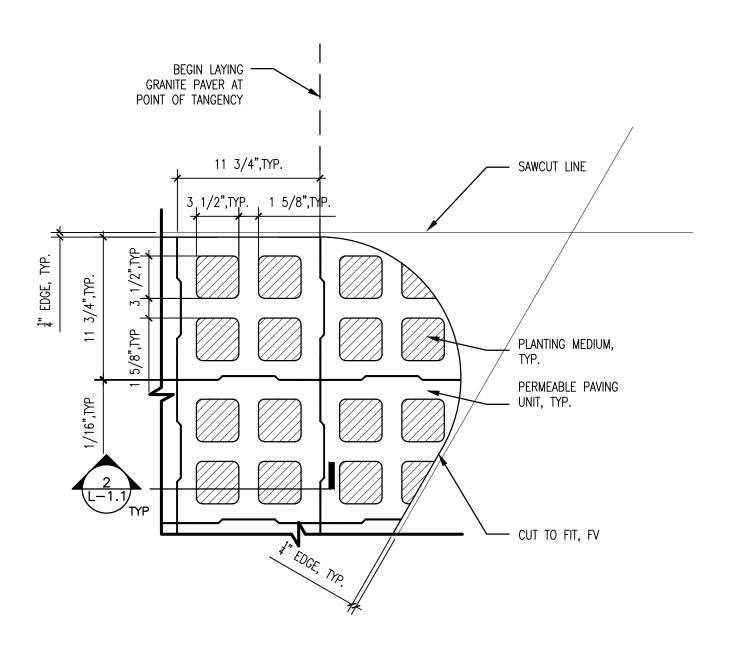

1 P7 - ECO-GRID PAVERS FOR FLEX PARKING AREA SCALE: 1-1/2" = 1' - 0"

# Woodland Park Euclid Improvements



David Baker Architects

dbarchitect.com

dbarchitect.com 461 Second St, Loft c127 San Francisco, CA 94107 415.896.6700



HOOD DESIGN STUDIO, Inc.
3016 FILBERT street
studio 2
DAKLAND, CA 94608
510 . 595 0688
www.hooddesignstudio.com


	Issuances
Description	Date
Entitlements Submission	09/25/2019

		Revisions
Rev.	Description	Date

1 Response to Comments 10/05/2020

Set Title

Application - September 2019

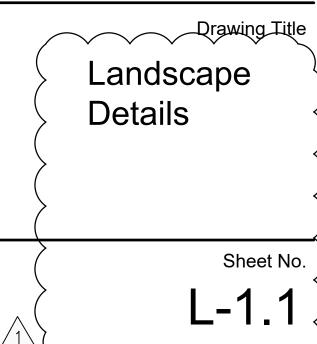

Date 25 September, 2019 Project No. 21620

#### GENERAL NOTES

- 1. ALL TREE REMOVAL WORK SHALL BE PERFORMED IN CONFORMANCE WITH APPLICABLE LOCAL CODES AND ORDINANCES.
- 2. ALL ADDITIONAL REQUIREMENTS FOR TREE PROTECTION AND MITIGATION AS REQUIRED BY THE CITY ARBORIST AND THE PROJECT ARBORIST SHALL BE FOLLOWED. REFERENCE CITY OF SANTA CLARA ARBORIST NOTES AND PROJECT ARBORIST NOTES.
- 3. CONTRACTOR SHALL VISIT THE SITE WITH OWNER'S REPRESENTATIVES PRIOR TO BEGINNING ANY WORK. VERIFY ALL TREES, SHRUBS & VEGETATION WITHIN THE LIMITS OF WORK TO BE REMOVED AND ALL TREES & PLANTS TO REMAIN AND TO BE PROTECTED.
- 4. ALL TREES AND PLANTS DESIGNATED TO REMAIN SHALL BE PROTECTED FROM PHYSICAL DAMAGE AND MAINTAINED THROUGHOUT THE DURATION OF THE CONTRACT. THOSE TREES AND PLANTS INDICATED TO BE REMOVED SHALL BE COMPLETELY REMOVED, INCLUDING THE ROOTS, AND DISPOSED OF OFF-SITE. BACKFILL EXCAVATED AREAS TO RESTORE TO EXISTING GRADE.
- 5. PROTECTIVE FENCING: TEMPORARY FENCES OR BARRICADES SHALL BE INSTALLED AS SHOWN ON THE DRAWINGS OR AS DIRECTED IN THE FIELD BY THE PROJECT ARBORIST OR THE OWNER'S REPRESENTATIVE. FENCING SHALL BE A MINIMUM OF SIX (6) FOOT HEIGHT, CHAIN LINK. MAINTAIN FENCING IN CONTINUOUS, STABLE AND UPRIGHT CONDITION AT ALL TIMES.
- 6. CONTRACTOR SHALL REMOVE FROM THE SITE ALL DEBRIS AND UNSUITABLE MATERIAL GENERATED FROM CONSTRUCTION AND DISPOSE OF IN A LAWFUL MANNER.

#### PROJECT ARBORIST NOTES

1. THE TREE PRESERVATION GUIDELINES ARE SUPERSEDED BY THE CITY OF SANTA CLARA ARBORIST NOTES INCLUDED IN THE DOCUMENTS PROVIDED. THIS INCLUDES CITY TREE DAMAGE PENALTIES IN THE CASE THAT TREES DIE OR ARE DAMAGED DUE TO FAILURE TO PROVIDE ADEQUATE PROTECTIONS. CITY REQUIRES THAT ARBORIST SUPERVISION OF PROJECT TREE PROTECTION BE CONDUCTED BY CITY ARBORIST OR ARBORIST EMPLOYED BY CITY.

2. THESE GUIDELINES PROVIDE FOR THE CARE AND MAINTENANCE OF THE TREE(S) BEFORE, DURING AND AFTER CONSTRUCTION ACTIVITIES. THE GOAL OF TREE PROTECTION AND PRESERVATION IS TO PROVIDE FOR A SUCCESSFUL TRANSITION TO A MODIFIED SITE.

3. TO BE MOST EFFECTIVE, TREE PRESERVATION AND HEALTH MITIGATION MEASURES MUST COMMENCE WELL BEFORE THE TIME OF DISTURBANCE AS HEALTHY TREES ARE MORE LIKELY TO SURVIVE ADVERSE IMPACTS.

4. TO BE EFFECTIVE, PROJECT ARBORIST MUST HAVE THE ABILITY TO ASSURE THE GUIDELINES ARE OBSERVED AND HAVE THE ABILITY TO HALT ALL CONSTRUCTION ACTIVITIES IF TRANSGRESSIONS OCCUR.

5. PROJECT CONSTRUCTION DOCUMENTS MUST ACCURATELY SHOW TREE PROTECTION AREAS AND SPECIFY PROTOCOL AND PROCEDURES TO BE USED FOR ALL ACTIVITIES WITHIN THE DESIGNATED TREE PROTECTION AREA.

#### SITE ANALYSIS AND EARLY TREE HEALTH MITIGATION

6. THE INFORMATION GAINED FROM SITE ANALYSIS IS UTILIZED FOR ROOT AND SOIL PROTECTION AND TO ASSURE THAT ADEQUATE MITIGATION TREATMENTS ARE

7. SOIL PROFILE EXAMINATION – THE SOIL PROFILE EXAMINATION DETERMINES SOIL TEXTURE AND MOISTURE LEVELS. SOIL COMPACTION IS ALSO ASSESSED. THIS INFORMATION IS VITAL TO THE UNDERSTANDING OF THE LEVEL OF SOIL PROTECTION AND MITIGATION THAT WILL BE NECESSARY.

8. LABORATORY ANALYSIS - ANALYSIS OF SOIL AND PLANT TISSUE SAMPLES CAN HELP GUIDE THE USE OF SOIL AMENDMENTS AND FERTILIZATION.

9. ROOT INVESTIGATION - UNDERSTANDING THE DEPTH, SIZE AND AMOUNT OF ROOTS PRESENT IS REQUIRED TO HELP GUIDE PROJECT DESIGN AND ANTICIPATE WHEN A TREE IS UNLIKELY TO SURVIVE.

10. MITIGATION OF LIMITATIONS IDENTIFIED - LIMITATIONS IDENTIFIED DURING SITE ANALYSIS ACTIVITIES ARE BEST MITIGATED PRIOR TO THE BEGINNING OF CONSTRUCTION ACTIVITIES. POSSIBLE LIMITATIONS TO BE MITIGATED INCLUDE SOIL COMPACTION, NUTRITIONAL DEFICIENCIES AND INSUFFICIENT OR EXCESS SOIL MOISTURE. MOST BASIC MITIGATION ENTAILS: IRRIGATION, MULCHING, WATER JET AND AIR SPADE PROCEDURES. SOIL AMENDMENTS OTHER THAN GOOD QUALITY MULCH MUST BE BASED UPON LABORATORY SOIL AND/OR TISSUE ANALYSIS.

#### PRE-CONSTRUCTION ACTIVITIES

11. THESE ACTIVITIES SHOULD BE UNDERTAKEN PRIOR TO INITIATION OF CONSTRUCTION ACTIVITY

12. MULCHING – USE OF GOOD QUALITY ORGANIC MULCH (WOOD CHIPS ARE BEST) ON SOIL SURFACE HELPS TO REDUCE SOIL COMPACTION AND RETAIN SOIL MOISTURE. RECOMMENDED MATERIAL IS WOOD CHIPS GENERATED FROM TREE TRIMMING. FRESH REDWOOD, INCENSE CEDAR AND WALNUT CHIPS ARE NOT ACCEPTABLE, NOR IS PALM GENERATED MULCH.

13. CROWN PRUNING -PRUNING MUST COMPLY WITH ANSI A300 PRUNING STANDARDS. PRUNING PRIOR TO CONSTRUCTION SHOULD INCLUDE: NECESSARY CLEARANCE PRUNING, DEADWOOD REMOVAL AND SAFETY PRUNING.

14. CONSTRUCTION DOCUMENTS TO SHOW PROTECTED TREES AND TREE PROTECTION REQUIREMENTS - PROJECT PLANS TO SHOW ALL TREE PROTECTION FENCING LAYOUT, AREAS OF ENCROACHMENT AND LIST PROCEDURES FOR WORKING AROUND PROTECTED TREES.

15. DESIGNATION OF TREE ROOT PROTECTION ZONE (RPZ) - CITY OF SANTA ROSA ARBORIST NOTES DESIGNATES THE "TREE PROTECTION ZONE AS 1.5 TIMES THE RADIUS OF THE DRIP LINE". THE TREE ROOT PROTECTION ZONE DESIGNATES AN AREA SURROUNDING A TREE OR GROUPING OF TREES THAT IS TO BE FENCED OFF FROM ALL ACCESS. NO MATTER THE RADIUS OF THE DRIP ZONE, THE RPZ IS NOT TO BE LESS THAN ONE (1) FOOT RADIAL DISTANCE FROM THE BASE OF THE TREE FOR EVERY ONE (1) INCH IN TREE DIAMETER. A TREE WITH A 10 INCH DIAMETER WOULD HAVE A MINIMUM RPZ EQUAL TO 10 FEET OUT FROM THE TREE. PROJECT ARBORIST CAN MODIFY THE RPZ DISTANCE BASED UPON PHYSICAL EVIDENCE OF ROOT PRESENCE OR ABSENCE.

16. TREE ROOT PROTECTION ZONE FENCING - FENCING IS TO BE CHAIN-LINK TYPE METAL FENCING WITH METAL POSTS DRIVEN TWO-FEET INTO THE SOIL. SIGNS SHALL BE ATTACHED TO TREE PROTECTION FENCING EVERY 20' WHICH READ "TREE PROTECTION ZONE DO NOT ENTER".

17. PROCEDURES AND TREATMENTS FOR WORK ACTIVITIES THAT MUST OCCUR INSIDE OF THE RPZ - ALL SUCH ACTIVITIES AND RELOCATION OF FENCING MUST BE OVERSEEN BY PROJECT ARBORIST. SPECIAL TRUNK, SCAFFOLD AND SOIL PROTECTION MEASURES ARE REQUIRED. WHEN ENCROACHMENT IS ANTICIPATED PRIOR TO THE BEGINNING OF CONSTRUCTION ACTIVITIES, THE PROTECTIONS MUST BE IN PLACE PRIOR TO BEGINNING WORK ACTIVITIES.

18. ARBORIST REVIEW AND APPROVAL OF TREE PROTECTION MEASURES - PROJECT ARBORIST EMPLOYED BY THE CITY OF SANTA CLARA TO REVIEW TREE PROTECTION GUIDELINES AND MODIFY AS DEEMED NECESSARY.

19. TREE PROTECTIONS INSTALLATION AND INSPECTED - PROJECT ARBORIST MUST CERTIFY THAT ALL TREE PROTECTION MEASURES HAVE BEEN PROPERLY

20. PRE-CONSTRUCTION MEETING – CITY EMPLOYED PROJECT ARBORIST TO MEET WITH CONSTRUCTION SUPERVISOR AND WORK CREW TO REVIEW REQUIREMENTS OF THE TREE PROTECTION. ALL PERSONNEL WORKING ON SITE MUST BE PROVIDED AN ORIENTATION TO THE TREE PRESERVATION REQUIREMENTS. NO CONSTRUCTION ACTIVITIES MAY BEGIN UNTIL THIS MEETING HAS BEEN CONDUCTED.

21. PROJECT ARBORIST CAN DIRECT THAT ALL WORK ACTIVITIES STOP IF TREE PROTECTION GUIDELINES ARE NOT BEING FOLLOWED. ALL WORK ACTIVITIES CEASE UNTIL SUCH TIME AS THE PROBLEM HAS BEEN CORRECTED.

22. WORK ACTIVITIES THAT ENCROACH INTO THE DESIGNATED RPZ

TRENCHING PLATES OR 1 1/8 INCH PLYWOOD PLACED ON TOP.

ARBORIST SUPERVISION – ALL ACTIVITIES OCCURRING WITHIN THE DESIGNATED RPZ MUST BE UNDER DIRECT SUPERVISION OF PROJECT ARBORIST. ENCROACHMENT IS NOT PERMITTED UNTIL ALL ADDITIONAL PROTECTIONS ARE IN PLACE AND HAVE BEEN APPROVED.

23. SOIL AND ROOT PROTECTION -THE EFFECTS OF FOOT TRAFFIC CAN BE MITIGATED THROUGH THE USE OF SIX (6) INCHES OF WOOD CHIP MULCH AND ¾ INCH PLYWOOD PLACED ON TOP. PROTECTIONS FOR EQUIPMENT OPERATING WITHIN THE DESIGNATED RPZ REQUIRES 12 INCHES OF MULCH WITH EITHER METAL

24. TRUNK AND SCAFFOLD PROTECTION – WHENEVER CONSTRUCTION ACTIVITY MUST OCCUR INSIDE THE TREE PROTECTION ZONE. THE BASE OF THE TREE AND THE FIRST EIGHT-FEET AND EXPOSED SCAFFOLD LIMBS MUST BE ARMORED. PROTECTION IS GENERALLY PROVIDED BY WRAPPING THE TRUNK WITH STRAW WADDLES COVERED WITH ORANGE PLASTIC CONSTRUCTION FENCING. EXPOSED SCAFFOLD LIMBS ARE BEST PROTECTED BY STRAPPING 2X4 BOARDS TO THE PART EXPOSED TO POTENTIAL INJURY AND WRAPPING WITH ORANGE PLASTIC FENCING MATERIAL.

25. REQUIRED METHOD OF EXCAVATION WITHIN CRITICAL ROOT ZONE - WHEREVER POSSIBLE, ROUTE UTILITIES OUTSIDE OF THE DESIGNATED RPZ. TUNNELING IS THE PREFERRED METHOD FOR UTILITIES PASSING THROUGH THE RPZ. WHEN TRENCHING IS REQUIRED, CAREFULLY HAND EXCAVATION OR THE USE OF THE AIR SPADE OR DITCH WITCH IS REQUIRED. PROJECT ARBORIST MUST APPROVE AND SUPERVISE ALL SUCH ACTIVITY.

26. NECESSARY ROOT PRUNING – LATE FALL SEASON IS THE BEST TIME FOR ROOT PRUNING. SPRING CAN BE THE MOST HARMFUL AT THIS IS THE TIME OF GREATEST MOISTURE NEEDS. ALL NECESSARY ROOT PRUNING IS CONDUCTED BY PROJECT ARBORIST AFTER THE ROOTS HAVE BEEN EXPOSED WITHOUT DAMAGE.

27. POST CONSTRUCTION MITIGATION ARBORIST DESIGNATION OF HEALTH MITIGATION ACTIVITIES – PROJECT ARBORIST WILL DESIGNATE TREE HEALTH MITIGATION ACTIVITIES BASED UPON THE LEVEL OF ROOT LOSS AND ADVERSE IMPACTS THAT HAVE OCCURRED.

28. MONITORING TREE HEALTH - TREES THAT HAVE BEEN ADVERSELY IMPACTED BY CONSTRUCTION ACTIVITIES ARE NOTED FOR REGULAR VISUAL INSPECTION. PROJECT ARBORIST WILL DIRECT FURTHER MITIGATION. INSECTS AND FUNGAL PATHOGENS ARE A SIGN OF POOR TREE HEALTH (LOW ENERGY RESERVES) AND INDICATE THE NEED FOR HEALTH MITIGATION.

29. MONITORING OF SOIL MOISTURE – MOISTURE SHOULD BE MONITORED BY VISUAL INSPECTION USING A SOIL PROBE OR THROUGH THE USE OF TENSIOMETERS PLACED AT KEY LOCATIONS AND DEPTHS. SUPPLEMENTAL IRRIGATION IS MOST NEEDED DURING SPRING. IN CASES WHERE TREES HAVE SUFFERED ROOT LOSS, SUPPLEMENTAL IRRIGATION MAY BE REQUIRED FOR A NUMBER OF YEARS.

30. MITIGATION OF SOIL COMPACTION - THE LEVEL AND DEPTH OF SOIL COMPACTION MUST BE ASSESSED AND MITIGATED AS NECESSARY. TOOLS THAT ARE MOST SUITABLE FOR MITIGATION OF COMPACTED SOIL ARE THE WATER JET OR AIR SPADE.

31. LANDSCAPING – ALL LANDSCAPING PLANNING MUST TAKE PRECAUTIONS WHEN PLANTING WITHIN THE DESIGNATED RPZ. ALL PLANT MATERIALS SHOULD BE SELECTED FOR COMPATIBILITY WITH THE FAVORED MOISTURE REGIME (HYDROZONE) OF THE TREE SPECIES AND SOIL TEXTURE.

32. CONTINUED MULCHING - MULCH IS EXTREMELY BENEFICIAL IN CREATING A HEALTHY ROOT ENVIRONMENT. A REGULAR PROGRAM OF MULCH APPLICATION IS RECOMMENDED TO HELP RETAIN SOIL MOISTURE, PROVIDE A SOURCE OF NUTRIENTS, AND HELP CONTROL WEEDS.

33. FERTILIZATION -TREES SHOULD BE FERTILIZED ONLY WHEN THE NUTRITIONAL LIMITATIONS HAVE BEEN IDENTIFIED THROUGH LABORATORY ANALYSIS OF SOIL OR PLANT TISSUE. EXCESSIVE NITROGEN FERTILIZATION IS KNOWN TO DRAW SUCKING INSECTS (APHID, SCALE, ETC.) TO THE PLANTS AND PROVIDE NUTRITION TO FUNGAL PATHOGENS IN THE SOIL. PEST MANAGEMENT PROGRAM – HEALTHY TREES DO NOT GENERALLY HAVE SERIOUS PEST PROBLEMS. STRESSED TREES BECOME ATTRACTIVE HOSTS TO PATHOGENS WHICH CAN CONTRIBUTE TO FURTHER DECLINE. PEST MANAGEMENT IS PRESCRIBED WHEN MONITORING INDICATES A

34. ENFORCEMENT OF TREE PROTECTION - CITY OF SANTA CLARA ARBORIST NOTES LIST PENALTIES FOR FAILURE TO COMPLY WITH PROTECTION AND MAINTENANCE OF TREES DESIGNATED TO BE RETAINED.

1. ALL PLANTS DESIGNATED TO BE SAVED SHALL BE PROTECTED BY FENCING, AS 2. INSTALL TREE PROTECTION FENCE AT TREE DRIP LINE OR AT EDGE OF DISTURBED AREA, AS SHOWN ON PLANS, PRIOR TO COMMENCEMENT OF CONSTRUCTION. 3. SPACE TREE PROTECTION ZONE SIGNS A MINIMUM OF ONE EVERY 300 FEET. THE SIZE OF EACH SIGN MUST BE A MINIMUM OF 2' x 2' AND BE VISIBLE FROM BOTH SIDES OF THE SIGN MUST CONTAIN THE FOLLOWING LANGUAGE IN BOTH ENGLISH & SPANISH: "TREE PROTECTION ZONE, KEEP OUT". 3. THERE SHALL BE NO STORAGE OF MATERIAL WITHIN THE BOUNDARIES OF THE TREE PROTECTION FENCING. 4. TREE PROTECTION FENCING SHALL BE MAINTAINED THROUGHOUT THE DURATION OF THE - ATTACH SIGN TO POST — FENCE MATERIAL: ORANGE, UV RESISTANT HIGH TENSILE STRENGTH POLYETHYLENE LAMINAR BARRICADE FABRIC GRADE 4'-0" 1.33 LBS/LF STEEL POST MINIMUM: PLACE FENCE AT DRIP LINE; WHERE POSSIBLE, EXTEND TO LIMIT OF AREA OF DISTURBANCE OR FUTURE BUILDING EDGE

		PROTECTE				REPLACEMENT TR	EES	
	NAME	SPECIES	TRUNK DIAMETER (IN)	PRESERVED (Y/N)	PROTECTED TRE TO BE REMOVE		SIZE	QTY
	860	OLEANDER	9	(1/N) Y	TO BE REMOVE			
	861	OLEANDER	18					
	863	OLEANDER	7	N	863	BLUE OAK	24" BOX	2
	870	CALIFORNIA BLACK WALNUT	14/	\\\\\\\\\\\\\\\\\\\\\\\\\\\\\\\\\\\\\\	870	RINDRED SPIRIT OAK	24° 80×	<u>_2</u> ^
	871	DEODAR CEDAR	36	Y				
	872	ENGLISH WALNUT	8	Y				
	873	BOXELDER	8	Y				
	874	DEODAR CEDAR	40	Y				
	875 876	AVOCADO JAPANESE MAPLE	14 9, 6, 5	Y				
			7, 4, 4, 4, 4,					
	877	JAPANESE MAPLE	4, 4	Y				
	878	COAST REDWOOD	35	Y				
	879 880	SAUCER MAGNOLIA ORANGE	15, 10	Y	880	KINDRED SPIRIT OAK	04" DOV	2
	881	AVOCADO	14 26	N N	880	BLUE OAK	24" BOX 24" BOX	2 2
	882	BLACKWOOD ACACIA	21	N	882	BLUE OAK	24 BOX 24" BOX	2
	883	BLACKWOOD ACACIA	16	N	883	BLUE OAK	24" BOX	2
	885	GLOSSY PRIVET	15	N	885	BLUE OAK	24" BOX	2
	886	AUSTRALIAN BUSH CHERRY	7, 6, 5, 5	N	886	BLUE OAK	24" BOX	2
	887	AUSTRALIAN BUSH	14	N	887	BLUE OAK	24" BOX	2
		CHERRY AUSTRALIAN BUSH			/			
	888	CHERRY	14	N	888	BLUE OAK	24" BOX	2
	890	AUSTRALIAN BUSH CHERRY	7	N	890	BLUE OAK	24" BOX	2
	004	WEEPING BOTTLE	1/1 6		( 004			
	891	BRUSH	14, 6	N	891	BLUE OAK	24" BOX	2
	896	ENGLISH WALNUT	17	N	896	BLUE OAK	24" BOX	2
	897 899	ORANGE CHERRY	13	Y				
	900	ENGLISH WALNUT	17	Y				
	901	ORANGE	7	Υ				
	902	CHINESE ELM	24	Y				
$\overline{}$	903	CHINESE ELM	26	Y	004	BILLE ON		
,	904	MONTERREY PINE RAYWOOD ASH	34 7	N N	904	BLUE OAK BLUE OAK	24" BOX 24" BOX	2 2
	907	RAYWOOD ASH	10, 12	Y	7 303	BLOL OAK	24 DUX	
)	908	RAYWOOD ASH	11	Y				
_	910	RAYWOOD ASH	9	Y				
-	911	RAYWOOD ASH	10	Y				
)	912 913	PLUM BOXELDER	30 20	Y				
J	914	BOXELDER	20	Y				
)	915	BOXELDER	31	Y				
	916	TULIP TREE	24	Y				
	917	COAST LIVE OAK	17	N Y	917	BLUE OAK	24" BOX	2
	920	ITALIAN CYPRESS ITALIAN CYPRESS	14 11	Y	-			
(	922	ITALIAN CYPRESS	12	Y				
,	923	PLUM	12, 8	Y				
<u>-</u>	924	APPLE	15	Y				
	926	PLUM	13	Y	000	DITIE OVA	04" 504	
T )	928 929	CABBAGE PALM RIVER RED GUM	11, 9 32	N N	928	BLUE OAK BLUE OAK	24" BOX 24" BOX	2 2
ר ר	931	SILVER DOLLAR GUM	21	N N	931	BLUE OAK	24 BOX 24" BOX	2
	932	RIVER RED GUM	36	N	932	BLUE OAK	24" BOX	2
	937	RIVER RED GUM	24	N	937	BLUE OAK	24" BOX	2
7	938	CABBAGE PALM	50	Y		DILIE OVI	0.4" = 5.1	
	939	SOUTHERN MAGNOLIA	30	N	939	BLUE OAK	24" BOX	2
	940 941	COAST LIVE OAK COAST LIVE OAK	27 26	Y	-			
	941	SOUTHERN MAGNOLIA	26	Y	-			
	943	SOUTHERN MAGNOLIA	23	Y				
	944	COAST REDWOOD	30	Y				
	947	VICTORIAN BOX	17, 15	Y				
<u> </u>	948	PŁOM	15		EVIDA IDEEC	DITIE OVA	04" 500	$\sim$
	-	OTAL PROTECTED TO	ES DEMOVED	24	EXTRA TREES	BLUE OAK ES REQUIRED REPLACED	24" BOX	9
	ı I	OTAL PROTECTED TRE	ES KEINIOVED	21	IOIAL IRE	TO UTMOILED KELTACED	(1.7/11/0 1.2)	42

PROTECTED TREE AND REPLACEMENT TREE LISTS



David Baker Architects

dbarchitect.com 461 Second St, Loft c127 San Francisco, CA 94107 415.896.6700



3016 FILBERT street

Issuances Date Description Entitlements Submission 09/25/2019

Revisions Date Rev. Description

1 Response to Comments 10/05/2020


Set Title

Application -September 2019

Drawing Title

Tree Protection and Removals LIst and Notes

25 September, 2019 Date 21620 Project No.

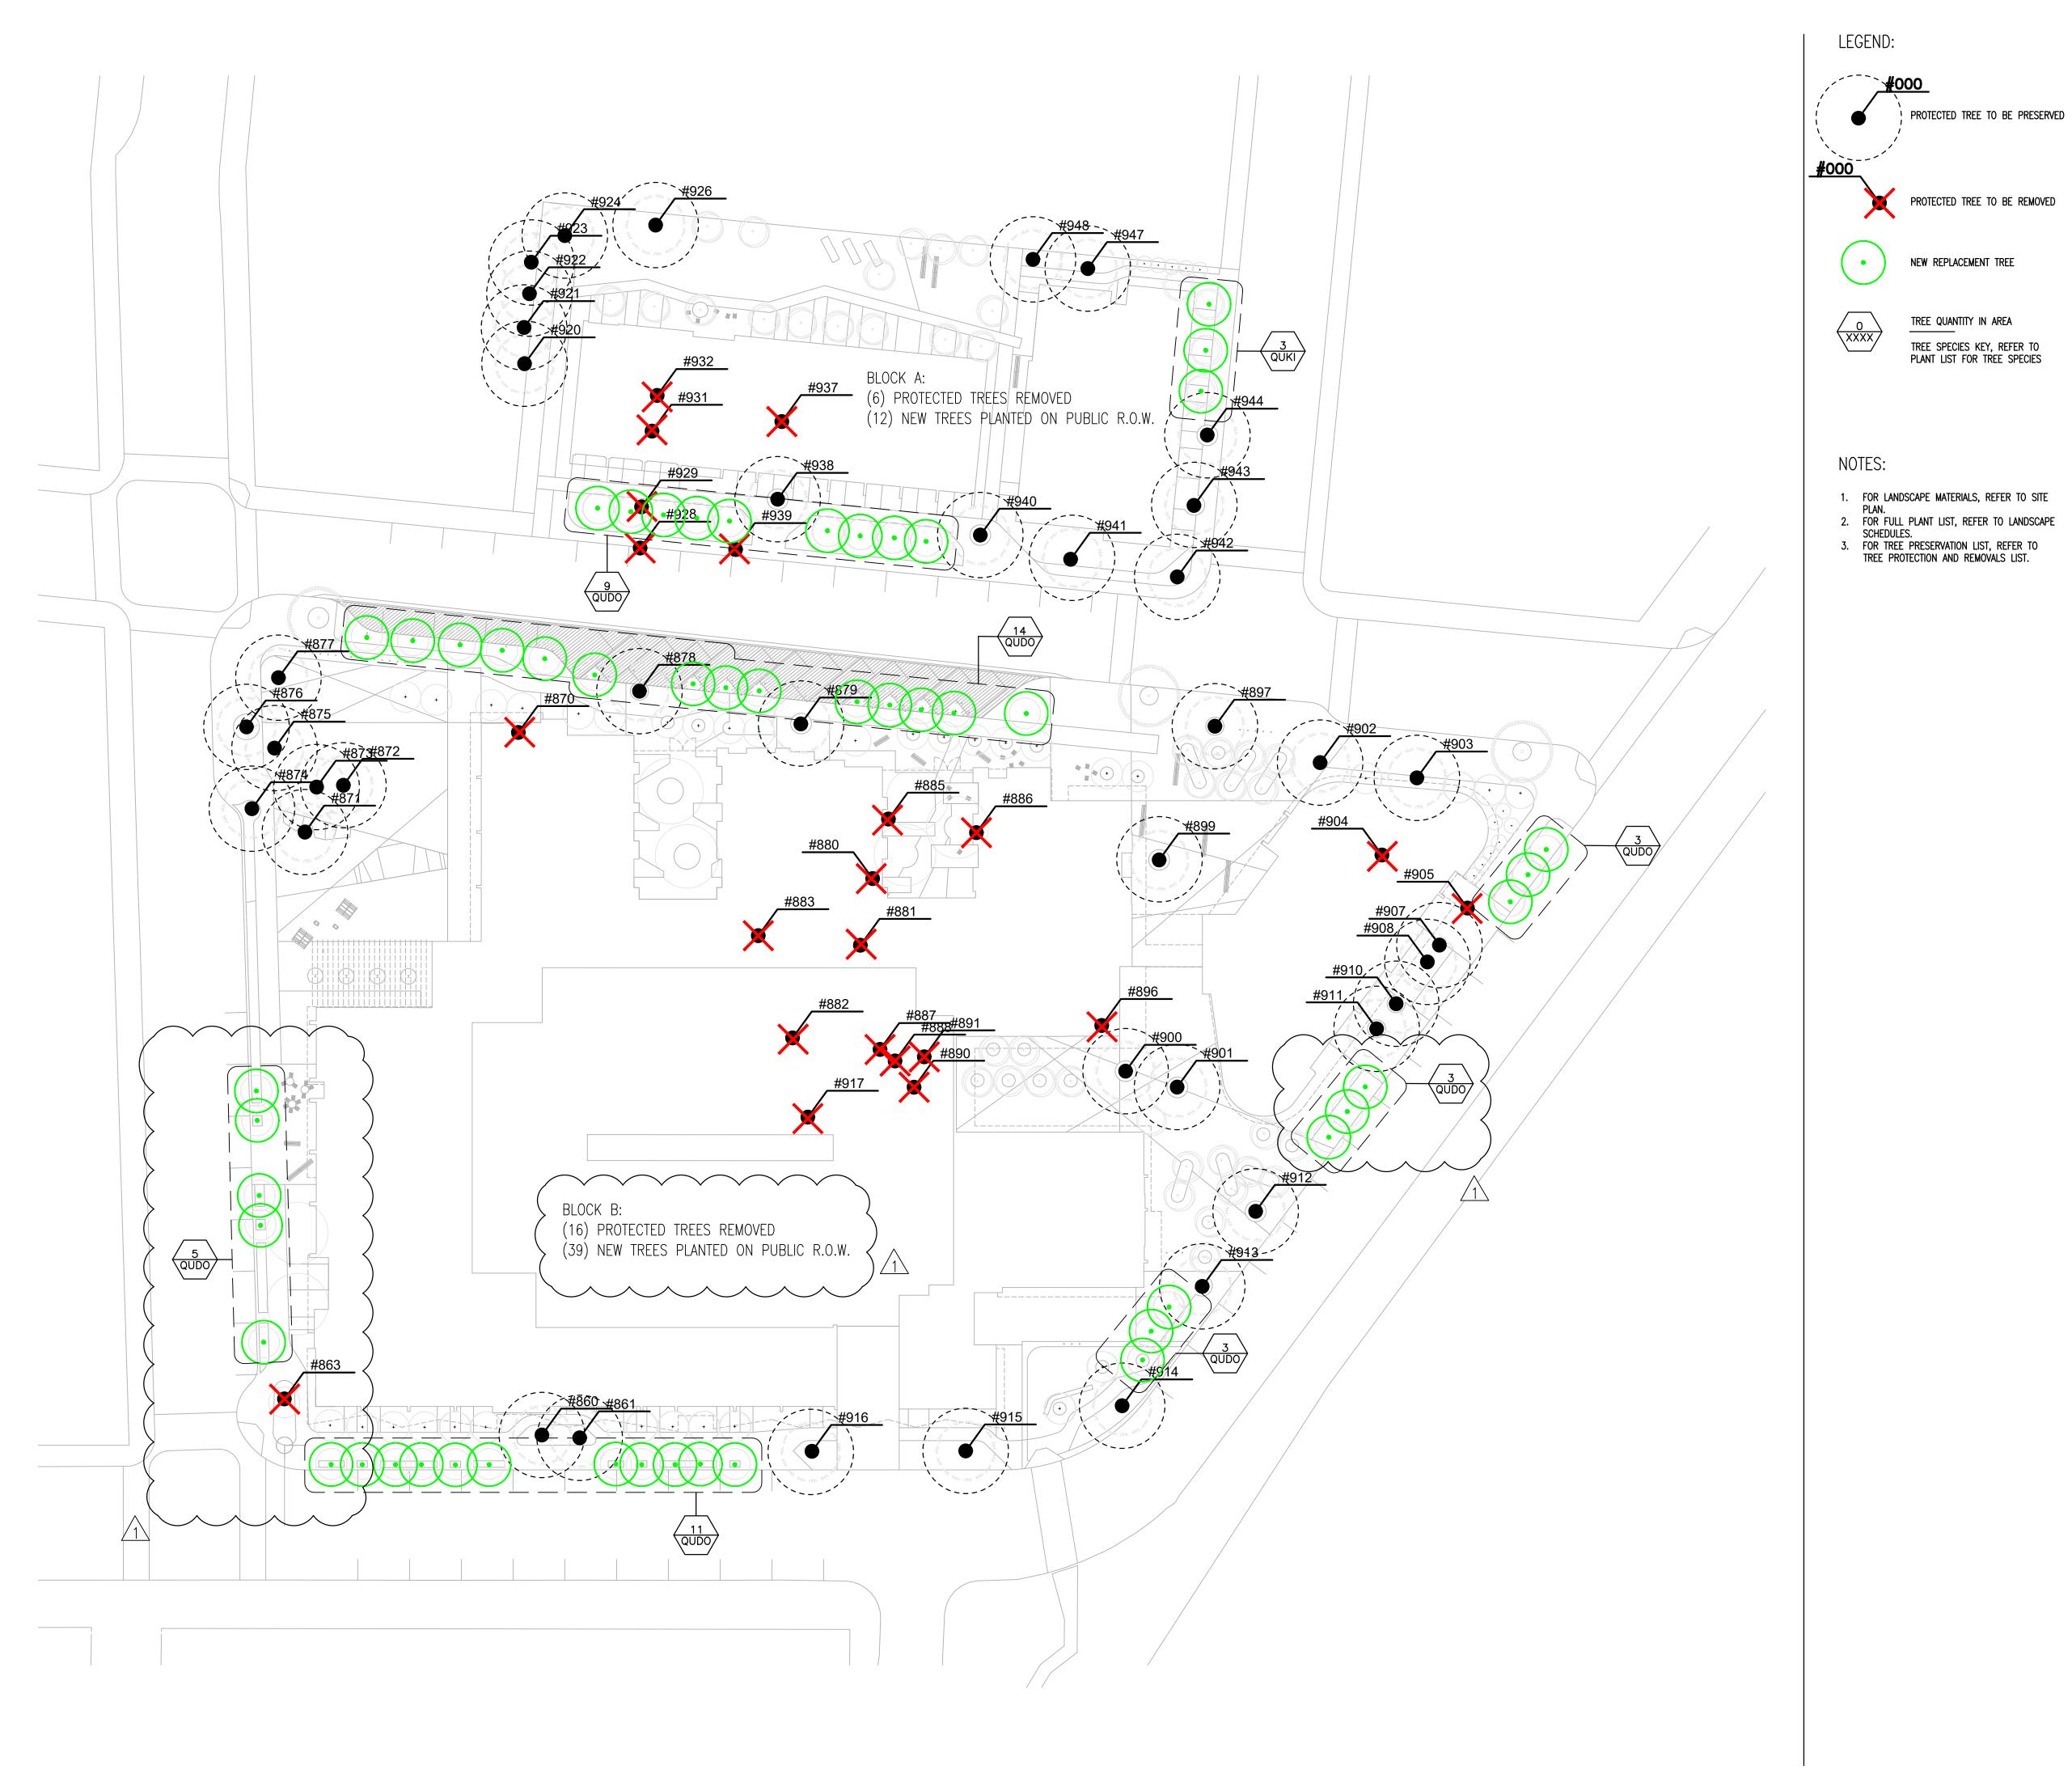



# **David Baker Architects**

dbarchitect.com 461 Second St, Loft c127 San Francisco, CA 94107 415.896.6700



HOOD DESIGN STUDIO, In 3016 FILBERT street studio 2 OAKLAND, CA 94608 510 . 595 9686 www.hooddesignstudio.com

	Issuances
Description	Date
Entitlements Submission	09/25/2019

		Revisions
Rev.	Description	Date

1 Response to Comments 10/05/2020

Sat Tit


Application -September 2019

Drawing Title

Tree Protection & Removal Plan

T-1.1

Date 25 September, 2019 Project No. 21620

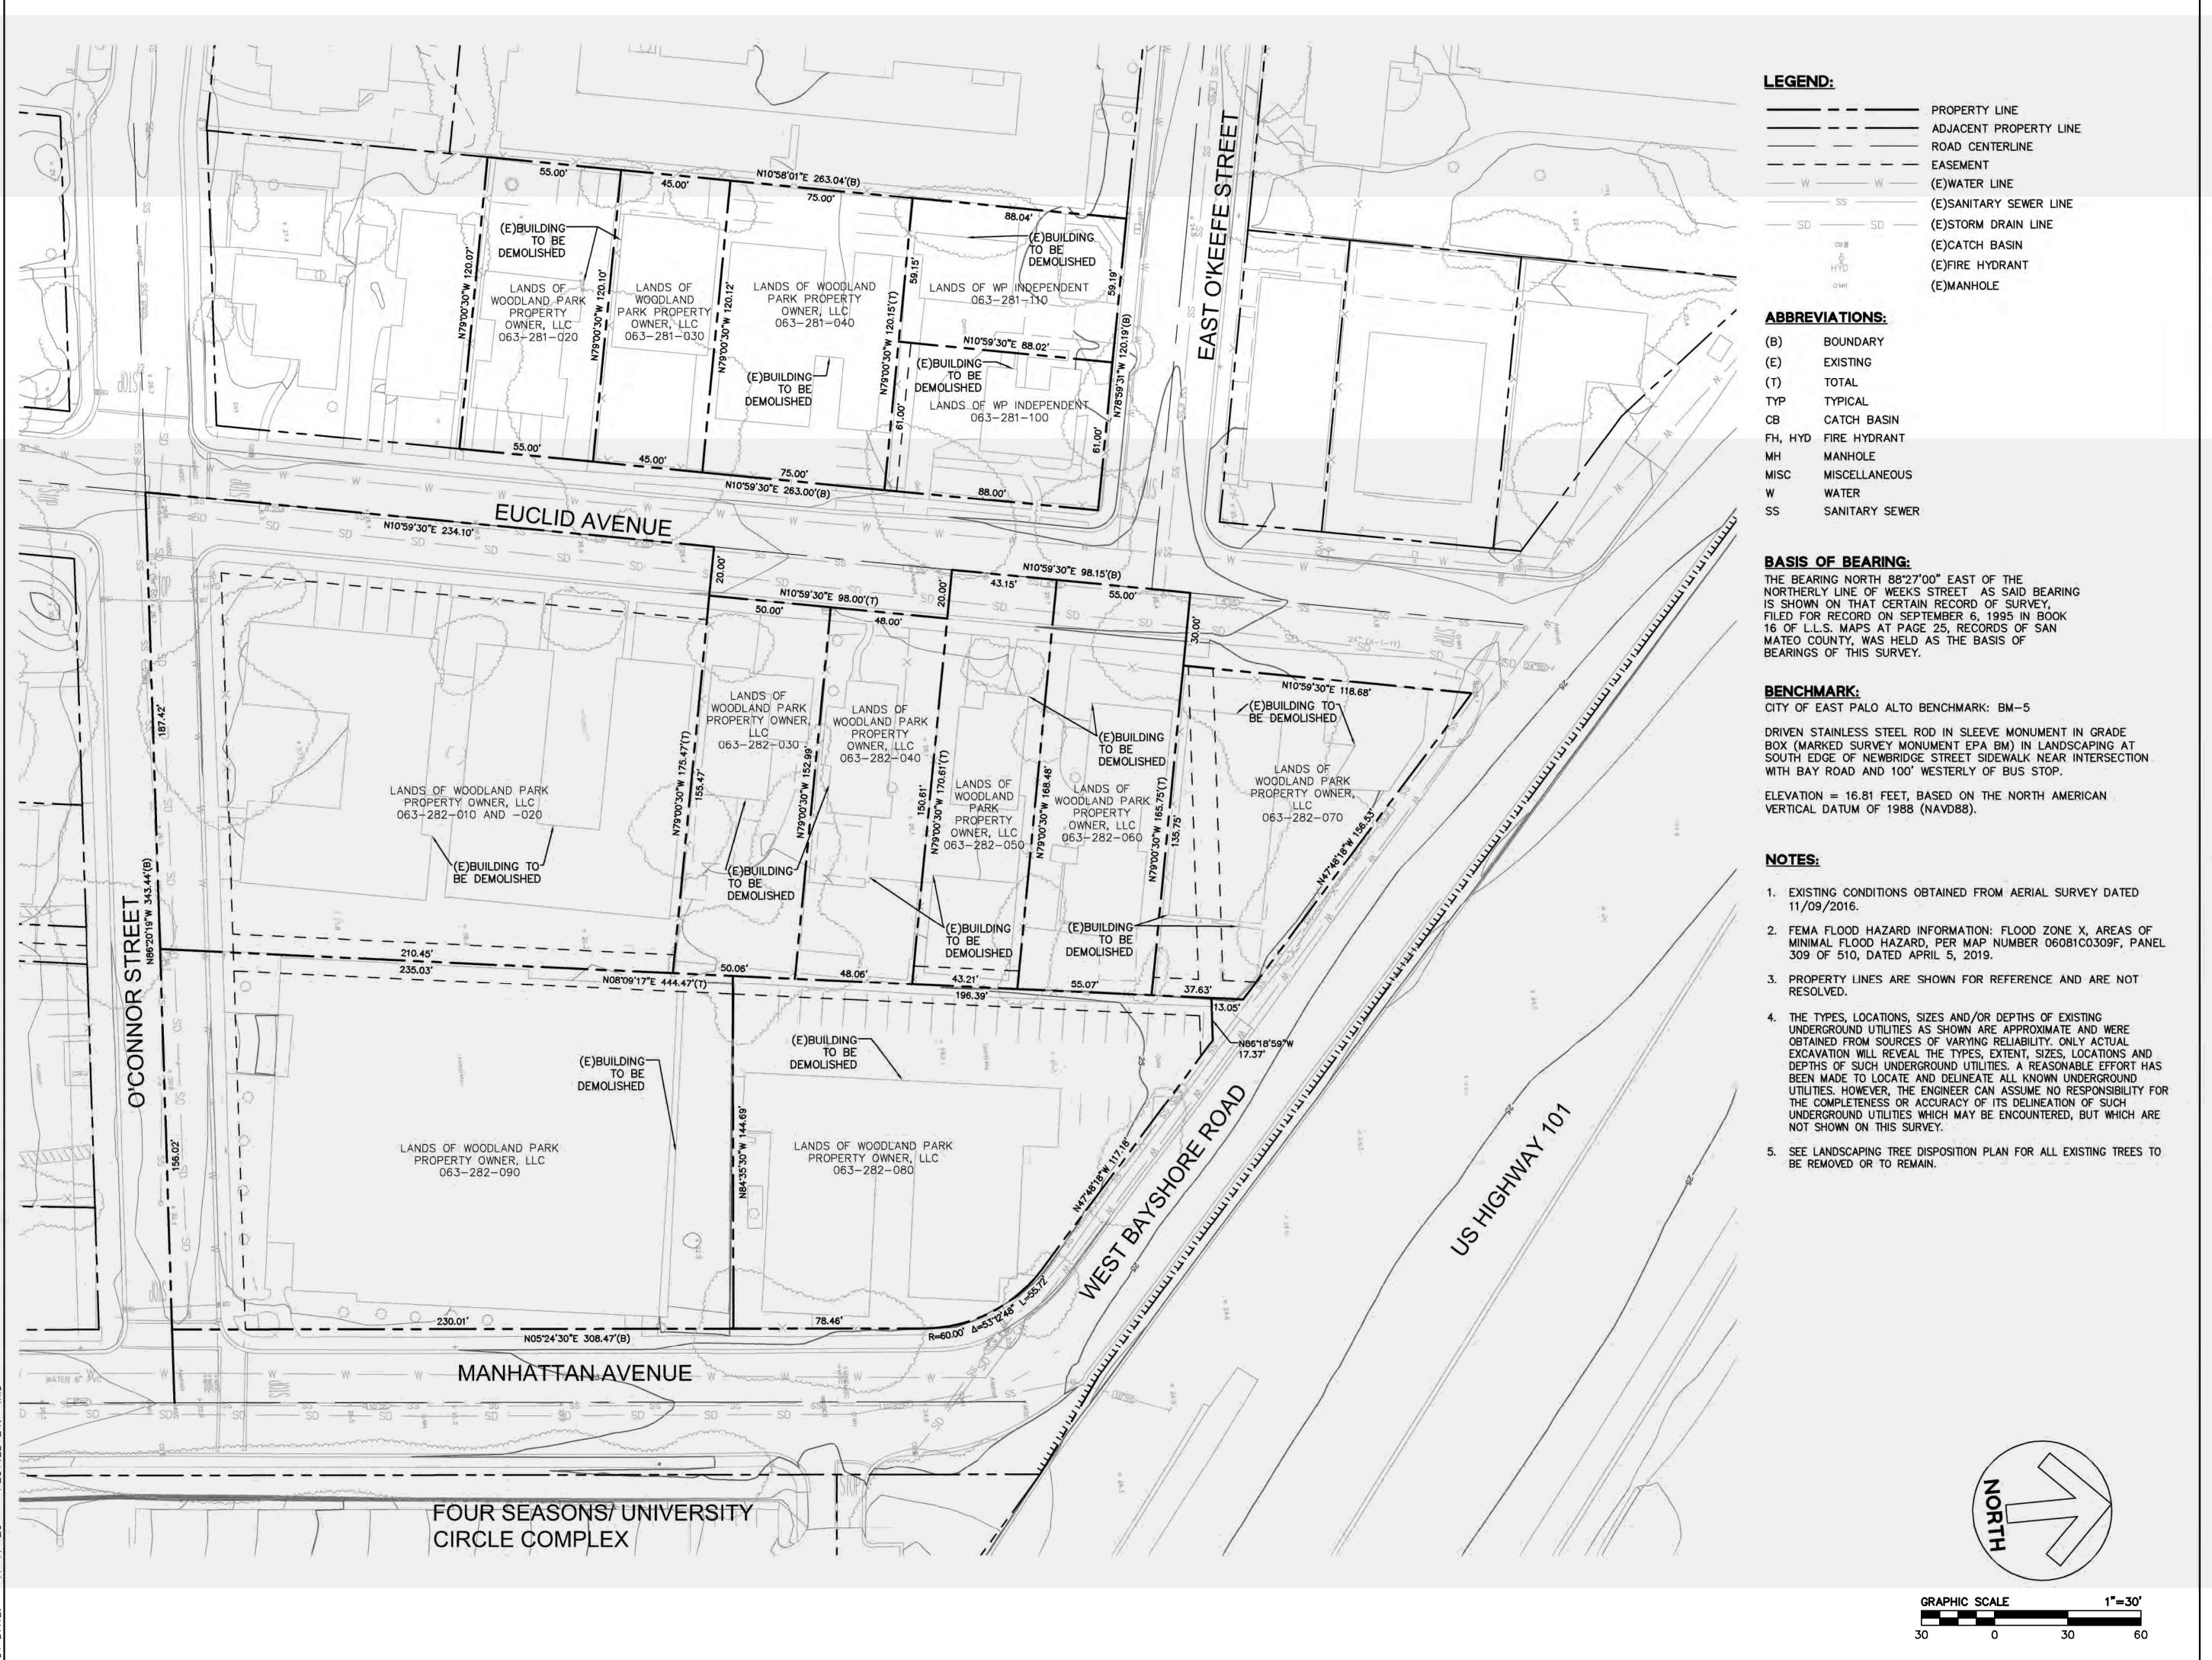

Euclid Improvements



## **BKF ENGINEERS**

www.bkf.com 1730 N. First Street, Suite 600 San Jose, CA 95112 408.467.9100

License Stamp

	Issuances		
Description	Date		
Entitlements Submission	09/25/2019		

Revisions

Rev. Description Date

Application - September 2019

**Drawing Title** 


EXISTING CONDITIONS AND DEMOLITION PLAN

Sheet No.

C1.0

 Date
 2020-11-17

 Project No.
 20166089-20

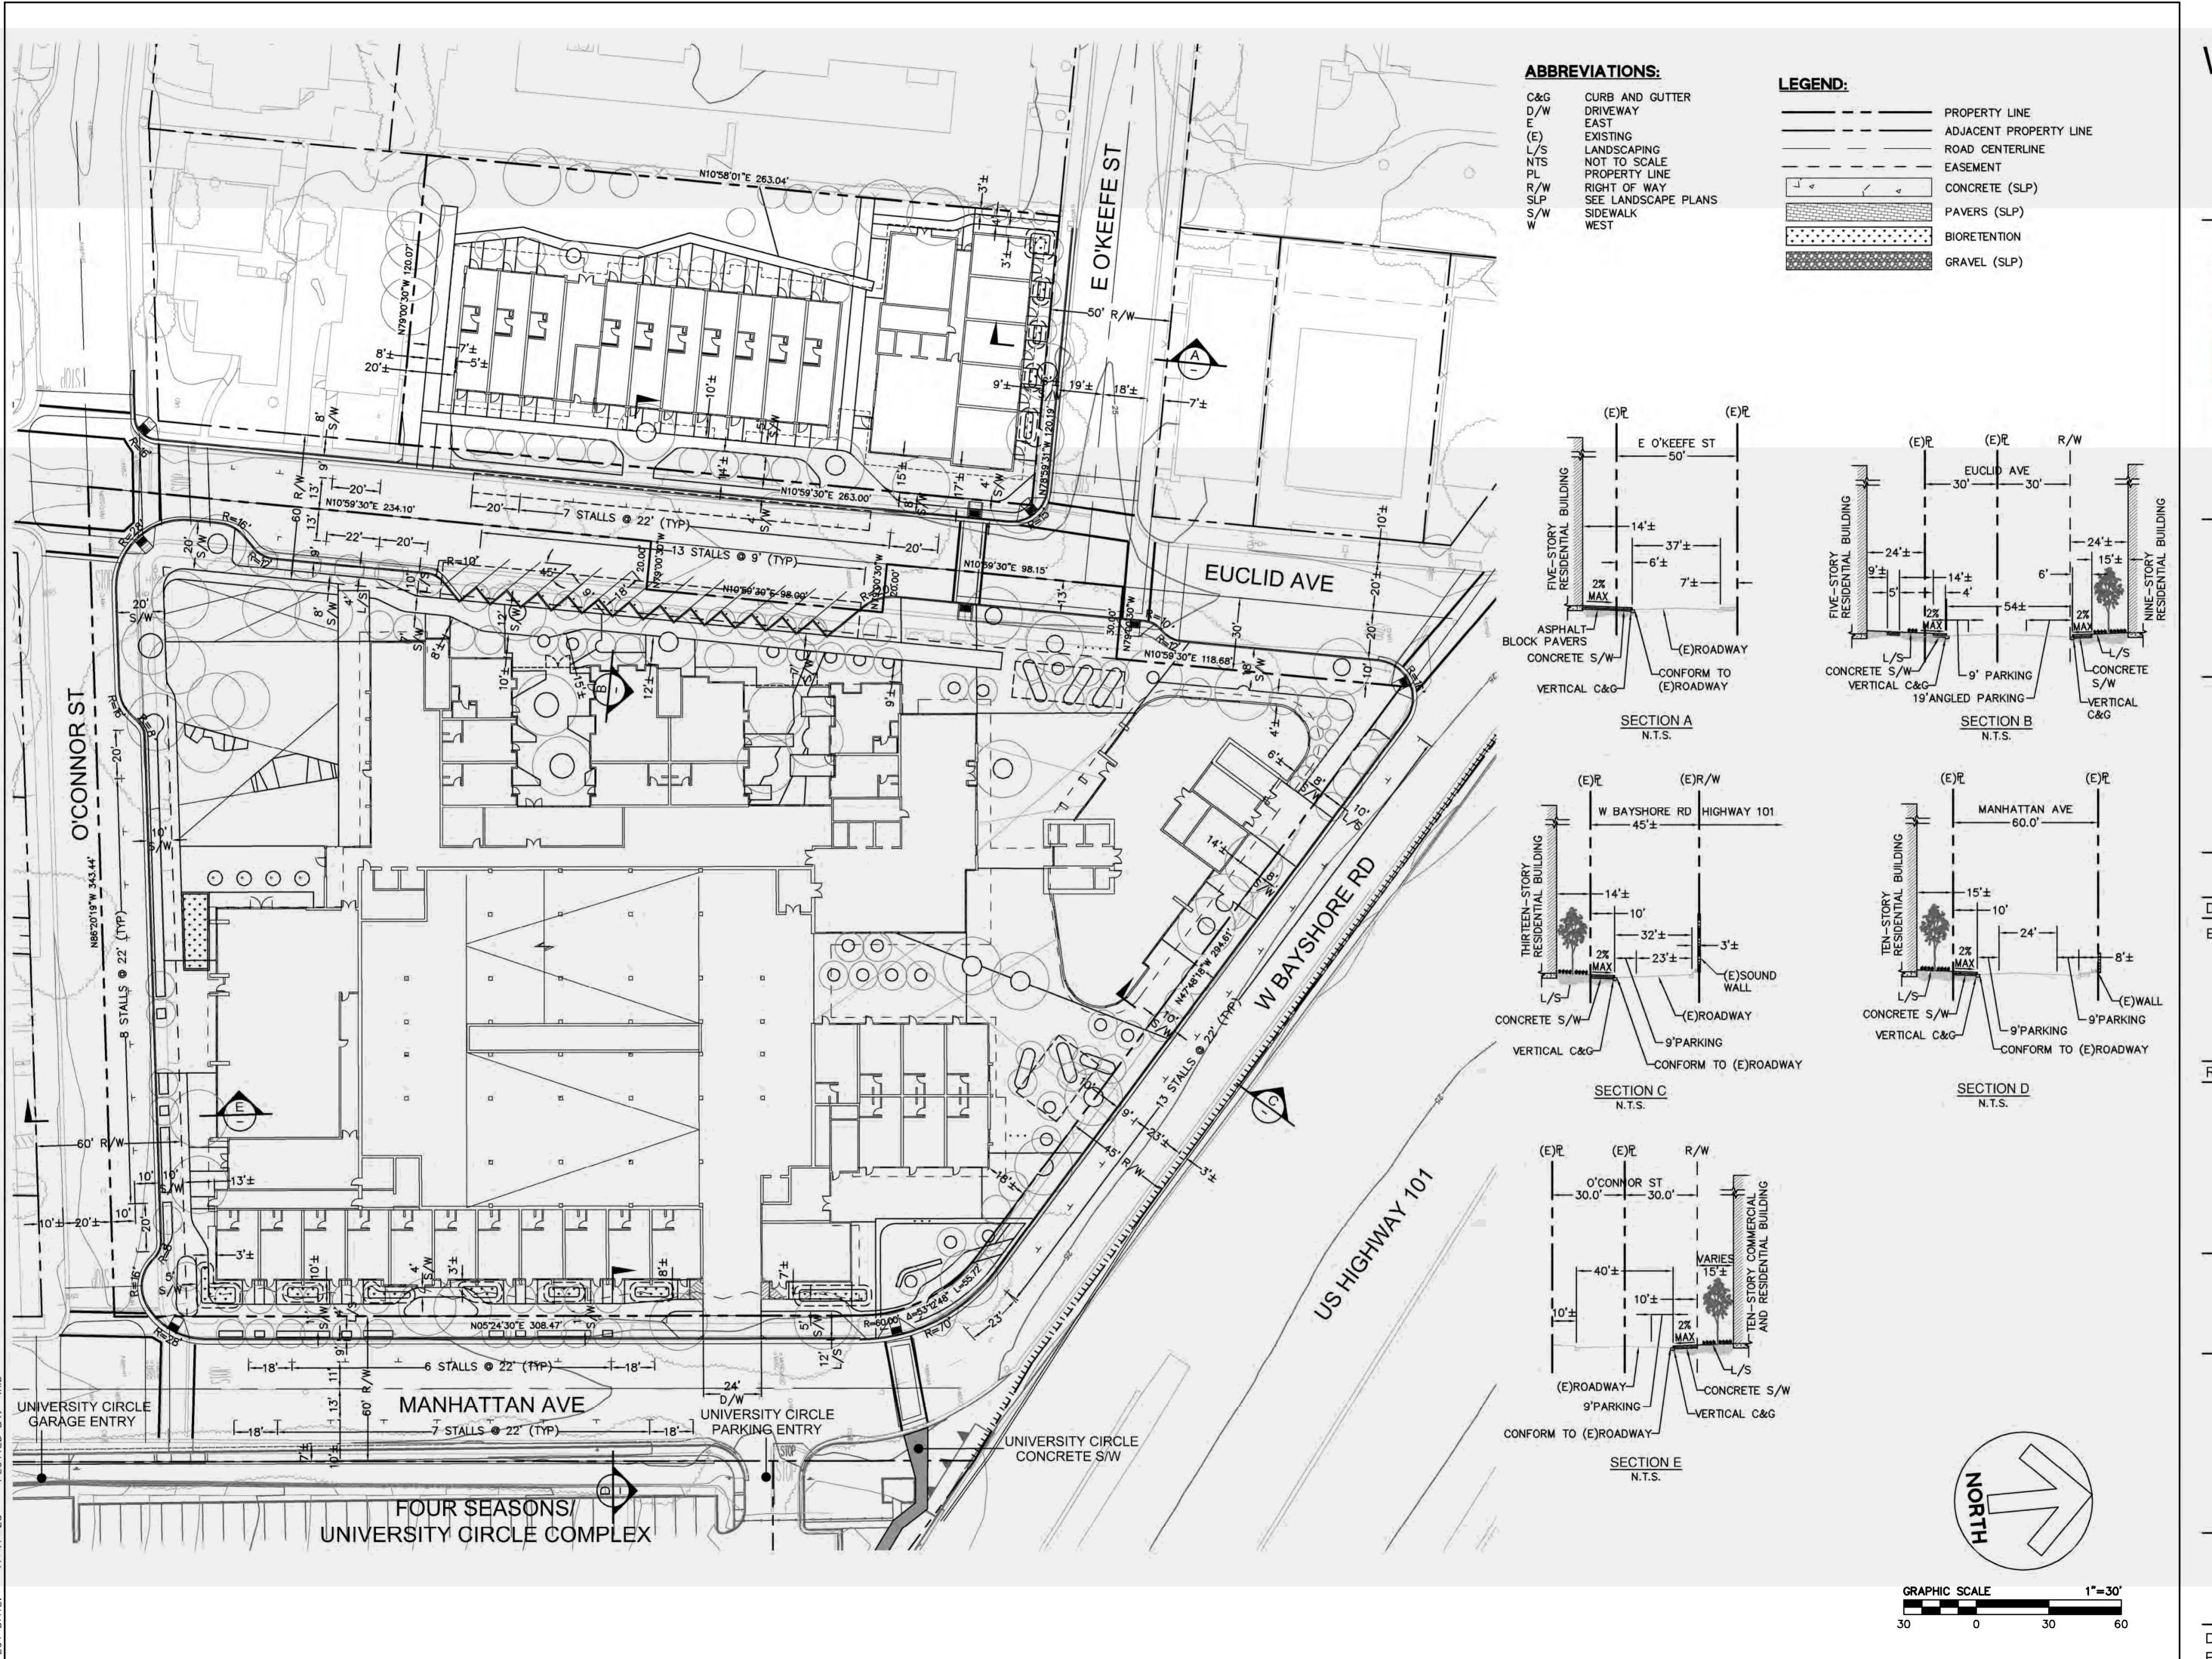

# Euclid Improvements



### **BKF ENGINEERS**

www.bkf.com 1730 N. First Street, Suite 600 San Jose, CA 95112 408.467.9100

License Stamp

	Issuances Date	
Description		
Entitlements Submission	09/25/2019	

-		Revisions	
Rev.	Description	Date	


Application -September 2019

Drawing Title

PRELIMINARY SITE PLAN

Sheet No.

Date 2020-11-17 Project No. 20166089-20

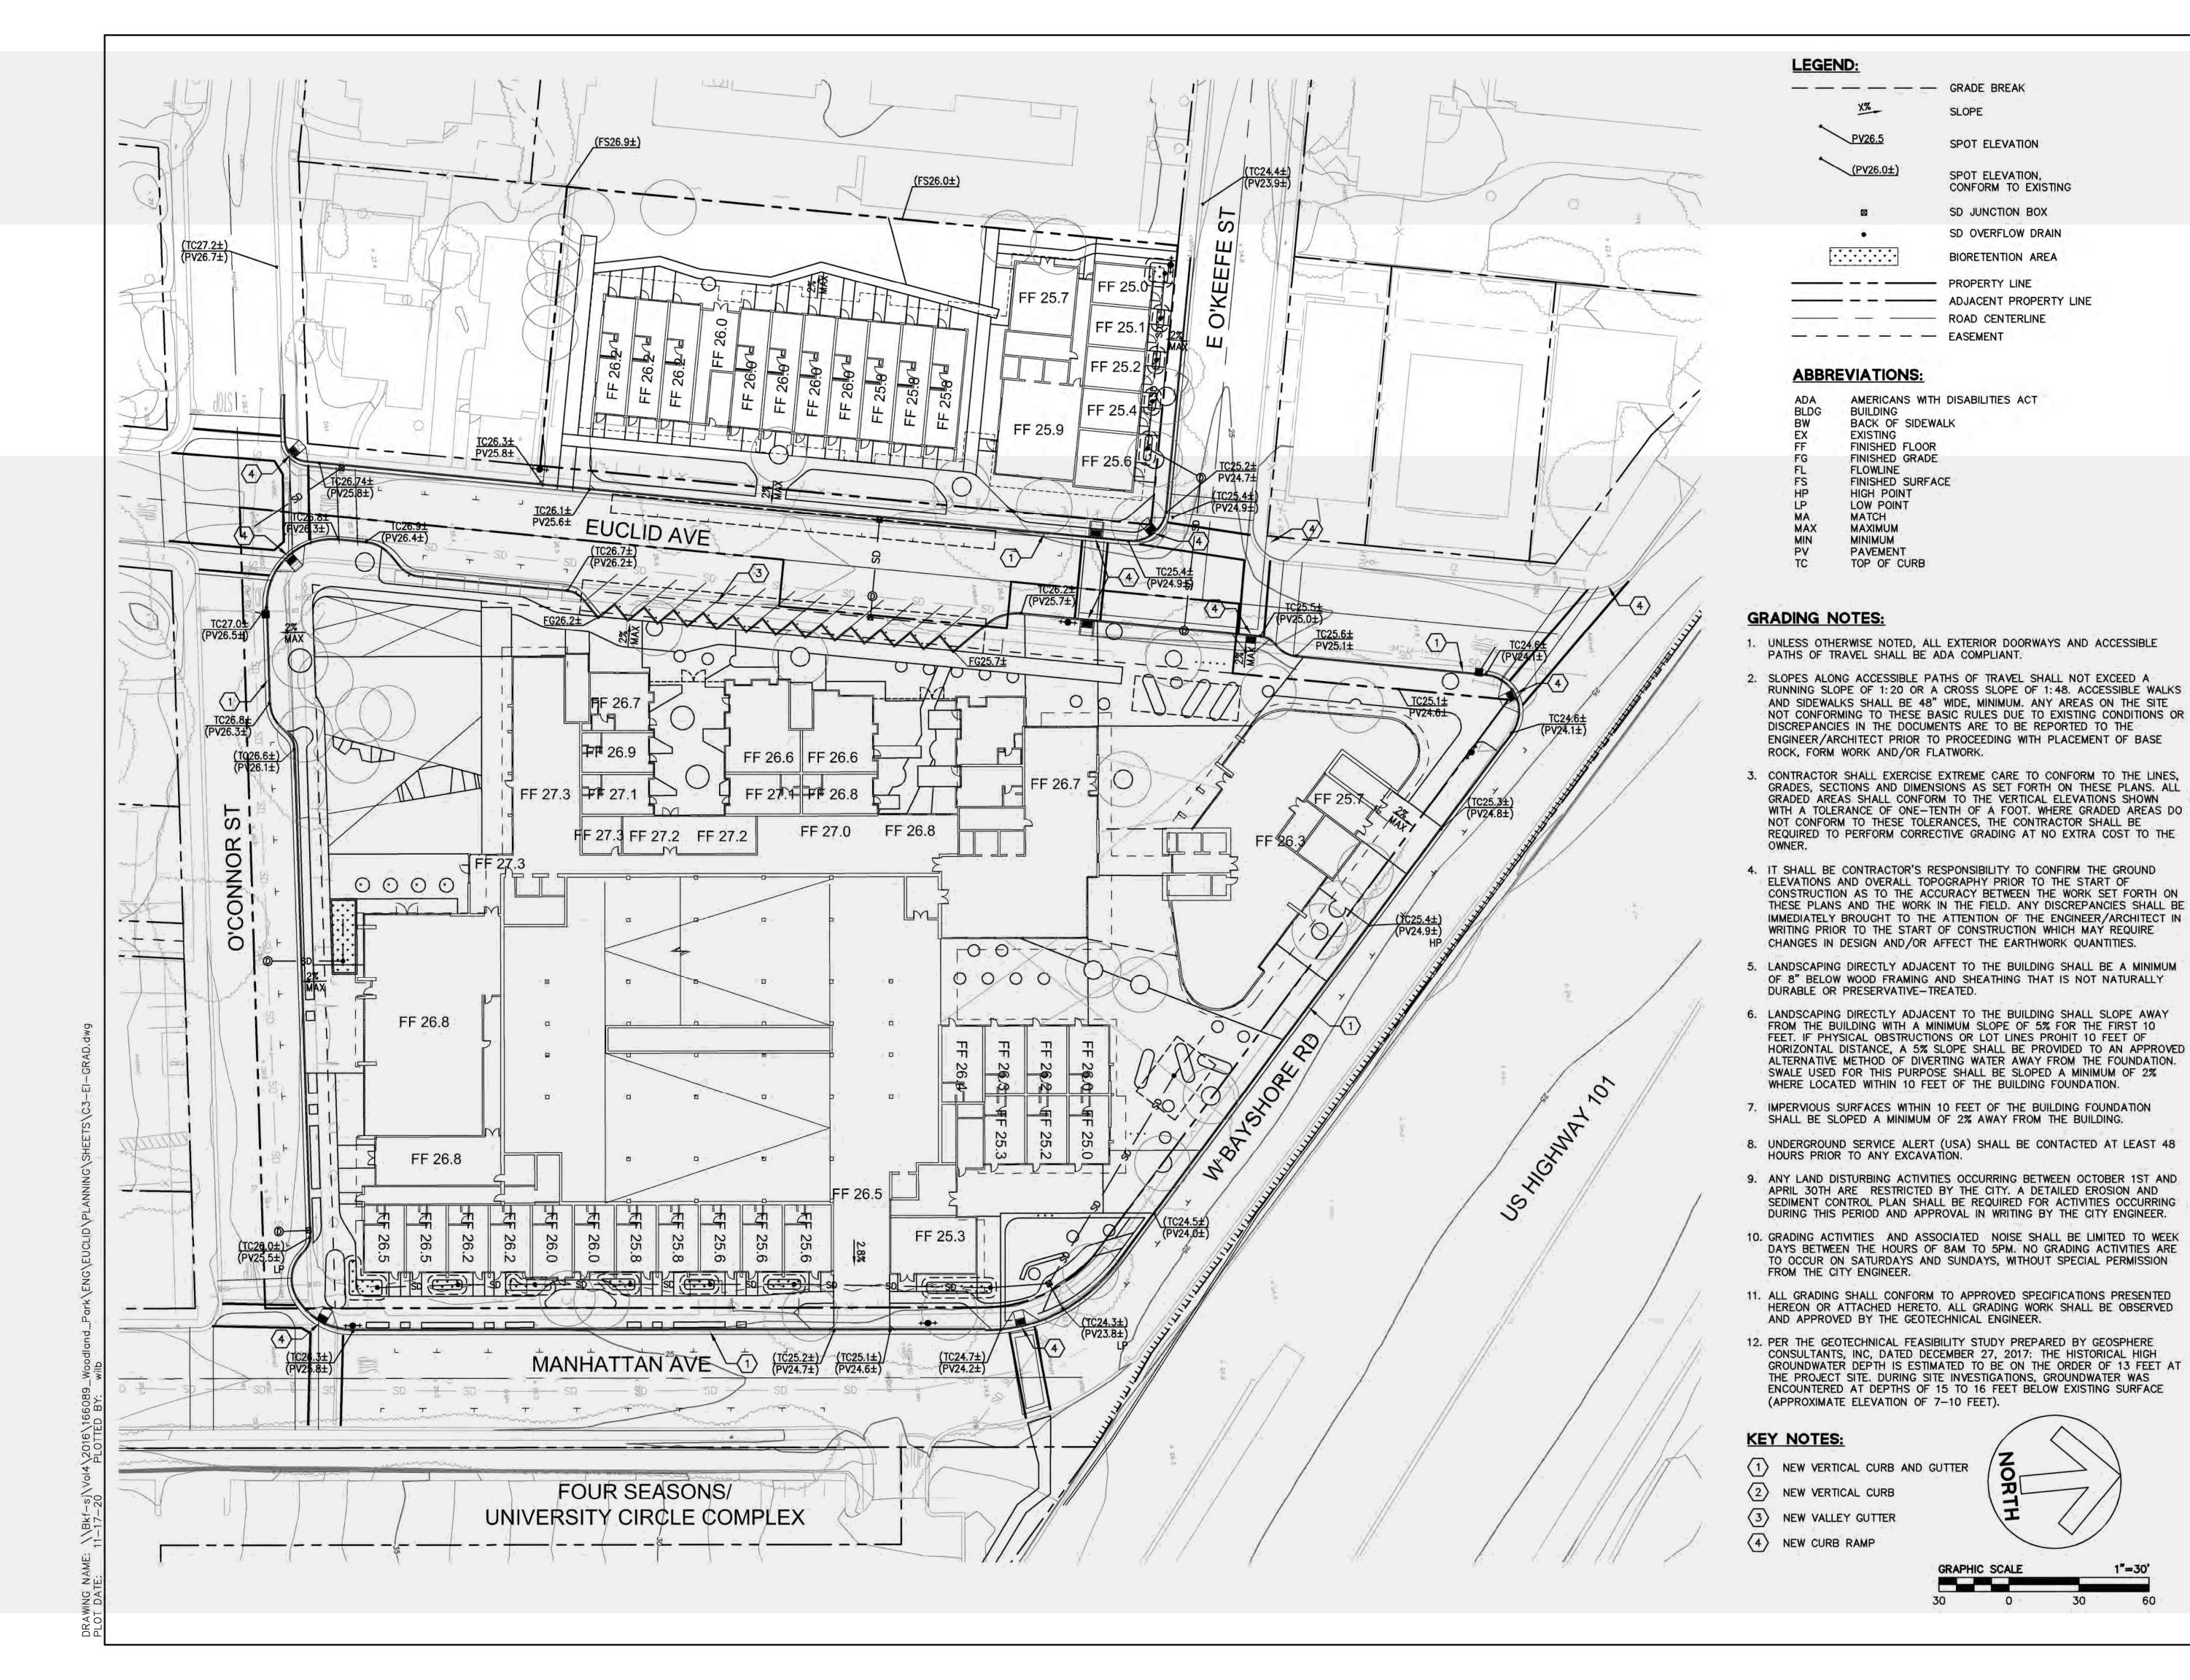

# Euclid Improvements



#### **BKF ENGINEERS**

www.bkf.com 1730 N. First Street, Suite 600 San Jose, CA 95112 408.467.9100

License Stamp

	Issuances	
Description	Date	
Entitlements Submission	09/25/2019	

Revisions

Rev. Description Date

Application - September 2019


Drawing Title

PRELIMINARY GRADING AND DRAINAGE PLAN

Sheet No.

C3.0

Date 2020-11-17 Project No. 20166089-20

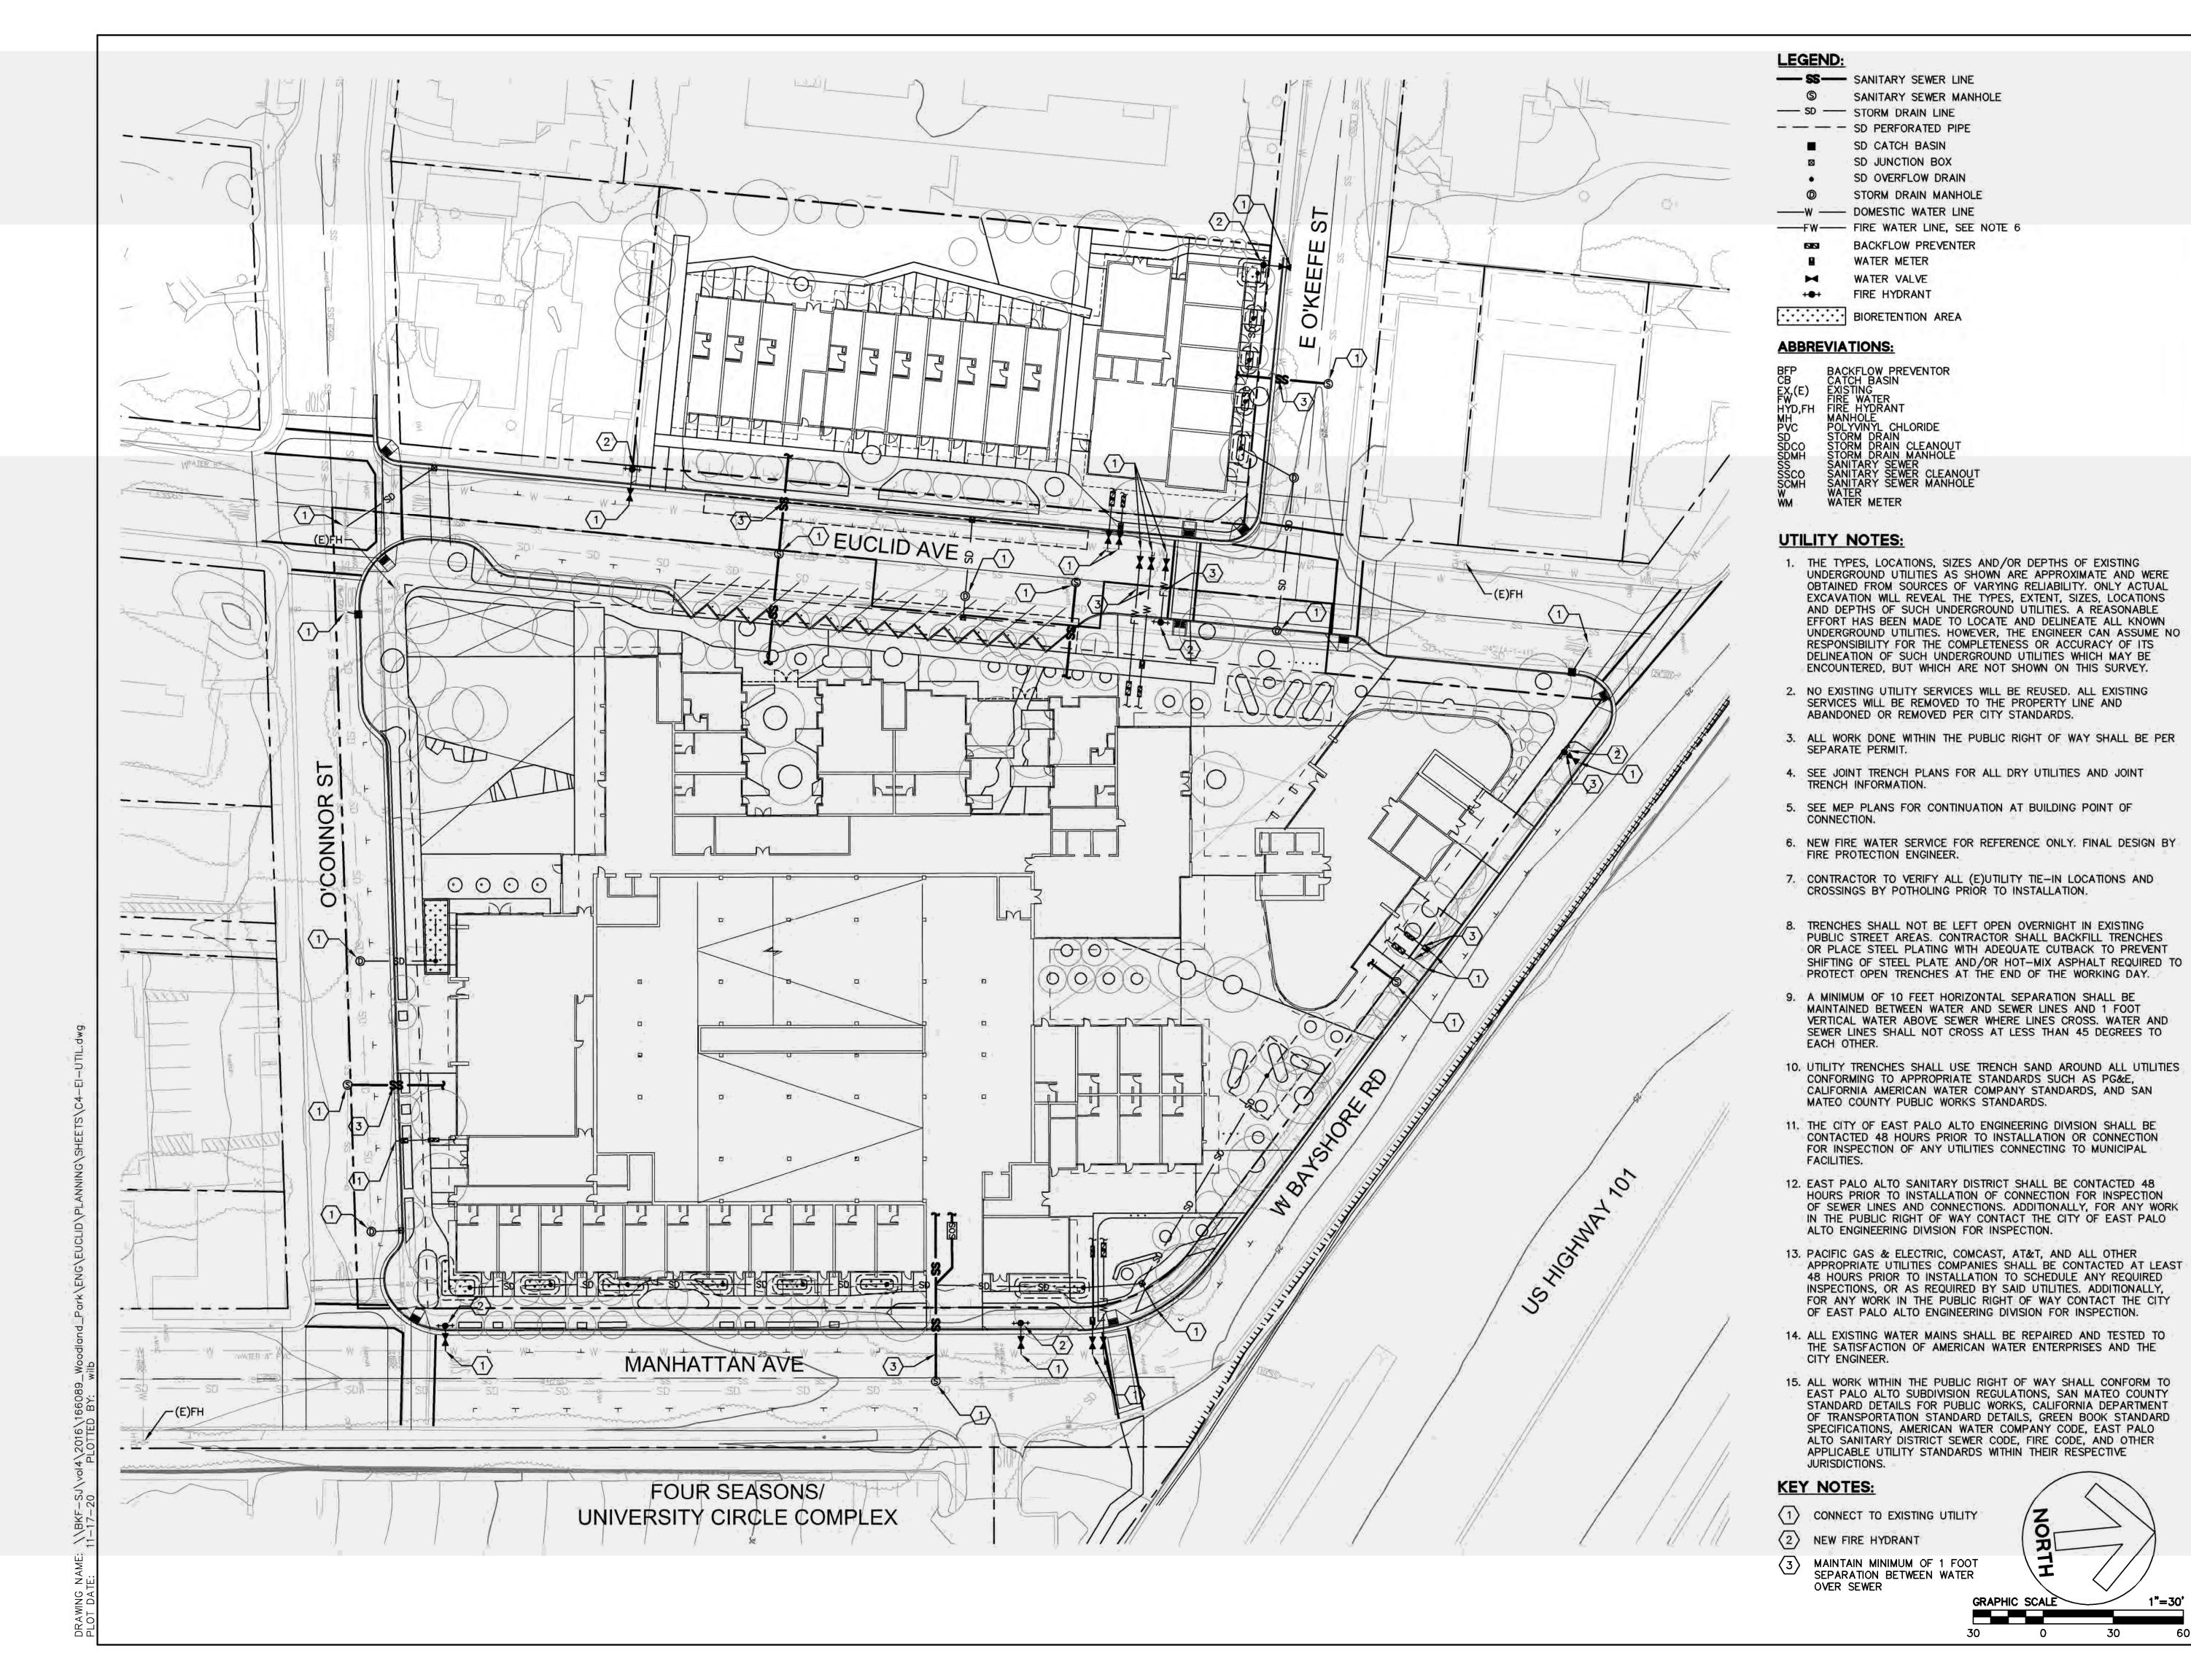

Euclid Improvements



## **BKF ENGINEERS**

www.bkf.com 1730 N. First Street, Suite 600 San Jose, CA 95112 408.467.9100

License Stamp

Issuanc	
Description	Date

Revisions Rev. Description Date

Application -

**PRELIMINARY UTILITY PLAN** 

Sheet No.

Date 20166089-20 Project No.

1"=30'

2020-11-17


YEARS

Entitlements Submission 09/25/2019

Set Title September 2019

**Drawing Title** 

C4.0

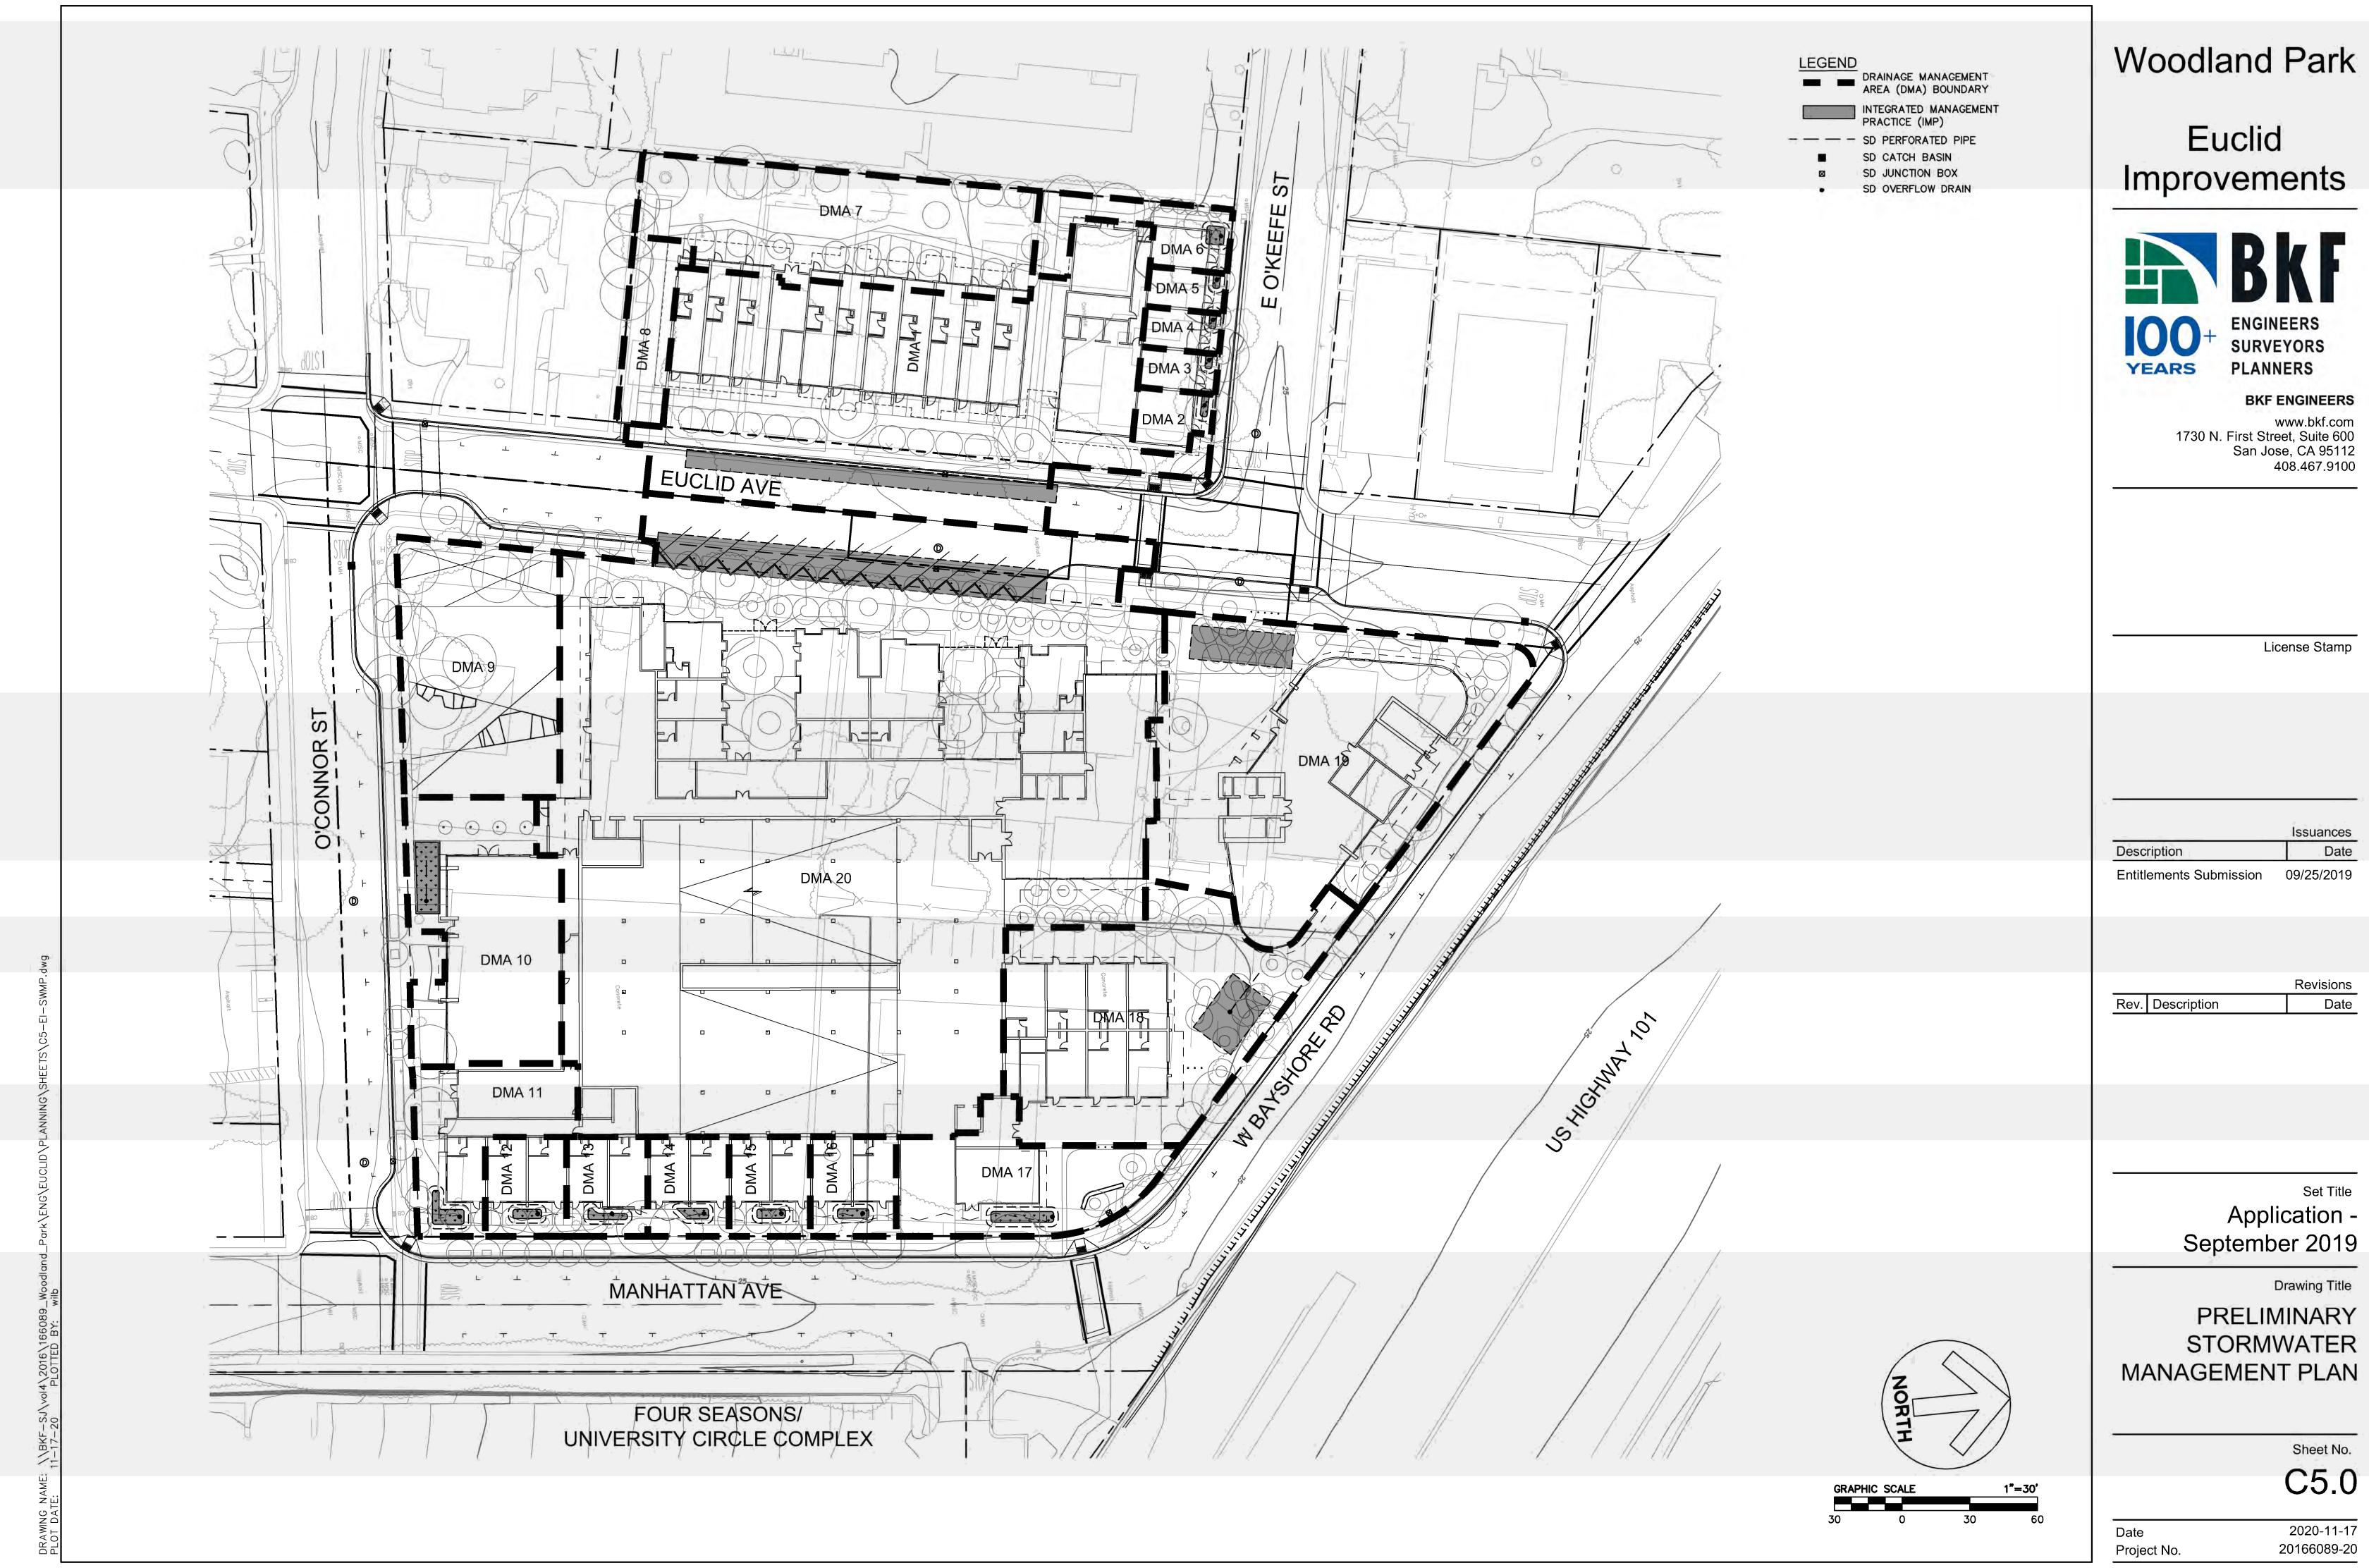

**PRELIMINARY** STORMWATER

#### TREATMENT CONTROL MEASURE SUMMARY EXISTING CONDITION TREATMENT MEASURE SIZE PROPOSED CONDITION DRAINAGE DRAINAGE AREA TREATMENT MEASURE TYPE PERVIOUS SURFACE IMPERVIOUS SURFACE PERVIOUS SURFACE IMPERVIOUS SURFACE REQUIRED PROVIDED AREAS SIZE (SF) (SF) (SF) (SF) (SF) (SF) (SF) STREETS/PARKING STREETS/PARKING MODULAR GRID BIORETENTION LANDSCAPE 9,260 LANDSCAPE 5,655 22,160 799 1,320 DMA-1 ROOF/SIDEWALK 14,320 2,340 2,185 ROOF/SIDEWALK (E.G. SILVA CELL) 10,560 LANDSCAPE 100 ROOF/SIDEWALK 780 LANDSCAPE ROOF/SIDEWALK NON-STRUCTURAL 880 31 31 DMA-2 BIORETENTION AREA LANDSCAPE 110 LANDSCAPE ROOF/SIDEWALK 420 ROOF/SIDEWALK 510 NON-STRUCTURAL DMA-3620 22 22 **BIORETENTION AREA** STREETS/PARKING LANDSCAPE LANDSCAPE NON-STRUCTURAL ROOF/SIDEWALK 620 20 22 DMA-4 **BIORETENTION AREA** ROOF/SIDEWALK 100 STREETS/PARKING 495 LANDSCAPE 110 ROOF/SIDEWALK 510 LANDSCAPE NON-STRUCTURAL DMA-5 620 20 22 **BIORETENTION AREA** STREETS/PARKING 455 LANDSCAPE ROOF/SIDEWALK 1,575 LANDSCAPE NON-STRUCTURAL 1,925 63 DMA-6 63 1,090 350 **BIORETENTION AREA** ROOF/SIDEWALK 380 STREETS/PARKING LANDSCAPE 1,030 LANDSCAPE 1,810 ROOF/SIDEWALK 6,600 STRUCTURAL DMA-7 8,410 336 336 ROOF/SIDEWALK BIORETENTION AREA 3,570 STREETS/PARKING LANDSCAPE 1,795 N/A N/A N/A N/A DMA-8 PERMEABLE PAVERS ROOF/SIDEWALK 1,090 STREETS/PARKING LANDSCAPE 7,905 N/A N/A N/A N/A DMA-9 PARK: SELF-TREATING AREA 3,065 ROOF/SIDEWALK 4,200 STREETS/PARKING LANDSCAPE 2,000 ROOF/SIDEWALK STRUCTURAL N/A DMA-10 7,405 296 300 ROOF/SIDEWALK 7,405 BIORETENTION AREA LANDSCAPE 980 ROOF/SIDEWALK 2,725 ROOF/SIDEWALK 2,725 LANDSCAPE NON-STRUCTURAL 3,705 109 DMA-11 115 BIORETENTION AREA LANDSCAPE 310 ROOF/SIDEWALK 1,135 ROOF/SIDEWALK 1,275 LANDSCAPE NON-STRUCTURAL 1,585 51 DMA-12 51 BIORETENTION AREA LANDSCAPE 310 ROOF/SIDEWALK 1,250 ROOF/SIDEWALK 1,275 LANDSCAPE NON-STRUCTURAL 1,585 DMA-13 51 51 **BIORETENTION AREA** LANDSCAPE 310 ROOF/SIDEWALK 1,315 ROOF/SIDEWALK 1,275 LANDSCAPE NON-STRUCTURAL 1,585 DMA-14 51 51 **BIORETENTION AREA** ROOF/SIDEWALK 1,415 LANDSCAPE 310 ROOF/SIDEWALK 1,275 LANDSCAPE NON-STRUCTURAL 1,585 51 51 DMA-15 **BIORETENTION AREA** 170 LANDSCAPE 285 ROOF/SIDEWALK 1,390 LANDSCAPE 25 ROOF/SIDEWALK 1,650 NON-STRUCTURAL 1,675 56 DMA-16 56 BIORETENTION AREA LANDSCAPE 1,645 ROOF/SIDEWALK 3,230 ROOF/SIDEWALK 4,860 LANDSCAPE NON-STRUCTURAL 4,875 129 DMA-17 129 **BIORETENTION AREA** STREETS/PARKING 6,710 ROOF/SIDEWALK 11,730 LANDSCAPE STRUCTURAL N/A 11,730 469 DMA-18 490 BIORETENTION AREA ROOF/SIDEWALK 4,900 STREETS/PARKING 100 LANDSCAPE 6,520 LANDSCAPE 3,675 ROOF/SIDEWALK MODULAR GRID BIORETENTION 16,730 522 680 DMA-19 (E.G. SILVA CELL) ROOF/SIDEWALK 13,055 10,110 STREETS/PARKING STREETS/PARKING MODULAR GRID BIORETENTION LANDSCAPE 12,520 29,270 N/A 64,930 2,597 2,604 DMA-20 ROOF/SIDEWALK 41,995 ROOF/SIDEWALK 35,660 10,415 (E.G. SILVA CELL)

162,325

28,480

133,845

12,600

140,025

5,673

6,406

TOTAL

# **NOTES**

1) TREATMENT AREAS WERE SIZED USING THE "4 PERCENT METHOD" FLOW-BASED SIZING CRITERIA IN THE 2014 SAN MATEO COUNTY C.3 STORMWATER TECHNICAL GUIDANCE HANDBOOK.

# Woodland Park

# Euclid Improvements



# **BKF ENGINEERS**

www.bkf.com 1730 N. First Street, Suite 600 San Jose, CA 95112 408.467.9100

License Stamp

	Issuances	
Description	Date	
Entitlements Submission	on 09/25/2019	

		Revisions
Rev.	Description	Date

Application -September 2019

Drawing Title


**PRELIMINARY** STORMWATER MANAGEMENT PLAN

Sheet No.

C5.1

2020-11-17 20166089-20 Project No.

Date

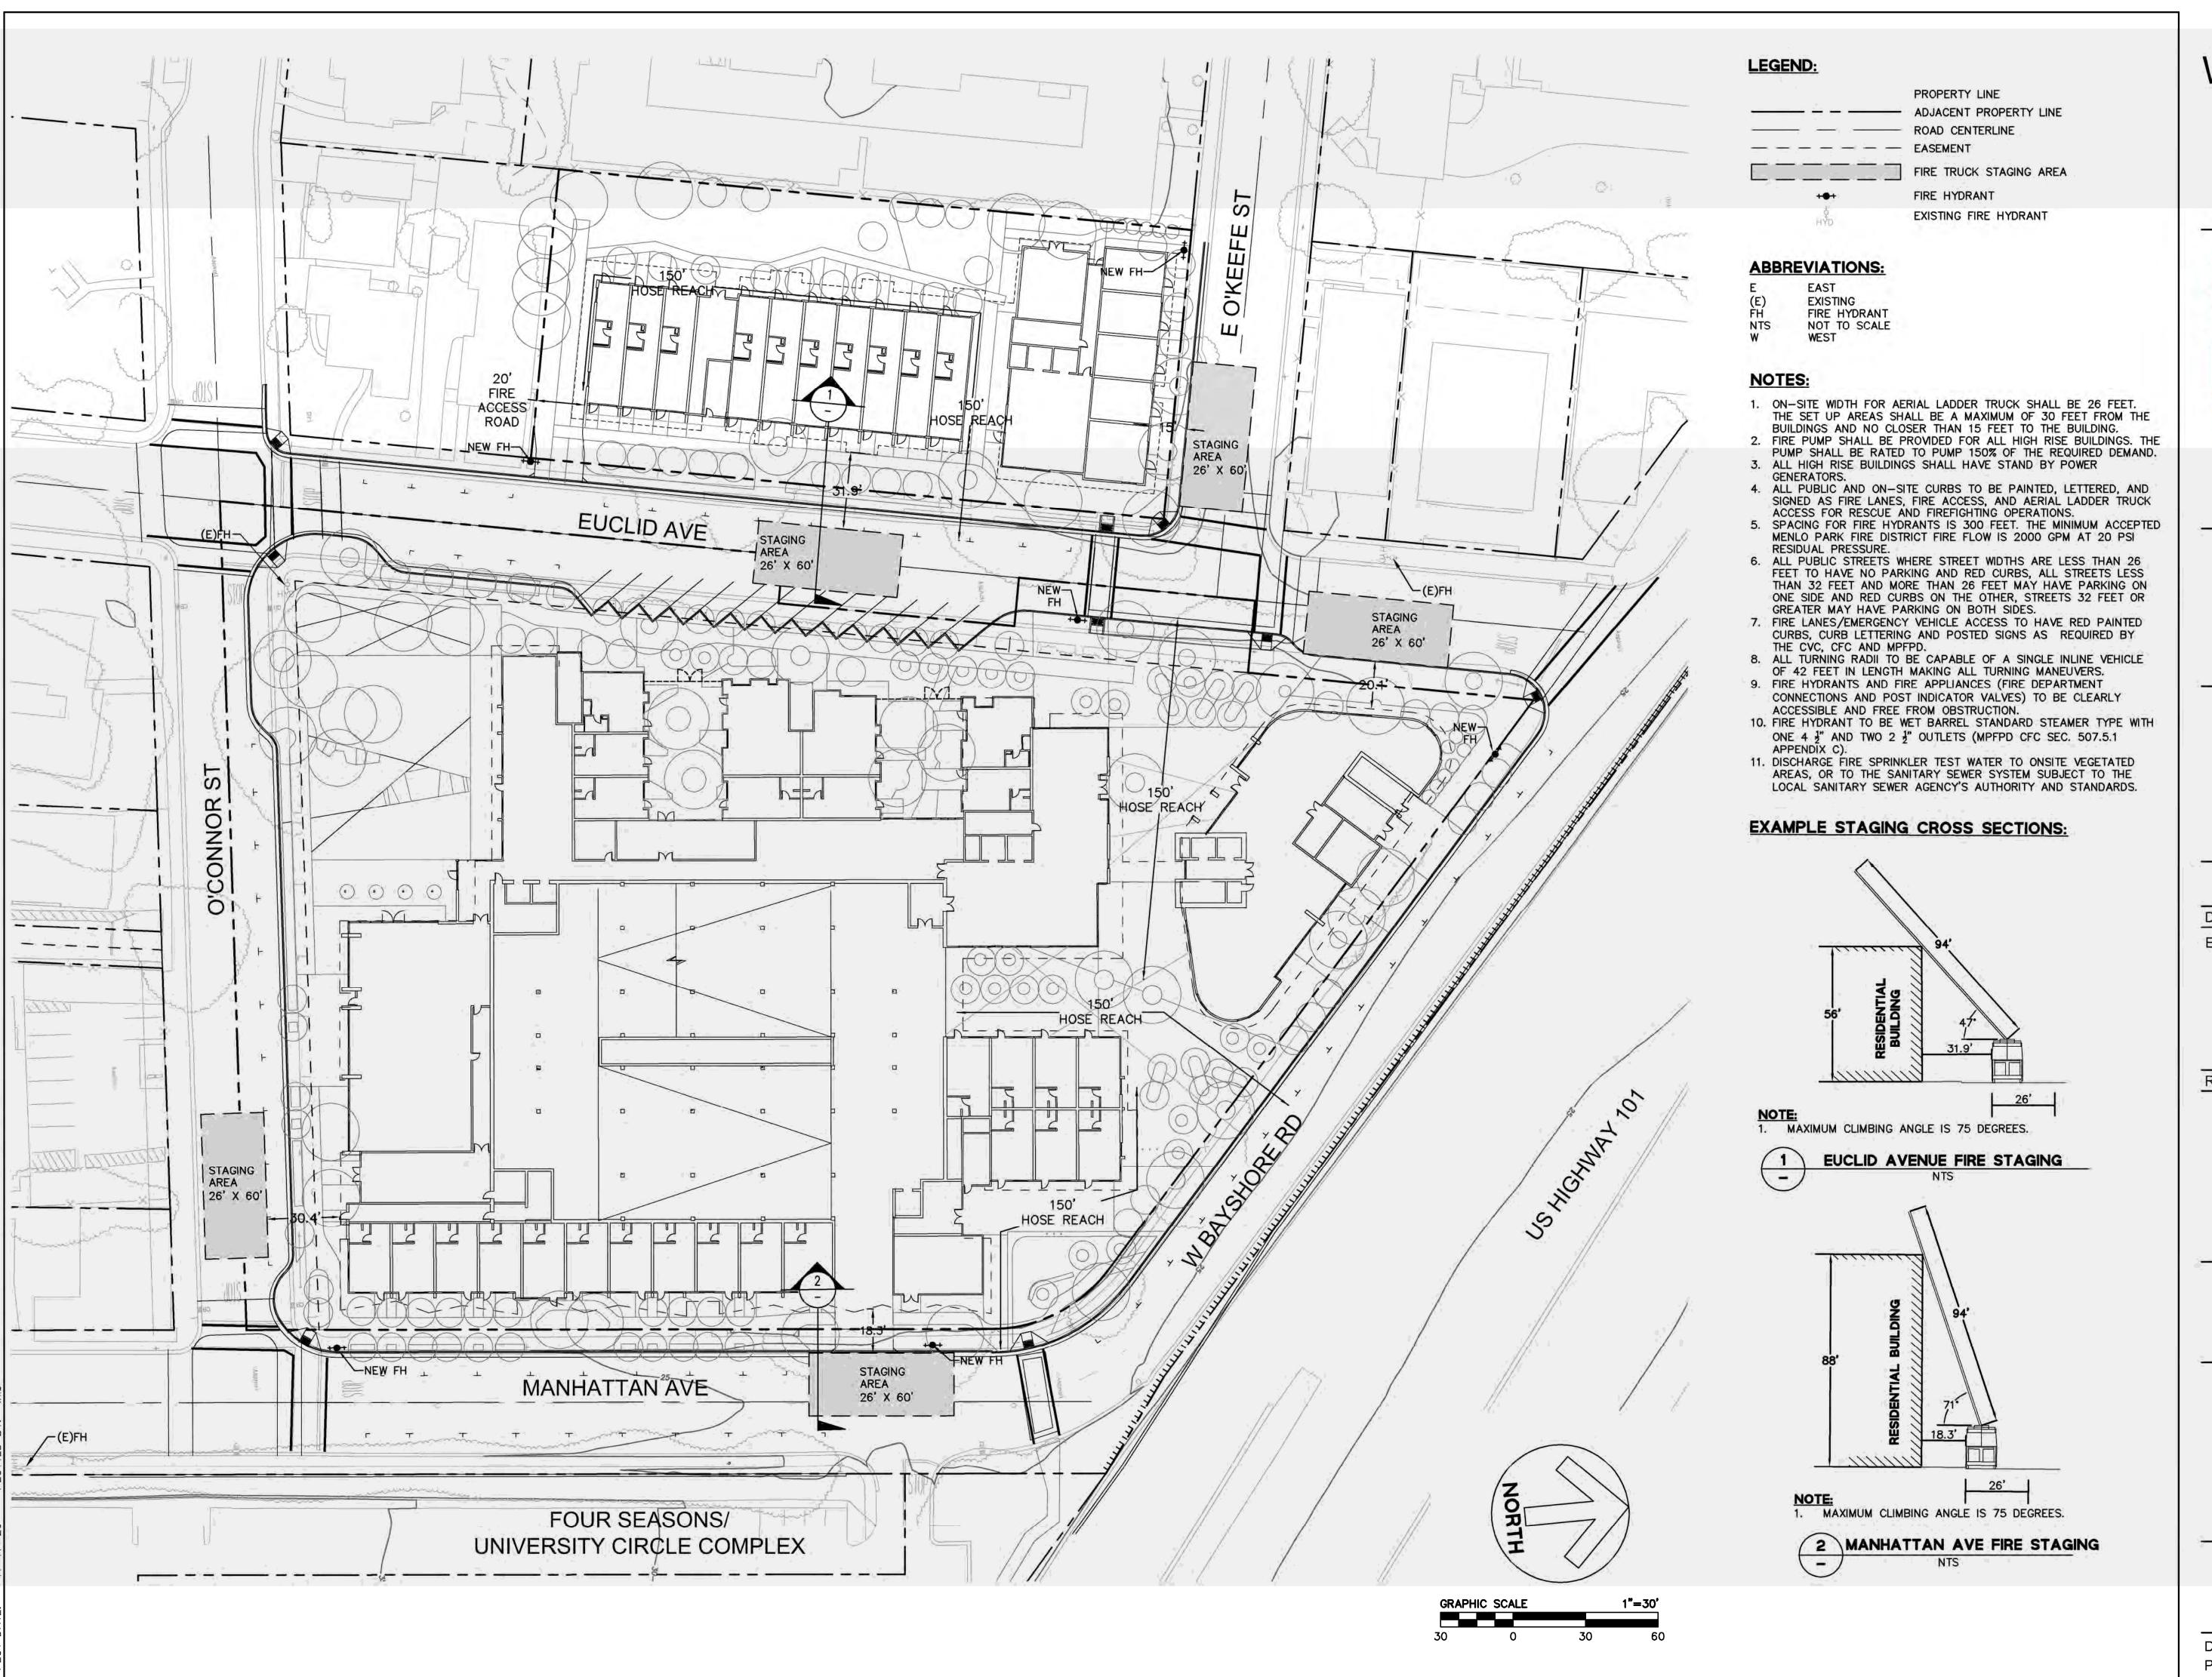

# Euclid Improvements



## **BKF ENGINEERS**

www.bkf.com 1730 N. First Street, Suite 600 San Jose, CA 95112 408.467.9100

License Stamp

Description Date

Entitlements Submission 09/25/2019

Revisions

Rev. Description Date

Application - September 2019

Drawing Title

PRELIMINARY FIRE ACCESS PLAN

Sheet No.

C6.0

 Date
 2020-11-17

 Project No.
 20166089-20

