WOODLAND PARK - EUCLID IMPROVEMENTS



PROJECT DIRECTORY

APPLICANT:

Woodland Park Communities 5 Newell Court East Palo Alto, CA 94303 ATTN: Michael Kramer mkramer@wlpcommunities.com

ARCHITECT:

David Baker Architects 461 2nd Street, Loft C-127 San Francisco, CA 94107 ATTN: Daniel Simons danielsimons@dbarchitect.com

LANDSCAPE ARCHITECT:

Hood Design Studio 3016 Filbert Street #2 Oakland, CA 94608 ATTN: Alma du Solier alma@hooddesignstudio.com

CIVIL ENGINEER:


BKF Engineers 150 California Street, Ste 600 San Francisco, CA 94111 ATTN: Cole Gaumnitz cgaumnitz@bkf.com

PROJECT DESCRIPTION

With <u>no displacement</u>, this project proposes the replacement of several aging, outdated structures containing 160 rent-stabilized housing units and one single family rental (non-RSO) with new mixed-income buildings containing 605 apartments, 26% of which will be deed-restricted rentcontrolled, replacing the existing apartments one-for-one.

Note: No portion of the property is located in a Flood Zone as designated by the Federal Emergency Managment Agency (FEMA).

VICINITY MAP

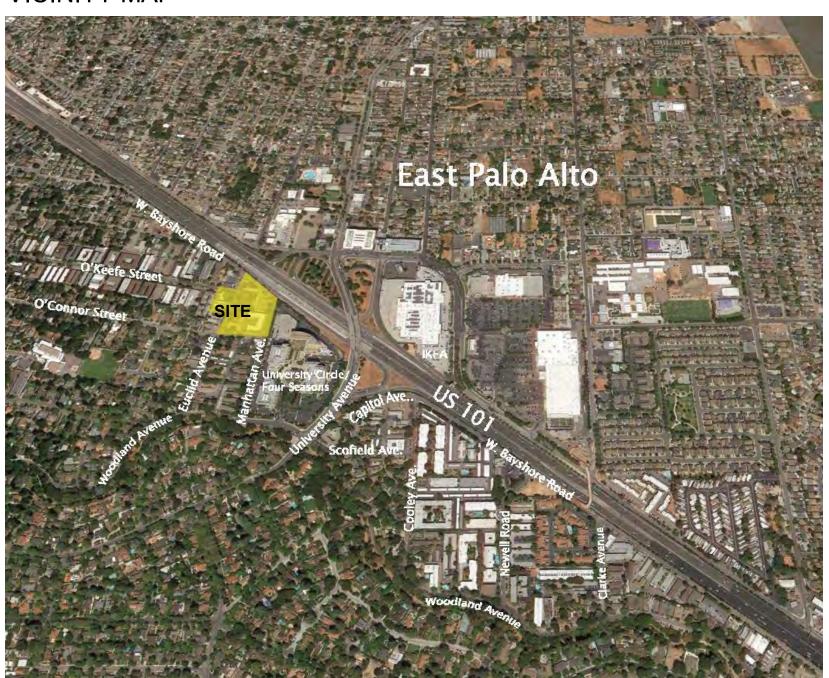

PROJECT SITE

ZONING: R-HD-5, R-UHD

GENERAL PLAN DESIGNATION: HIGH DENSITY RESIDENTIAL /

URBAN RESIDENTIAL

TOTAL SITE AREA:

170.941 SF = 3.92 ACRES

EXISTING LOTS:

ADDRESSES: 063282010 501 O'Connor St. 2012 Euclid Ave. 063282020 063282030 2032 Euclid Ave. 063282040 2036 Euclid Ave. 2040 & 2042 Euclid Ave. 063282050 2044 Euclid Ave. 2054 Euclid Ave. 2033 Manhattan Ave. 063282080 2001 Manhattan Ave. 063282090 2021 Euclid Ave. 063281020 2025 Euclid Ave. 063281030 2031 Euclid Ave. 063281040 063281100 2043 Euclid Ave. 2041 Euclid Ave./420 E O'Keefe St.

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GENERAL

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TYPICAL UNIT PLANS - BUILDING A TYPICAL UNIT PLANS - BUILDING B

TYPICAL UNIT PLANS - BUILDING C UNIT PRECEDENTS

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LANDSCAPE

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TREE PROTECTION & REMOVAL PLAN

CIVIL

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PRELIMINARY GRADING AND DRAINAGE PLAN

PRELIMINARY UTILITY PLAN

PRELIMINARY STORMWATER MANAGEMENT PLAN PRELIMINARY STORMWTER MANAGEMENT PLAN

PRELIMINARY FIRE ACCESS PLAN

VESTING TENTATIVE PARCEL MAP - TITLE SHEET **VESTING TENTATIVE PARCEL MAP - MAPPING** SHEET

OTHER

WT-001 WATER TANK EXHIBIT

GROSS AREAS

UNIT MIX

TYPE	CURRENT*	MIX	PROPOSED	MIX	AVG. AREA
STUDIO	53	33%	228	38%	405 sf
1 BR	102	64%	197	33%	650 sf
2 BR	4	2%	178	29%	960 sf
3 - 4 BR	2	<1%	2	<1%	1,825 sf
TOTAL	161		605		

* There are 160 current rent-stabilized units and one 2 BR single-family rental (non-RSO)

STALLS	CURRENT	PROPOSED
OFF-STREET	155	625
ON-STREET	52	52

(17 of the proposed spaces are ADA, including 2 ADA Van spaces) Parking Ratio = 1.03 spaces/unit

BUILDING A (@ O'KEEFE ST.): 72 STALLS BUILDING B (@ EUCLID AVE.): 108 STALLS BUILDING C (@ W.BAYSHORE RD.): 144 STALLS TOTAL: 324 STALLS

CLASS II: 45 STALLS

LOT COVERAGE CALCULATIONS

TOTAL SITE AREA = 31,596 SF + 139,345 SF = 170,941 SF

TOTAL BUILDING FOOTPRINT AREA = 13,870 SF + 73,725 SF = 96,860 SF

LOT COVERAGE = 96,860 / 170,941 SF = **57%**

(PER DEVELOPMENT CODE SECTION 18.10 TABLE 2-2)

PROJECT DATA

TYPE	CURRENT*	MIX	PROPOSED	MIX	AVG. AREA
STUDIO	53	33%	228	38%	405 sf
1 BR	102	64%	197	33%	650 sf
2 BR	4	2%	178	29%	960 sf
3 - 4 BR	2	<1%	2	<1%	1,825 sf
TOTAL	161		605		

PARKING

BIKE PARKING

F.A.R. REQUIRED: N/A

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Woodland Park

Improvements

Euclid

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TITLE SHEET

G000

08-23-2022 Project No. 21620



1 - Intersection of West Bayshore Road and Euclid Avenue, Looking East



2 - West Bayshore Road, Looking East




3 - Intersection of West Bayshore Road and Manhattan Avenue, Looking South




4 - Intersection of Manhattan Avenue and O'Connor Street, Looking North




5 - Manhattan Avenue, Looking North

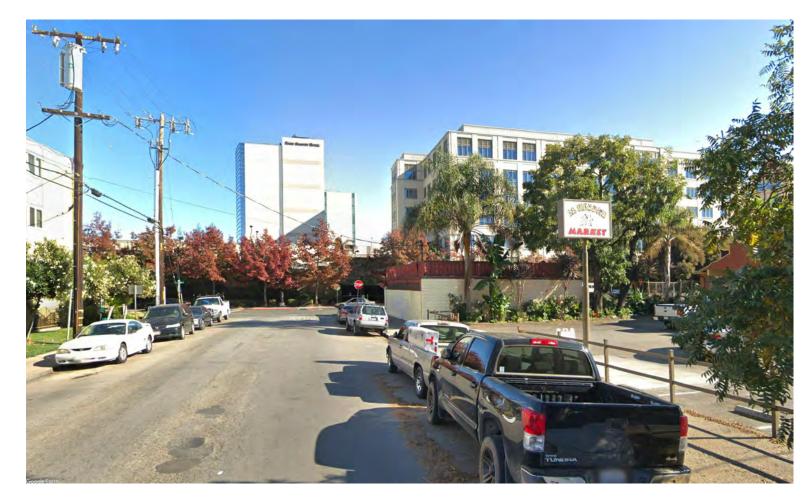



6 - O'Connor Street, Looking East

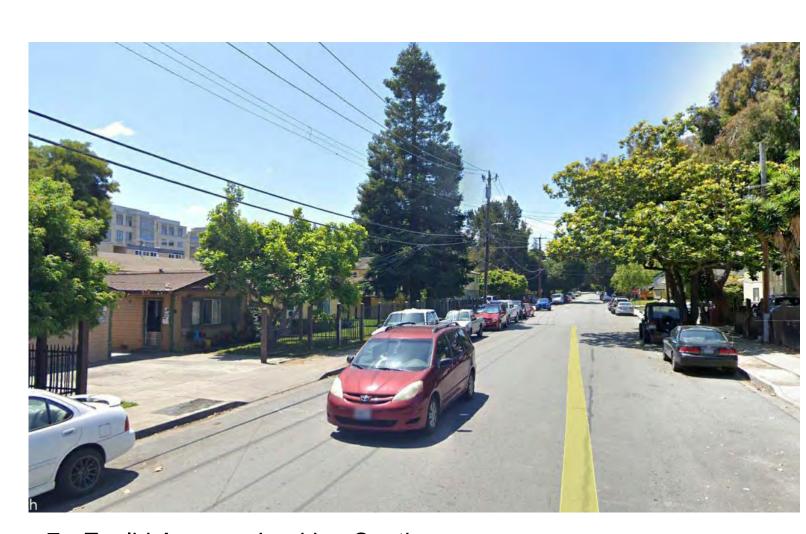

7 - Euclid Avenue, Looking South

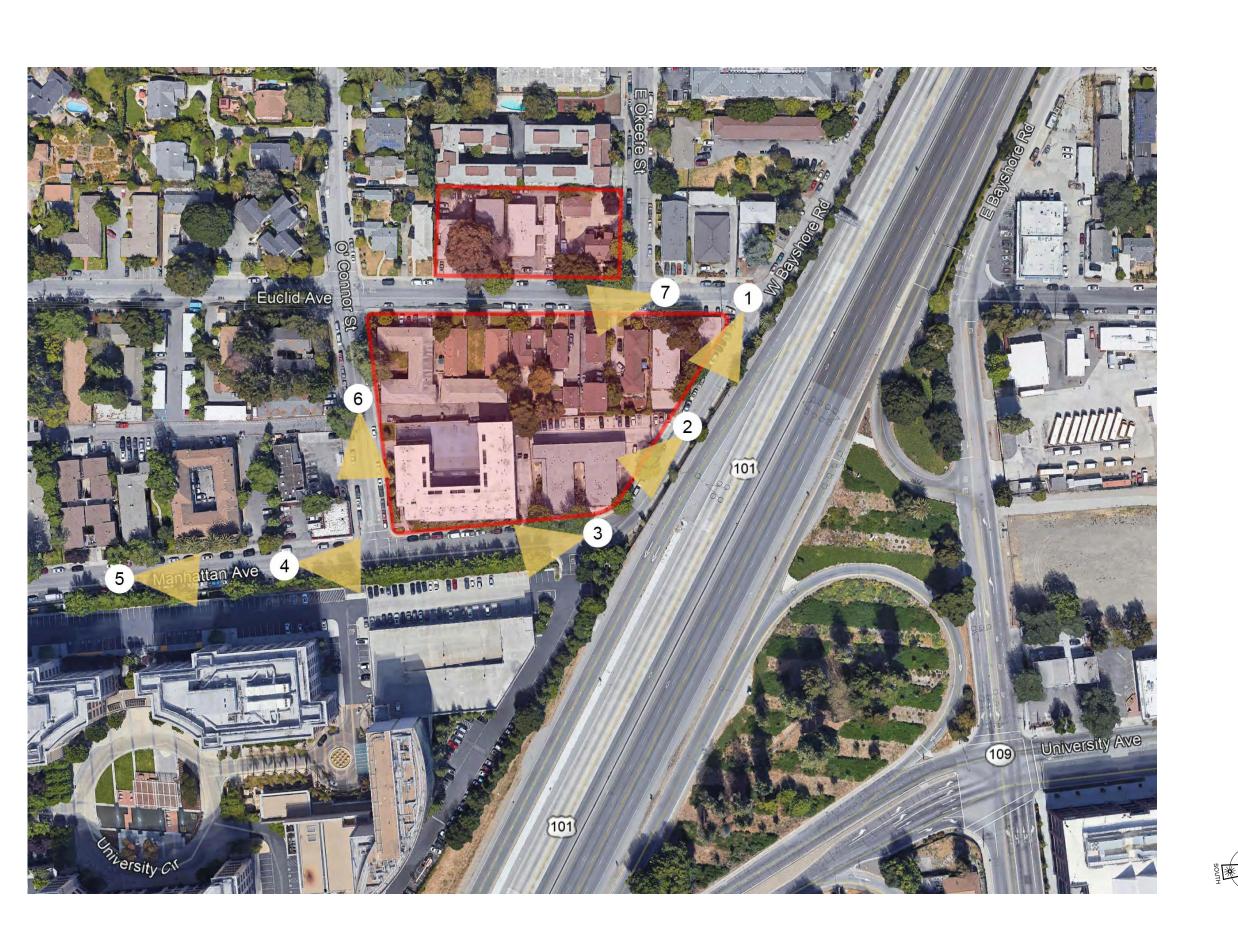

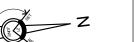

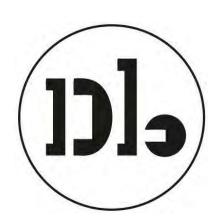

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CONTEXT

Sheet No.

1- VIEW OF PARK FROM O'CONNOR ST.



2- VIEW OF EUCLID LOOKING TOWARDS O'KEEFE ST.



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PERSPECTIVE **VIEWS**


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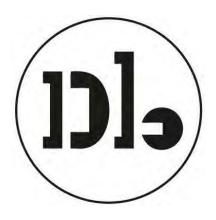
MANHATTAN AVE.

KEY PLAN

1- VIEW DOWN EUCLID AVE. LOOKING NORTH



2- VIEW FROM US 101/ UNIVERSITY AVE OVERPASS (FOUR SEASONS HOTEL IN FOREGROUND)

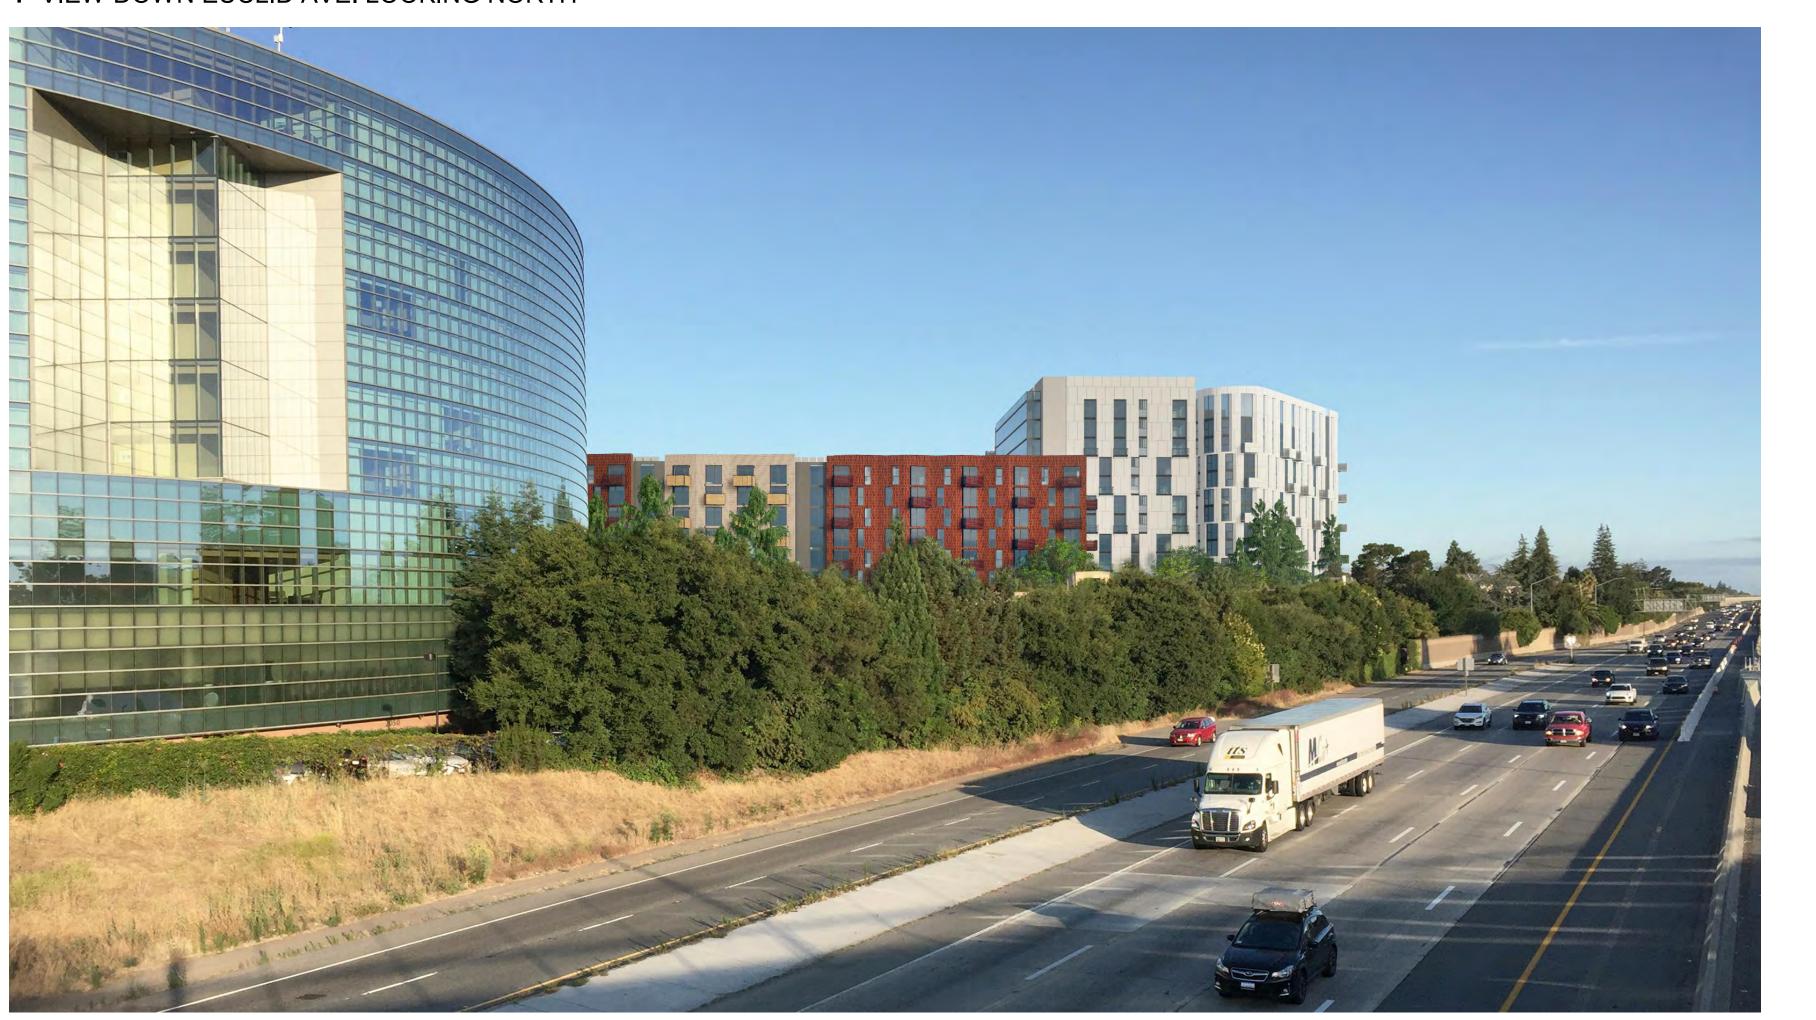

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PERSPECTIVE VIEWS

EUCLID AVE.

MANHATTAN AVE.

KEY PLAN

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PROJECT



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AERIAL VIEW

Sheet No

G103

RED DASH: 150' ACCESS ____Level <u>5</u> - C______ _____ -__<u>Level 4</u> -<u>C</u>___ 125' - BUILDING A : AERIAL ACCESS LANE REQUIRED 15'-30' FROM BUILDING PER CFC FIRE APPARATUS SECTION D105 ROAD UNOBSTRUCTED AREA REQUIRED: 20' WIDE BY 13'-6" HIGH PER CFC 503.2.1 **BUILDING A** 1/16" = 1'-0" SECTION - FIRE LANE - BUILDING A **EXISTING FIRE** HYDRANT -EXISTING FIRE -HYDRANT FIRE APPARATUS ACCESS LANE RED DASH: 150' ACCESS EUCLID AVENUE PROPOSED FIRE HYDRANT PROPOSED FIRE HYDRANT RED DASH: 150' ACCESS <u>Level 1 - A</u> 0' - 0" 7' 3' 4' 8' 4' E RÈMOTENESS ØFC D106.3 T BE GREATER THAN (1/2 OF THE AREA TO BE SERVED) **BUILDING C** 26' SIDEWALK -1/16" = 1'-0" SECTION - FIRE DIAGRAM @ E. O'KEEFE SETBACK VARIES (MOST CONSERVATIVE CONDITION SHOWN) **BUILDING B** BUILDING C IS HIGH RISE THEREFORE FIRE SERVICE ELEVATOR PROPOSED AS ALTERNATIVE TO AERIAL APPARATUS ACCESS LANE (SEE SHEET A201 FOR LOCATION) (2) G200) - 3 HR FIRE SEPARATION BETWEEN BUILDINGS B & C PROPOSED FIRE HYDRANT Level 4 30' - 0" – PROPOSÉD //FIRE HYDRANT AERIAL APPARATUS ACCESS LANE MANHATTAN AVE. BUILDING B: GREATER THAN 200 UNITS, 2 FIRE APPARATUS ____ACCESS LANES REQUIRED__ | PER CFC SECTION D106 (MANHATTAN & EUCLID AVE) -Level 1 0' - 0" 8' 8' 4' 8' 4' 15' FOUR SEASONS / UNIVERSITY CIRCLE COMPLEX ACCESS LANE PARKING LANE 1" = 30'-0" 1/16" = 1'-0" Date SECTION - FIRE DIAGRAM @ MANHATTAN FIRE DIAGRAM 3

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FIRE DIAGRAMS

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CODE ANALYSIS - GENERAL

G201



Existing properties:

2021 Euclid Avenue

11 x Studio Units

2025 Euclid Avenue (7 rent-stabilized units)

6 x Studio Units 1 x 1 Bedroom Unit

2031 Euclid Avenue (12 rent-stabilized units)

12 x 1 Bedroom Units

2032 Euclid Avenue

1 x 2 Bedroom Single-Family-House (non-RSO)

2036 Euclid Avenue (4 rent-stabilized units)

2 x Studio Units 1 x 1 Bedroom Unit

2040 & 2042 Euclid Avenue (2 rent-stabilized units)

1 x 2 Bedroom Unit 1 x 4 Bedroom Unit

2041 Euclid Avenue (also known as 420 O'Keefe)

Community Engagement Office

2043 Euclid Avenue

Resident Services Office and Community Technology Center

2044 Euclid Avenue (2 rent-stabilized units)

1 x 2 Bedroom Unit 1 x 3 Bedroom Unit

2054 Euclid Avenue (8 rent-stabilized units)

8 x 1 Bedroom Units

2012 Euclid Avenue/501 O'Connor Street

(22 rent-stabilized units)


22 x 1 Bedroom Units

2001 Manhattan Avenue (60 rent-stabilized units)


8 x Studio Units 52 x 1 Bedroom Units

2033 Manhattan Avenue (32 rent-stabilized units)

26 x Studio Units 6 x 1 Bedroom Units

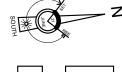

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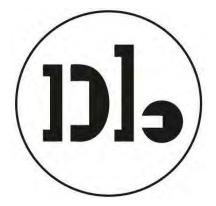
SITE PLAN -**EXISTING**
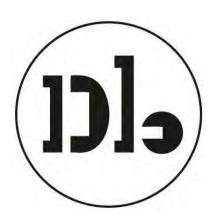
> Sheet No. A100

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ST. O'KEEFE LOBBY/ COMMON 2 BR EUCLID AVENUE SEE LANDSCAPE PLANS FOR NEW SURFACE TREATMENTS, PLANTINGS AND SITE ELEMENTS SETBACK SETBACK - PROPERTY BOUNDARIES NEW BUS STOP DROP-OFF / LOADING AREA HATCHED REGION INDICATES PROPOSED R.O.W. DEDICATION COWORKING LIBRARY 1 BR TH LOBBY/ LOUNGE PKG RM. O'CONNOR ST 1 BR TH 1 BR TH 1 BR TH SHICKMEN TRASH 1 BR TH 1 BR 1 BR TH TH THINNER DASHED LINE INDICATES BUILDING OVERHANG ABOVE 8' SETBACK RED FILL REGIONS INDICATE CORNER VISION TRIANGLE MANHATTAN AVE. FOUR SEASONS / UNIVERSITY CIRCLE COMPLEX

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SITE PLAN -PROPOSED

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Z Z

0' 7.5' 15' 30'



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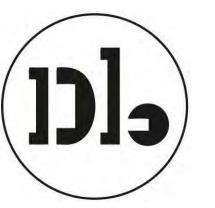
FLOOR PLAN -BASEMENT

Sheet No.

A200

SERVICE 292 SF ST. LOBBY/ COMMON 1361 SF EUCLID AVENUE NEW BUS STOP DROP-OFF / LOADING AREA GAMES COWORKING LIBRARY 2777 SF PLAZA SERVICE ACCESS ELEV. **LOBBY** 1572 SF W.c. PLAZÅ O'CONNOR ST. COMMUNITY SPACE 2560 SF SKICHIKAON SERVICE 858 SF 1 BR TH 1 BR 1 BR TH TH 1 BR 1 BR TH TH MANHATTAN AVE. 24' - 0" 37' - 6" 263' - 0" FOUR SEASONS / UNIVERSITY CIRCLE COMPLEX

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FLOOR PLAN -LEVEL 1

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A201

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0' 7.5' 15' 30'





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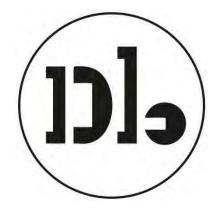
FLOOR PLAN -LEVEL 2

Sheet No.

A202

243' - 0" EUCLID AVENUE 66' - 0" 135' - 3" M. BASHOPLIA PARKING GARAGE ROOF TERRACE MANHATTAN AVE. 269' - 4" FOUR SEASONS / UNIVERSITY CIRCLE COMPLEX

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FLOOR PLAN -LEVELS 3

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A203





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FLOOR PLAN -LEVELS 4-9

Sheet No.

A204





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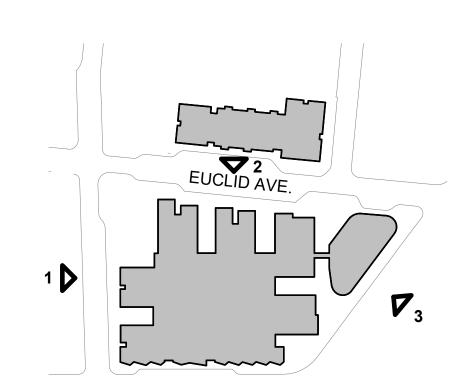
FLOOR PLAN -LEVELS 10-13

Sheet N

A205

MATERIAL LEGEND


- 1 Textured Concrete with Vine Cover
- 2 Vertical Wood Siding
- 3 Storefront System
- 4 Cement Board (Dark)
- 5 Cement Board (Light)
- 6 Perforated Metal Screen (Painted) 7 - GFRC
- 8 Thin Brick
- 9 Aluminum Windows
- 10 Balconies with Perforated Metal Guardrails
- 11 Corten Steel Panels
- 12 Smooth Concrete
- 13 Metal Sunshade



MANHATTAN AVE.

Key Plan
1" = 160'-0"

NOTE: PLEASE REFER TO LANDSCAPE PLAN FOR PLANTING LOCATIONS

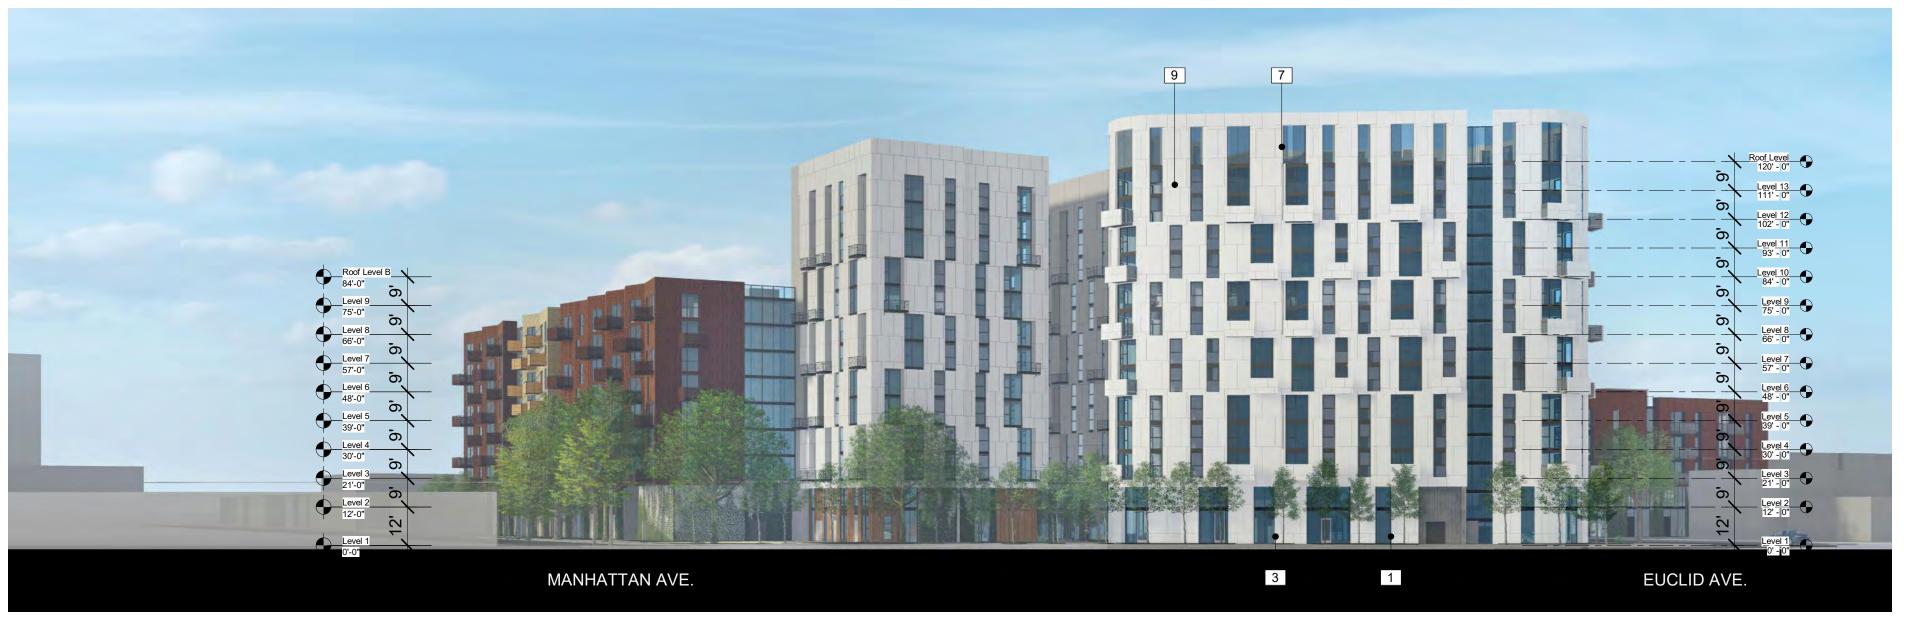

W. Bayshore Rd. Elevation - East Building
1" = 30'-0"




2 Euclid Ave. Elevation - East Building
1" = 30'-0"



O'Connor St. Elevation - East Building
1" = 30'-0"

Woodland Park Euclid Improvements

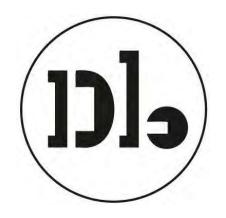

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> **Drawing Title** BUILDING **ELEVATIONS**

> > A300

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MATERIAL LEGEND


- 1 Textured Concrete with Vine Cover
- 2 Vertical Wood Siding 3 Storefront System 4 Cement Board (Dark)

- 5 Cement Board (Light)
- 6 Perforated Metal Screen (Painted)
- 7 GFRC
- 8 Thin Brick
- 9 Aluminum Windows
- 10 Balconies with Perforated Metal Guardrails
- 11 Corten Steel Panels12 Smooth Concrete13 Metal Sunshade




Key Plan
1" = 160'-0"

NOTE: PLEASE REFER TO LANDSCAPE PLAN FOR PLANTING LOCATIONS

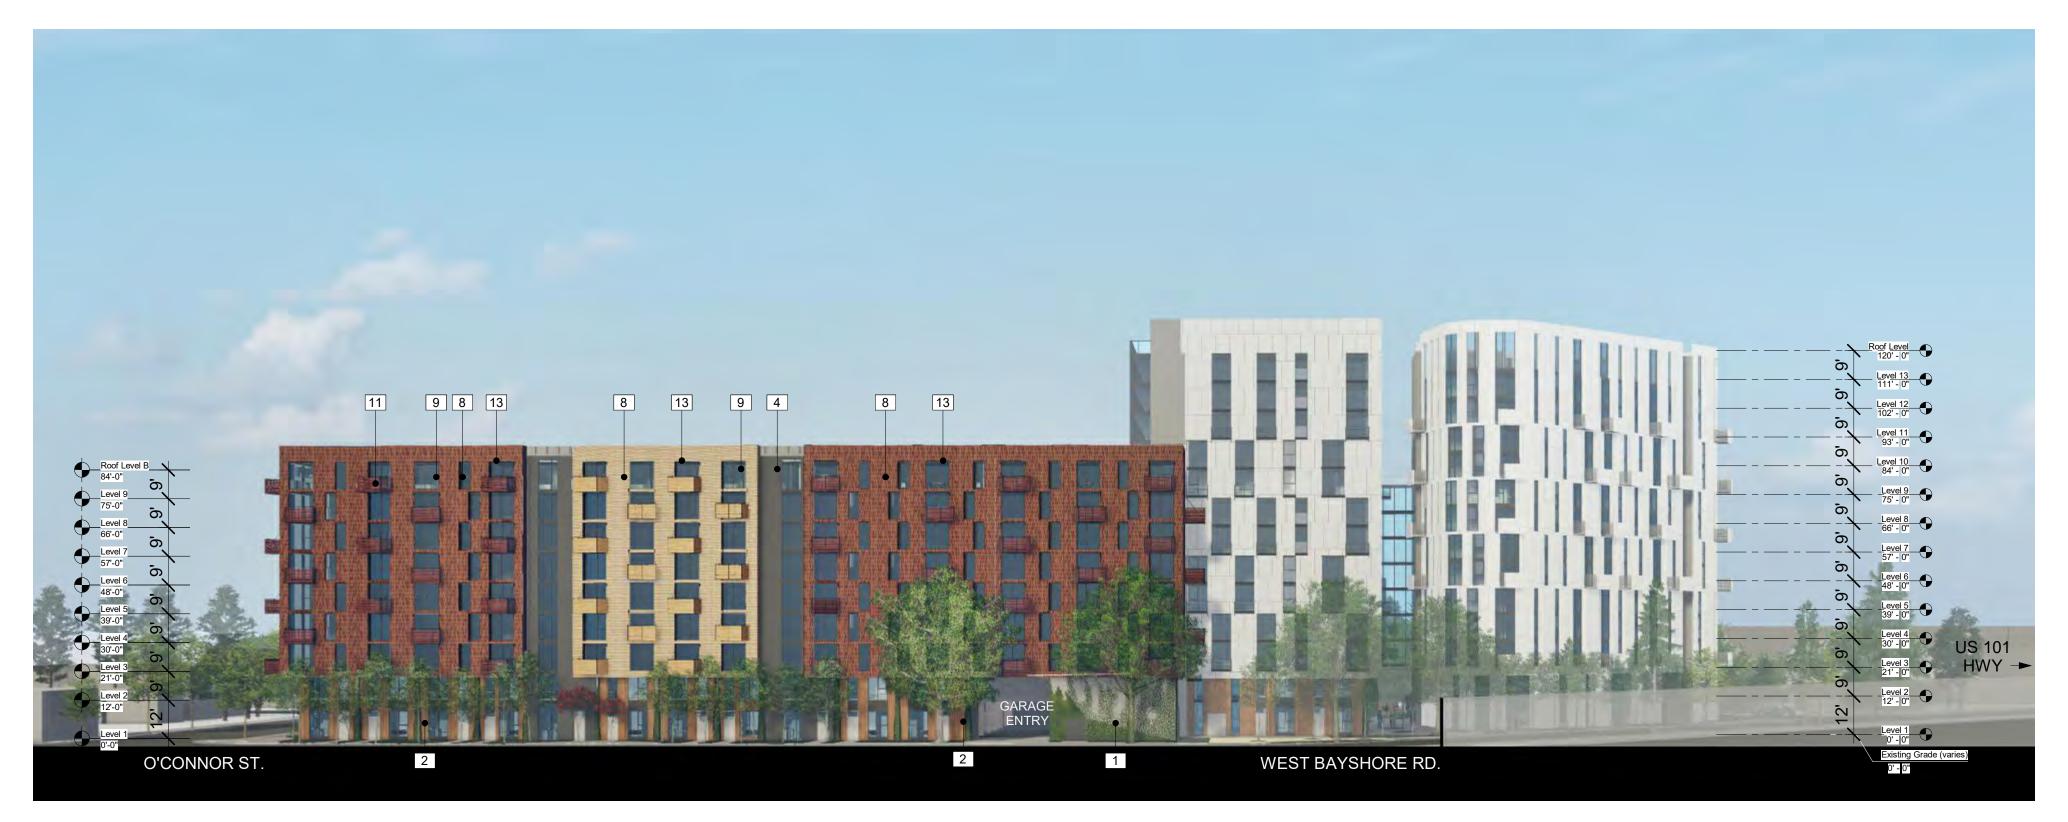

Manhattan Ave. Elevation - East Building
1" = 30'-0"




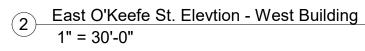



1 Euclid Ave. Elevation - West Building
1" = 30'-0"

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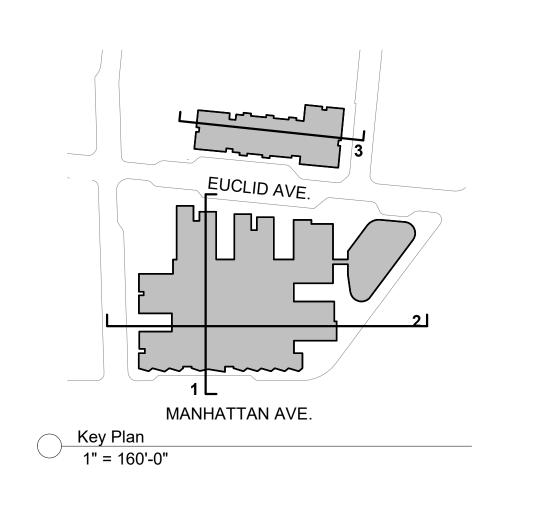
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> **Drawing Title** BUILDING **ELEVATIONS**
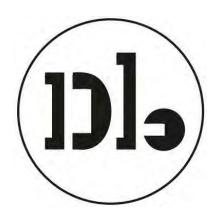
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Building Section - N/S West Building
1" = 30'-0"




2 Building Section - N/S 1" = 30'-0"



1 Building Section - E/W 1" = 30'-0"

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Drawing Title
BUILDING
SECTIONS

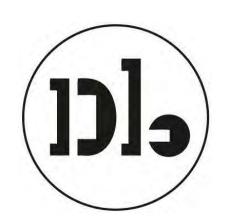Sheet No. A302

1 - Textured Concrete with Vine Cover




2 - Vertical Wood Siding



3 - Storefront System


7 - GFRC

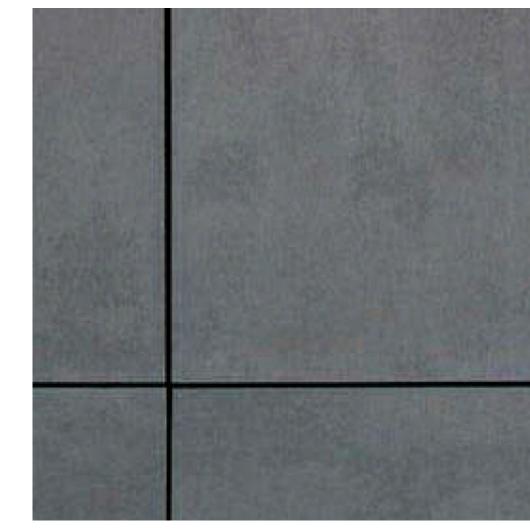

4 - Cement Board (Dark)



8 - Thin Brick

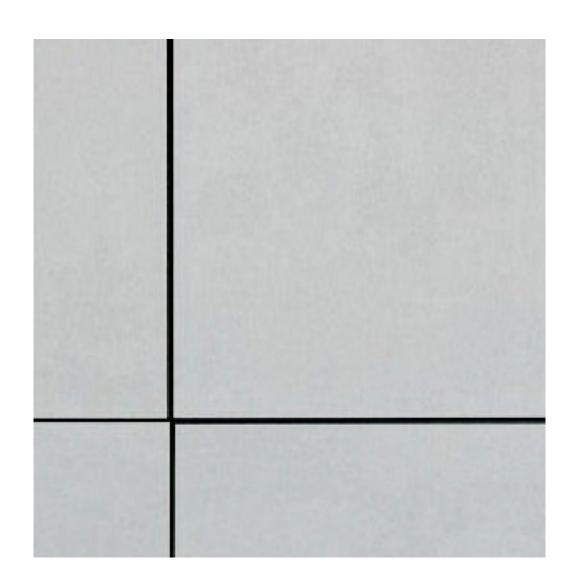

5 - Cement Board (Light)

9 - Aluminum Windows




6 - Perforated Metal Screen (Painted)

10 - Balconies with Perforated Metal Guardrails




11 - Corten Steel Panels

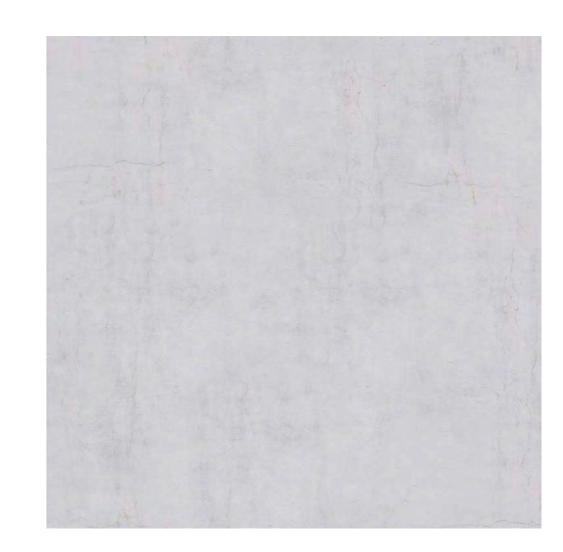

12 - Smooth Concrete

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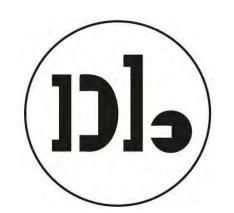
EXTERIOR MATERIALS

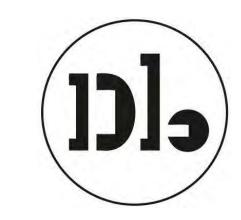A303

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5' - 7" 17' - 0" 13' - 0" 17' - 0" 13' - 0" 1/4" = 1'-0" 1/4" = 1'-0" 1/4" = 1'-0" 2 BR TOWNHOME - LEVEL 2 (BLDG A) 1 BR TOWNHOME - LEVEL 2 (BLDG A) 1 BR TOWNHOME - LEVEL 1 (BLDG A) 2 BR TOWNHOME - LEVEL 1 (BLDG A) 5

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TYPICAL UNIT PLANS -BUILDING A


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Project No. 21620	Date	08-23-2022
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38' - 0" 7' - 0" 7' - 0" 5' - 2" 5' - 2" 11' - 11" 10' - 0" 2' - 0" 11' - 11" 1/4" = 1'-0" TWO TYPICAL NESTED 1 BEDROOM UNITS (BLDG A) 17' - 4" 2' - 0" 10' - 0" 13' - 4" 10' - 3" 1' - 11 3/4" 9' - 8" 7' - 0" 1/4" = 1'-0" 3/16" = 1'-0" 2 BR - TYPICAL UPPER LEVELS (BLDG A) 5 STUDIO - TYPICAL UPPER LEVELS (BLDG A)

Woodland Park Euclid Improvements



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		Revisions
Rev.	Description	Date
1 R	esponse to Comments	11-20-2020

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Application -September 2019

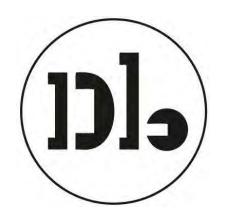
Drawing Title

TYPICAL UNIT PLANS -BUILDING A

Sheet No

A401



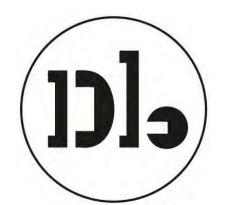

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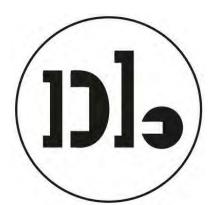
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TYPICAL UNIT PLANS -BUILDING B

Sheet No

A402





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Rev	٧.	Description	Date
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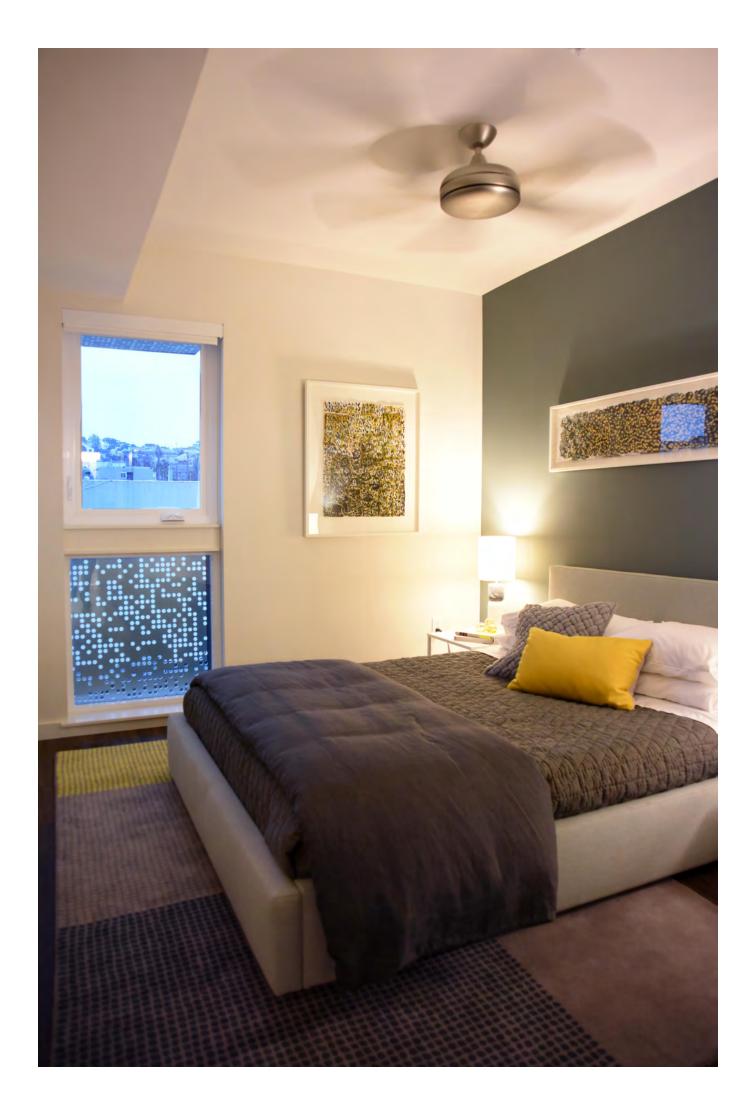
Application -September 2019

Drawing Title


TYPICAL UNIT PLANS -BUILDING C

Sheet No


A403




1 & 2 BR UNITS

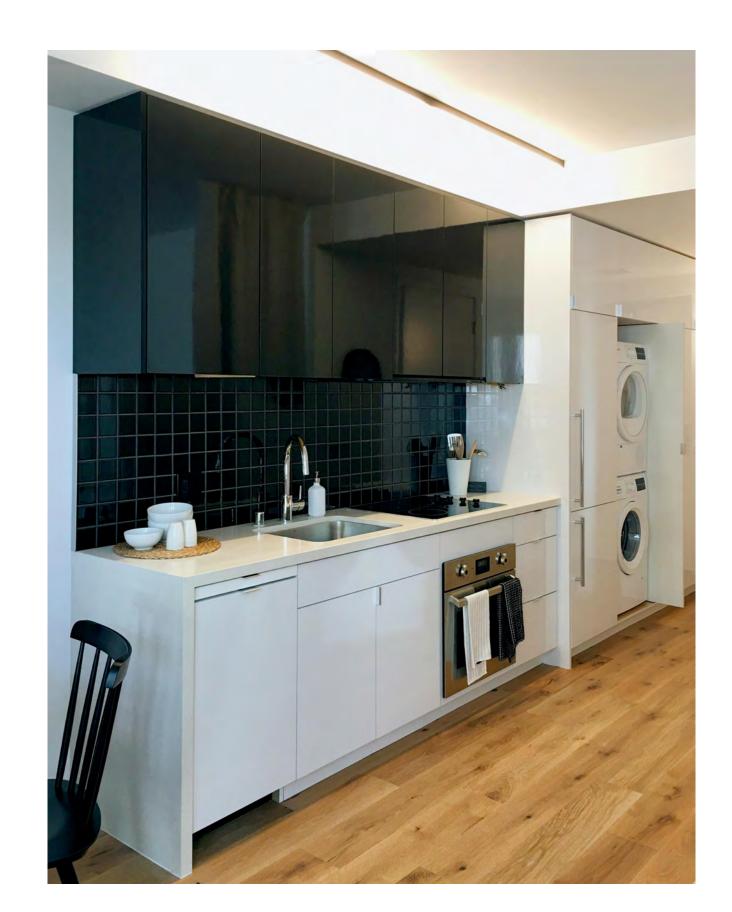



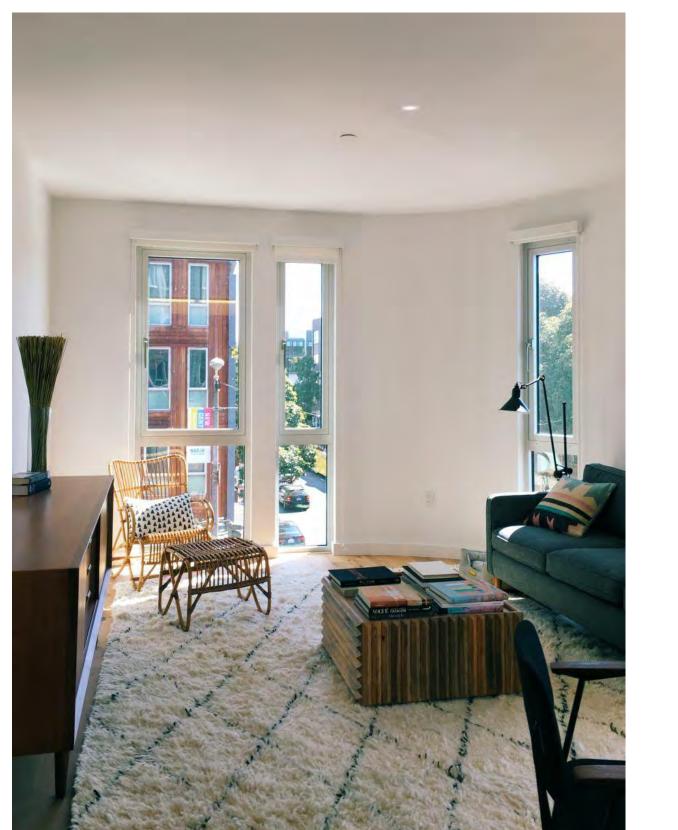

STUDIO UNITS

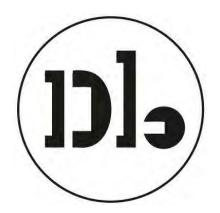

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UNIT **PRECEDENTS**

A404

08-23-2022 21620 Date Project No.

OPEN SPACE -COMMON OPEN SPACE COMMON 1241 SF FLEX SPACE FLEX SPACE CORNER PARK OPEN SPACE PUBLIC 9355 SF ENTRY PLAZA OPEN SPACE - PUBLIC 15169 SF 4 OPEN SPACE -COMMON 2294 SF OPEN SPACE -— PUBLIC OPEN SPACE COMMON 1131 SF 1 LEVEL 1 PLAN - OPEN SPACE DIAGRAM

1" = 40'-0"



EAST PALO ALTO DEVELOPMENT CODE 18.08.010:

Common Open Space. The land area within a residential or nonresidential development not individually owned or dedicated for public use and designed, intended, and reserved exclusively for the shared enjoyment or use by all the residents and their guests. Does not include enclosed spaces/facilities (e.g., community center, meeting rooms, etc.)

Private Open Space. An outdoor or unenclosed area directly adjoining and accessible to a dwelling unit, reserved for the exclusive private enjoyment and use of residents of the dwelling unit and their guests (e.g., balcony, deck, porch, terrace, etc.). Boundaries are evident through the use of fences, gates, hedges, walls, or other similar methods of controlling access and maintaining privacy.

Publicly Accessible / Usable Open Space. An outdoor or unenclosed area within a residential development on the ground, or on a roof, balcony, deck, porch or terrace, designed and accessible for outdoor living, active or passive recreation, pedestrian access, or landscaping. Parking facilities, driveways, utility or service areas and submerged land do not constitute usable open space.

OPEN SPACE - PROVIDED

WEST PARCEL

COMMON:

Level 1	OPEN SPACE - COMMON	13,402 SF
		13,402 SF

PRIVATE:

(BALCONIES)

(DALCONIES)				
Level 3	OPEN SPACE - PRIVATE	15	720 SF	
Level 4	OPEN SPACE - PRIVATE	15	720 SF	
Level 5	OPEN SPACE - PRIVATE	15	720 SF	
		4 =	0.400.05	

EAST PARCEL

COMMON:

Level 1	OPEN SPACE - COMMON	12,851 SF
Level 3	OPEN SPACE - COMMON	2,669 SF
		15.520 SF

PRIVATE:

(BALCONIES)

Level 3	OPEN SPACE - PRIVATE	38	1,711 SF
Level 4	OPEN SPACE - PRIVATE	28	1,280 SF
Level 5	OPEN SPACE - PRIVATE	36	1,569 SF
Level 6	OPEN SPACE - PRIVATE	37	1,727 SF
Level 7	OPEN SPACE - PRIVATE	35	1,540 SF
Level 8	OPEN SPACE - PRIVATE	37	1,733 SF
Level 9	OPEN SPACE - PRIVATE	36	1,570 SF
Level 11	OPEN SPACE - PRIVATE	12	475 SF
Level 13	OPEN SPACE - PRIVATE	1	43 SF
		260	11,647 SF

USABLE / PUBLIC:

Level 1	OPEN SPACE - PUBLIC	27,666 \$
		27.666 \$



HATCHED REGION INDICATES "FLEX" MULTIPURPOSE SPACE


PROJECT TOTAL:

TOTAL OPEN SPACE PROVIDED: 15,562 sf + 54,833 sf = **70,395 SF TOTAL**

- 9,355 SF OF WHICH IS PARK SPACE (COMMUNITY BENEFIT)

= 61,040 SF TOTAL OPEN SPACE (100 SF PER UNIT)

Woodland Park **Euclid** Improvements

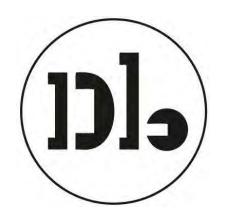

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OPEN SPACE DIAGRAMS


A500

08-23-2022 Project No. 21620


COMMUNITY SPACES/NEIGHBORHOOD SERVING RETAIL




UNIT ENTRIES

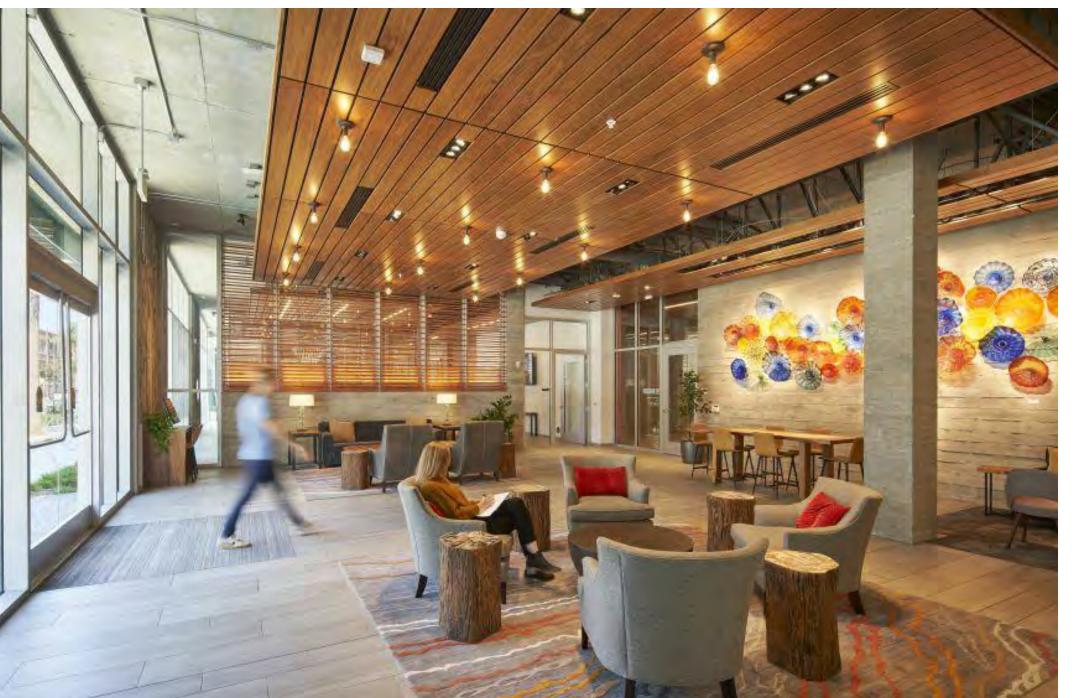




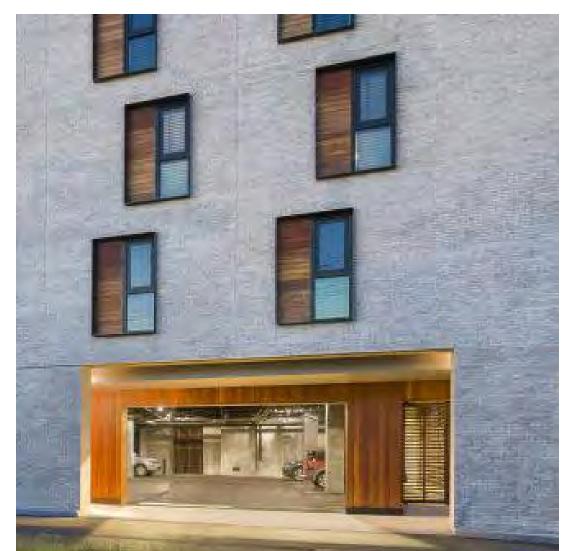

GARAGE ENTRY

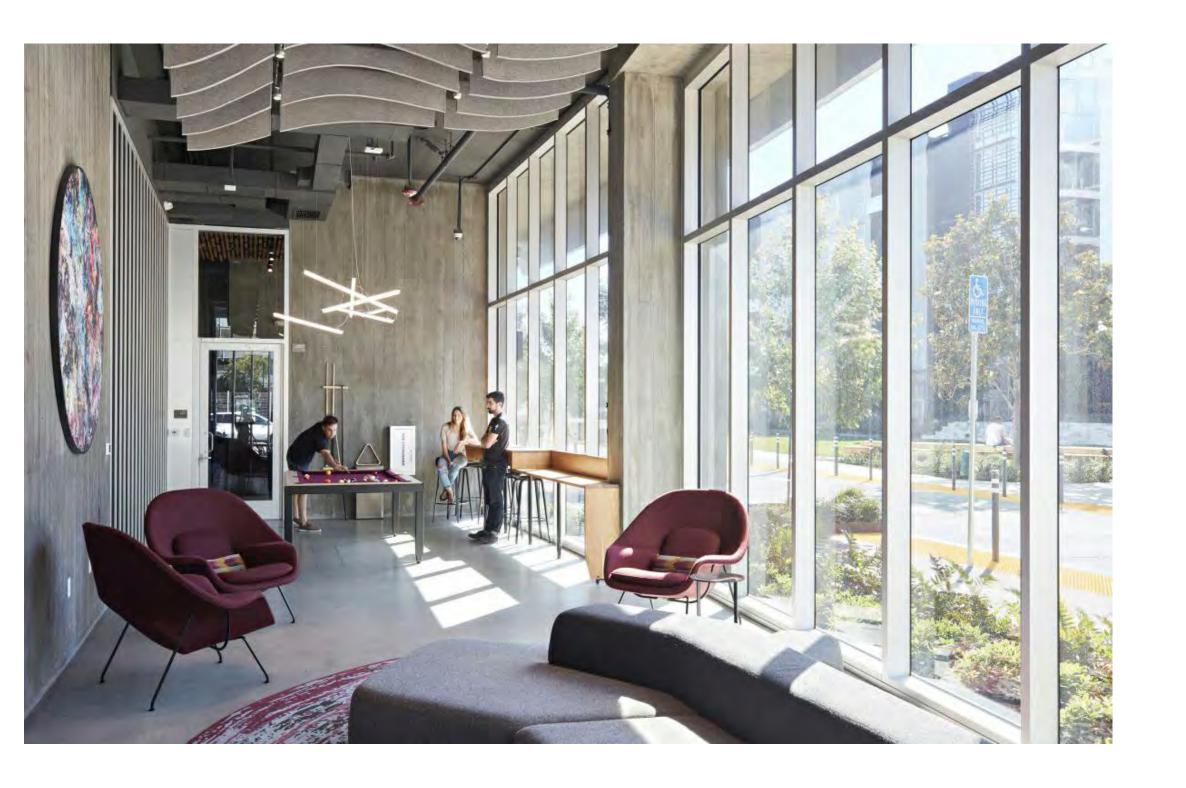

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GROUND FLOOR CHARACTER

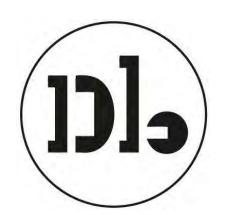A510

Date Project No. 08-23-2022

LOBBY

21620



LEGEND:

PAVIN(
KEY	SYMBOL	DESCRIPTION /
P1		LOCATION DECOMPOSED GRANITE
P2	0 0 0 0 0 0 0 0 0 0 0 0 0 0 0 0	GRAVEL
P3		CIP CONCRETE
P4		ASPHALT BLOCK PAVER
P5		CIP COLORED CONCRETE
P6		STONE PAVERS
P7		ECO GRID PAVERS AT PARKING
<u>FURNI</u>	SHINGS	
KEY	SYMBOL	DESCRIPTION / LOCATION
F1		WOOD BENCH
F2		PICNIC TABLE
F3		BBQ GRILL
F4		CUSTOM PLAY AND SEATING STRUCTURE
F5		CURVED CONCRETE BENCH
F6		GARDEN BED
F7	o	BIKE RACK / BOLLARD
PLANT	LIST	
TREES		
KEY	SYMBOL	COMMON NAME
	And the second s	PROTECTED TREE
FRAM		WHITE ASH
ARMA	\odot	MARINA STRAWBERRY TREE
OLIDO		DILLE OAK

PA PLANTING AREA

QUDO

QUKI

PAPE

BLUE OAK

IRONWOOD

RED PUSH PISTACHE

KINDRED SPIRIT OAK

Woodland Park Euclid Improvements



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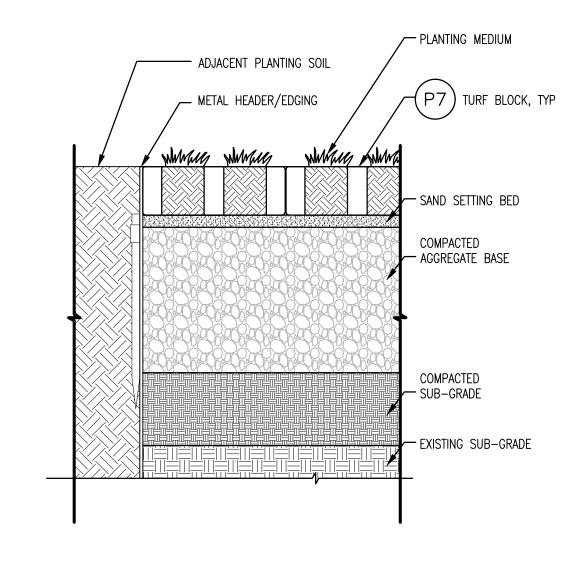
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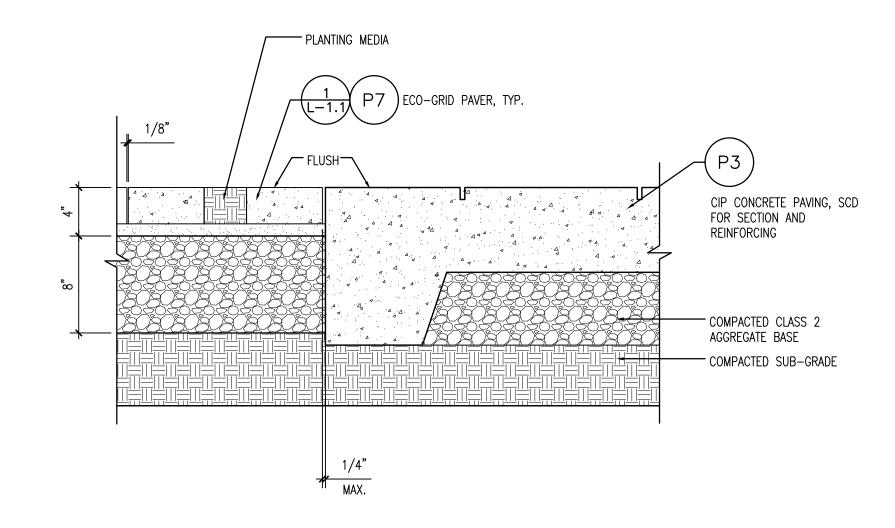
Landscape Site Plan

L-1.0


25 September, 2019 Project No. 21620



5 P7 - ECO-GRID PAVER AT PLANTING SCALE: 1-1/2" = 1' - 0"



4 P7 - ECO-GRID PAVER AT CONCRETE PAVING SCALE: 1-1/2" = 1' - 0"

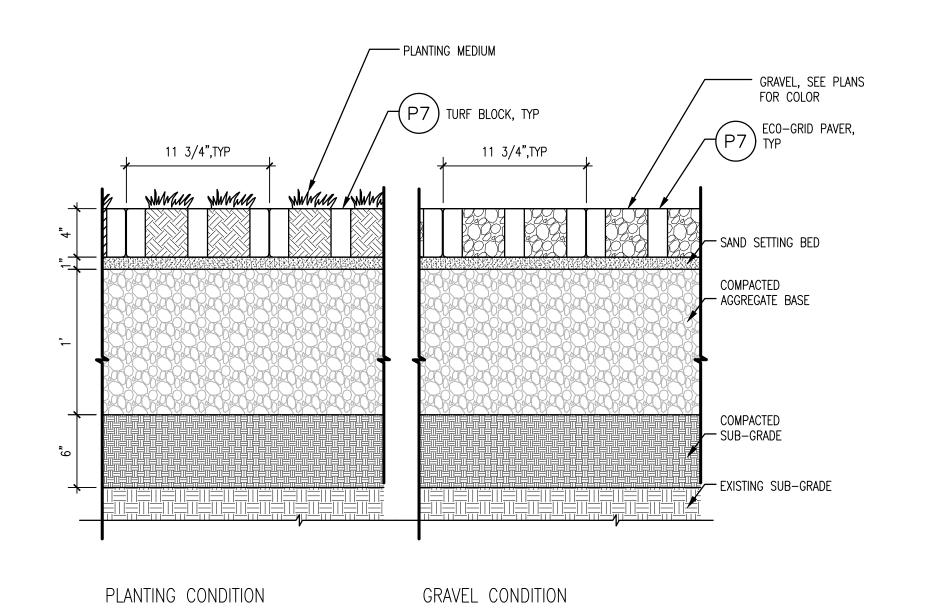


















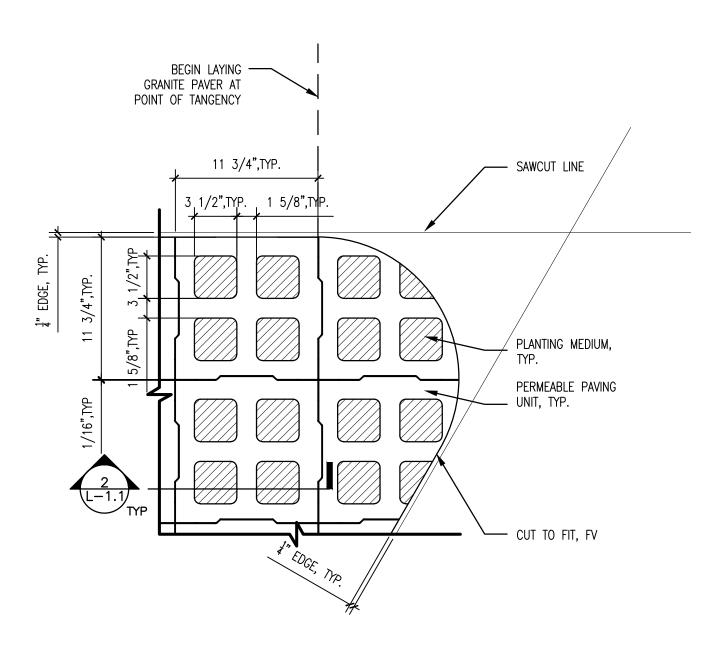

1 P7 - ECO-GRID PAVERS FOR FLEX PARKING AREA scale: 1-1/2" = 1' - 0"

Woodland Park Euclid Improvements



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HOOD DESIGN STUDIO, Inc.
3016 FILBERT street
studio 2
DAKLAND, CA 94608
510 . 595 0688
www.hooddesignstudio.com


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Date 25 September, 2019 Project No. 21620

GENERAL NOTES

- ALL TREE REMOVAL WORK SHALL BE PERFORMED IN CONFORMANCE WITH APPLICABLE LOCAL CODES AND ORDINANCES.
- ALL ADDITIONAL REQUIREMENTS FOR TREE PROTECTION AND MITIGATION AS REQUIRED BY THE CITY ARBORIST AND THE PROJECT ARBORIST SHALL BE FOLLOWED. REFERENCE CITY OF SANTA CLARA ARBORIST NOTES AND PROJECT ARBORIST NOTES.
- 3. CONTRACTOR SHALL VISIT THE SITE WITH OWNER'S REPRESENTATIVES PRIOR TO BEGINNING ANY WORK. VERIFY ALL TREES, SHRUBS & VEGETATION WITHIN THE LIMITS OF WORK TO BE REMOVED AND ALL TREES & PLANTS TO REMAIN AND TO BE PROTECTED.
- 4. ALL TREES AND PLANTS DESIGNATED TO REMAIN SHALL BE PROTECTED FROM PHYSICAL DAMAGE AND MAINTAINED THROUGHOUT THE DURATION OF THE CONTRACT. THOSE TREES AND PLANTS INDICATED TO BE REMOVED SHALL BE COMPLETELY REMOVED, INCLUDING THE ROOTS, AND DISPOSED OF OFF-SITE. BACKFILL EXCAVATED AREAS TO RESTORE TO EXISTING GRADE.
- 5. PROTECTIVE FENCING: TEMPORARY FENCES OR BARRICADES SHALL BE INSTALLED AS SHOWN ON THE DRAWINGS OR AS DIRECTED IN THE FIELD BY THE PROJECT ARBORIST OR THE OWNER'S REPRESENTATIVE. FENCING SHALL BE A MINIMUM OF SIX (6) FOOT HEIGHT, CHAIN LINK. MAINTAIN FENCING IN CONTINUOUS, STABLE AND UPRIGHT CONDITION AT ALL TIMES.
- 6. CONTRACTOR SHALL REMOVE FROM THE SITE ALL DEBRIS AND UNSUITABLE MATERIAL GENERATED FROM CONSTRUCTION AND DISPOSE OF IN A LAWFUL MANNER.

PROJECT ARBORIST NOTES

1. THE TREE PRESERVATION GUIDELINES ARE SUPERSEDED BY THE CITY OF SANTA CLARA ARBORIST NOTES INCLUDED IN THE DOCUMENTS PROVIDED. THIS INCLUDES CITY TREE DAMAGE PENALTIES IN THE CASE THAT TREES DIE OR ARE DAMAGED DUE TO FAILURE TO PROVIDE ADEQUATE PROTECTIONS. CITY REQUIRES THAT ARBORIST SUPERVISION OF PROJECT TREE PROTECTION BE CONDUCTED BY CITY ARBORIST OR ARBORIST EMPLOYED BY CITY.

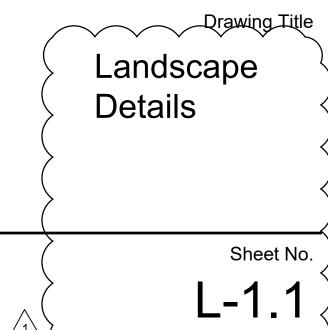2. THESE GUIDELINES PROVIDE FOR THE CARE AND MAINTENANCE OF THE TREE(S) BEFORE, DURING AND AFTER CONSTRUCTION ACTIVITIES. THE GOAL OF TREE PROTECTION AND PRESERVATION IS TO PROVIDE FOR A SUCCESSFUL TRANSITION TO A MODIFIED SITE.

3. TO BE MOST EFFECTIVE, TREE PRESERVATION AND HEALTH MITIGATION MEASURES MUST COMMENCE WELL BEFORE THE TIME OF DISTURBANCE AS HEALTHY TREES ARE MORE LIKELY TO SURVIVE ADVERSE IMPACTS.

4. TO BE EFFECTIVE, PROJECT ARBORIST MUST HAVE THE ABILITY TO ASSURE THE GUIDELINES ARE OBSERVED AND HAVE THE ABILITY TO HALT ALL CONSTRUCTION ACTIVITIES IF TRANSGRESSIONS OCCUR.

5. PROJECT CONSTRUCTION DOCUMENTS MUST ACCURATELY SHOW TREE PROTECTION AREAS AND SPECIFY PROTOCOL AND PROCEDURES TO BE USED FOR ALL ACTIVITIES WITHIN THE DESIGNATED TREE PROTECTION AREA.

SITE ANALYSIS AND EARLY TREE HEALTH MITIGATION

6. THE INFORMATION GAINED FROM SITE ANALYSIS IS UTILIZED FOR ROOT AND SOIL PROTECTION AND TO ASSURE THAT ADEQUATE MITIGATION TREATMENTS ARE

7. SOIL PROFILE EXAMINATION – THE SOIL PROFILE EXAMINATION DETERMINES SOIL TEXTURE AND MOISTURE LEVELS. SOIL COMPACTION IS ALSO ASSESSED. THIS INFORMATION IS VITAL TO THE UNDERSTANDING OF THE LEVEL OF SOIL PROTECTION AND MITIGATION THAT WILL BE NECESSARY.

8. LABORATORY ANALYSIS - ANALYSIS OF SOIL AND PLANT TISSUE SAMPLES CAN HELP GUIDE THE USE OF SOIL AMENDMENTS AND FERTILIZATION.

9. ROOT INVESTIGATION – UNDERSTANDING THE DEPTH, SIZE AND AMOUNT OF ROOTS PRESENT IS REQUIRED TO HELP GUIDE PROJECT DESIGN AND ANTICIPATE WHEN A TREE IS UNLIKELY TO SURVIVE.

10. MITIGATION OF LIMITATIONS IDENTIFIED – LIMITATIONS IDENTIFIED DURING SITE ANALYSIS ACTIVITIES ARE BEST MITIGATED PRIOR TO THE BEGINNING OF CONSTRUCTION ACTIVITIES. POSSIBLE LIMITATIONS TO BE MITIGATED INCLUDE SOIL COMPACTION, NUTRITIONAL DEFICIENCIES AND INSUFFICIENT OR EXCESS SOIL MOISTURE. MOST BASIC MITIGATION ENTAILS: IRRIGATION, MULCHING, WATER JET AND AIR SPADE PROCEDURES. SOIL AMENDMENTS OTHER THAN GOOD QUALITY MULCH MUST BE BASED UPON LABORATORY SOIL AND/OR TISSUE ANALYSIS.

PRE-CONSTRUCTION ACTIVITIES

11. THESE ACTIVITIES SHOULD BE UNDERTAKEN PRIOR TO INITIATION OF CONSTRUCTION ACTIVITY.

12. MULCHING – USE OF GOOD QUALITY ORGANIC MULCH (WOOD CHIPS ARE BEST) ON SOIL SURFACE HELPS TO REDUCE SOIL COMPACTION AND RETAIN SOIL MOISTURE. RECOMMENDED MATERIAL IS WOOD CHIPS GENERATED FROM TREE TRIMMING. FRESH REDWOOD, INCENSE CEDAR AND WALNUT CHIPS ARE NOT ACCEPTABLE, NOR IS PALM GENERATED MULCH.

13. CROWN PRUNING -PRUNING MUST COMPLY WITH ANSI A300 PRUNING STANDARDS. PRUNING PRIOR TO CONSTRUCTION SHOULD INCLUDE: NECESSARY CLEARANCE PRUNING, DEADWOOD REMOVAL AND SAFETY PRUNING.

14. CONSTRUCTION DOCUMENTS TO SHOW PROTECTED TREES AND TREE PROTECTION REQUIREMENTS – PROJECT PLANS TO SHOW ALL TREE PROTECTION FENCING LAYOUT, AREAS OF ENCROACHMENT AND LIST PROCEDURES FOR WORKING AROUND PROTECTED TREES.

15. DESIGNATION OF TREE ROOT PROTECTION ZONE (RPZ) – CITY OF SANTA ROSA ARBORIST NOTES DESIGNATES THE "TREE PROTECTION ZONE AS 1.5 TIMES THE RADIUS OF THE DRIP LINE". THE TREE ROOT PROTECTION ZONE DESIGNATES AN AREA SURROUNDING A TREE OR GROUPING OF TREES THAT IS TO BE FENCED OFF FROM ALL ACCESS. NO MATTER THE RADIUS OF THE DRIP ZONE, THE RPZ IS NOT TO BE LESS THAN ONE (1) FOOT RADIAL DISTANCE FROM THE BASE OF THE TREE FOR EVERY ONE (1) INCH IN TREE DIAMETER. A TREE WITH A 10 INCH DIAMETER WOULD HAVE A MINIMUM RPZ EQUAL TO 10 FEET OUT FROM THE TREE. PROJECT ARBORIST CAN MODIFY THE RPZ DISTANCE BASED UPON PHYSICAL EVIDENCE OF ROOT PRESENCE OR ABSENCE.

16. TREE ROOT PROTECTION ZONE FENCING – FENCING IS TO BE CHAIN-LINK TYPE METAL FENCING WITH METAL POSTS DRIVEN TWO-FEET INTO THE SOIL. SIGNS SHALL BE ATTACHED TO TREE PROTECTION FENCING EVERY 20' WHICH READ "TREE PROTECTION ZONE DO NOT ENTER".

17. PROCEDURES AND TREATMENTS FOR WORK ACTIVITIES THAT MUST OCCUR INSIDE OF THE RPZ – ALL SUCH ACTIVITIES AND RELOCATION OF FENCING MUST BE OVERSEEN BY PROJECT ARBORIST. SPECIAL TRUNK, SCAFFOLD AND SOIL PROTECTION MEASURES ARE REQUIRED. WHEN ENCROACHMENT IS ANTICIPATED PRIOR TO THE BEGINNING OF CONSTRUCTION ACTIVITIES, THE PROTECTIONS MUST BE IN PLACE PRIOR TO BEGINNING WORK ACTIVITIES.

18. ARBORIST REVIEW AND APPROVAL OF TREE PROTECTION MEASURES – PROJECT ARBORIST EMPLOYED BY THE CITY OF SANTA CLARA TO REVIEW TREE PROTECTION GUIDELINES AND MODIFY AS DEEMED NECESSARY.

19. TREE PROTECTIONS INSTALLATION AND INSPECTED – PROJECT ARBORIST MUST CERTIFY THAT ALL TREE PROTECTION MEASURES HAVE BEEN PROPERLY INSTALLED.

20. PRE-CONSTRUCTION MEETING – CITY EMPLOYED PROJECT ARBORIST TO MEET WITH CONSTRUCTION SUPERVISOR AND WORK CREW TO REVIEW REQUIREMENTS OF THE TREE PROTECTION. ALL PERSONNEL WORKING ON SITE MUST BE PROVIDED AN ORIENTATION TO THE TREE PRESERVATION REQUIREMENTS. NO CONSTRUCTION ACTIVITIES MAY BEGIN UNTIL THIS MEETING HAS BEEN CONDUCTED.

21. PROJECT ARBORIST CAN DIRECT THAT ALL WORK ACTIVITIES STOP IF TREE PROTECTION GUIDELINES ARE NOT BEING FOLLOWED. ALL WORK ACTIVITIES CEASE UNTIL SUCH TIME AS THE PROBLEM HAS BEEN CORRECTED.

22. WORK ACTIVITIES THAT ENCROACH INTO THE DESIGNATED RPZ

TRENCHING PLATES OR 1 1/8 INCH PLYWOOD PLACED ON TOP.

ARBORIST SUPERVISION – ALL ACTIVITIES OCCURRING WITHIN THE DESIGNATED RPZ MUST BE UNDER DIRECT SUPERVISION OF PROJECT ARBORIST. ENCROACHMENT IS NOT PERMITTED UNTIL ALL ADDITIONAL PROTECTIONS ARE IN PLACE AND HAVE BEEN APPROVED.

SPADE OR DITCH WITCH IS REQUIRED. PROJECT ARBORIST MUST APPROVE AND SUPERVISE ALL SUCH ACTIVITY.

23. SOIL AND ROOT PROTECTION –THE EFFECTS OF FOOT TRAFFIC CAN BE MITIGATED THROUGH THE USE OF SIX (6) INCHES OF WOOD CHIP MULCH AND ¾ INCH PLYWOOD PLACED ON TOP. PROTECTIONS FOR EQUIPMENT OPERATING WITHIN THE DESIGNATED RPZ REQUIRES 12 INCHES OF MULCH WITH EITHER METAL

24. TRUNK AND SCAFFOLD PROTECTION – WHENEVER CONSTRUCTION ACTIVITY MUST OCCUR INSIDE THE TREE PROTECTION ZONE, THE BASE OF THE TREE AND THE FIRST EIGHT-FEET AND EXPOSED SCAFFOLD LIMBS MUST BE ARMORED. PROTECTION IS GENERALLY PROVIDED BY WRAPPING THE TRUNK WITH STRAW WADDLES COVERED WITH ORANGE PLASTIC CONSTRUCTION FENCING. EXPOSED SCAFFOLD LIMBS ARE BEST PROTECTED BY STRAPPING 2X4 BOARDS TO THE PART

EXPOSED TO POTENTIAL INJURY AND WRAPPING WITH ORANGE PLASTIC FENCING MATERIAL.

25. REQUIRED METHOD OF EXCAVATION WITHIN CRITICAL ROOT ZONE – WHEREVER POSSIBLE, ROUTE UTILITIES OUTSIDE OF THE DESIGNATED RPZ. TUNNELING IS THE PREFERRED METHOD FOR UTILITIES PASSING THROUGH THE RPZ. WHEN TRENCHING IS REQUIRED, CAREFULLY HAND EXCAVATION OR THE USE OF THE AIR

26. NECESSARY ROOT PRUNING – LATE FALL SEASON IS THE BEST TIME FOR ROOT PRUNING. SPRING CAN BE THE MOST HARMFUL AT THIS IS THE TIME OF GREATEST MOISTURE NEEDS. ALL NECESSARY ROOT PRUNING IS CONDUCTED BY PROJECT ARBORIST AFTER THE ROOTS HAVE BEEN EXPOSED WITHOUT DAMAGE.

27. POST CONSTRUCTION MITIGATION ARBORIST DESIGNATION OF HEALTH MITIGATION ACTIVITIES – PROJECT ARBORIST WILL DESIGNATE TREE HEALTH MITIGATION ACTIVITIES BASED UPON THE LEVEL OF ROOT LOSS AND ADVERSE IMPACTS THAT HAVE OCCURRED.

28. MONITORING TREE HEALTH – TREES THAT HAVE BEEN ADVERSELY IMPACTED BY CONSTRUCTION ACTIVITIES ARE NOTED FOR REGULAR VISUAL INSPECTION. PROJECT ARBORIST WILL DIRECT FURTHER MITIGATION. INSECTS AND FUNGAL PATHOGENS ARE A SIGN OF POOR TREE HEALTH (LOW ENERGY RESERVES) AND INDICATE THE NEED FOR HEALTH MITIGATION.

29. MONITORING OF SOIL MOISTURE – MOISTURE SHOULD BE MONITORED BY VISUAL INSPECTION USING A SOIL PROBE OR THROUGH THE USE OF TENSIOMETERS PLACED AT KEY LOCATIONS AND DEPTHS. SUPPLEMENTAL IRRIGATION IS MOST NEEDED DURING SPRING. IN CASES WHERE TREES HAVE SUFFERED ROOT LOSS, SUPPLEMENTAL IRRIGATION MAY BE REQUIRED FOR A NUMBER OF YEARS.

30. MITIGATION OF SOIL COMPACTION – THE LEVEL AND DEPTH OF SOIL COMPACTION MUST BE ASSESSED AND MITIGATED AS NECESSARY. TOOLS THAT ARE MOST SUITABLE FOR MITIGATION OF COMPACTED SOIL ARE THE WATER JET OR AIR SPADE.

31. LANDSCAPING – ALL LANDSCAPING PLANNING MUST TAKE PRECAUTIONS WHEN PLANTING WITHIN THE DESIGNATED RPZ. ALL PLANT MATERIALS SHOULD BE SELECTED FOR COMPATIBILITY WITH THE FAVORED MOISTURE REGIME (HYDROZONE) OF THE TREE SPECIES AND SOIL TEXTURE.

32. CONTINUED MULCHING – MULCH IS EXTREMELY BENEFICIAL IN CREATING A HEALTHY ROOT ENVIRONMENT. A REGULAR PROGRAM OF MULCH APPLICATION IS RECOMMENDED TO HELP RETAIN SOIL MOISTURE, PROVIDE A SOURCE OF NUTRIENTS, AND HELP CONTROL WEEDS.

33. FERTILIZATION –TREES SHOULD BE FERTILIZED ONLY WHEN THE NUTRITIONAL LIMITATIONS HAVE BEEN IDENTIFIED THROUGH LABORATORY ANALYSIS OF SOIL OR PLANT TISSUE. EXCESSIVE NITROGEN FERTILIZATION IS KNOWN TO DRAW SUCKING INSECTS (APHID, SCALE, ETC.) TO THE PLANTS AND PROVIDE NUTRITION TO FUNGAL PATHOGENS IN THE SOIL. PEST MANAGEMENT PROGRAM – HEALTHY TREES DO NOT GENERALLY HAVE SERIOUS PEST PROBLEMS. STRESSED TREES BECOME ATTRACTIVE HOSTS TO PATHOGENS WHICH CAN CONTRIBUTE TO FURTHER DECLINE. PEST MANAGEMENT IS PRESCRIBED WHEN MONITORING INDICATES A

34. ENFORCEMENT OF TREE PROTECTION – CITY OF SANTA CLARA ARBORIST NOTES LIST PENALTIES FOR FAILURE TO COMPLY WITH PROTECTION AND MAINTENANCE OF TREES DESIGNATED TO BE RETAINED.


1. ALL PLANTS DESIGNATED TO BE SAVED SHALL BE PROTECTED BY FENCING, AS 2. INSTALL TREE PROTECTION FENCE AT TREE DRIP LINE OR AT EDGE OF DISTURBED AREA, AS SHOWN ON PLANS, PRIOR TO COMMENCEMENT OF CONSTRUCTION. 3. SPACE TREE PROTECTION ZONE SIGNS A MINIMUM OF ONE EVERY 300 FEET. THE SIZE OF EACH SIGN MUST BE A MINIMUM OF 2' x 2' AND BE VISIBLE FROM BOTH SIDES OF THE SIGN MUST CONTAIN THE FOLLOWING LANGUAGE IN BOTH ENGLISH & SPANISH: "TREE PROTECTION ZONE, KEEP OUT". 3. THERE SHALL BE NO STORAGE OF MATERIAL WITHIN THE BOUNDARIES OF THE TREE PROTECTION FENCING. 4. TREE PROTECTION FENCING SHALL BE MAINTAINED THROUGHOUT THE DURATION OF THE - ATTACH SIGN TO POST — FENCE MATERIAL: ORANGE, UV RESISTANT HIGH TENSILE STRENGTH POLYETHYLENE LAMINAR BARRICADE FABRIC 4'-0" 1.33 LBS/LF STEEL POST MINIMUM: PLACE FENCE AT DRIP LINE; WHERE POSSIBLE, EXTEND TO LIMIT OF AREA OF DISTURBANCE OR FUTURE BUILDING EDGE

TREE PROTECTION FENC

		PROTECTE	D TREES				REPLACEMENT TR	EES	
	NAME		TRUNK	PRESERVED		PROTECTED TREE		SIZE	QTY
	NAME	SPECIES	DIAMETER (IN)	(Y/N)		TO BE REMOVED	NEW SPECIES	SIZE	ŲIT
_	860	OLEANDER	9	Y					
	861 863	OLEANDER OLEANDER	7	N	V V V	863	BLUE OAK	24" BOX	2
\		CALIFORNIA BLACK	/ /		^ ^ ^		RINDRED SPIRIT OAK		2
	870) WALNUT				870	KINDRED SKIRIT DAK	24" BOX	
	871	DEODAR CEDAR	36	Y					
	872 873	ENGLISH WALNUT BOXELDER	8	Y					
	874	DEODAR CEDAR	40	Y					
	875	AVOCADO	14	Y					
	876	JAPANESE MAPLE	9, 6, 5	Υ					
	877	JAPANESE MAPLE	7, 4, 4, 4, 4,	Υ					
			4, 4						
	878 879	COAST REDWOOD SAUCER MAGNOLIA	35 15, 10	Y					
	880	ORANGE	14	N		880	KINDRED SPIRIT OAK	24" BOX	2
	881	AVOCADO	26	N		881	BLUE OAK	24" BOX	2
	882	BLACKWOOD ACACIA	21	N		882	BLUE OAK	24" BOX	2
	883	BLACKWOOD ACACIA	16	N	· · · · · · · · · · · · · · · · · · ·	883	BLUE OAK	24" BOX	2
	885	GLOSSY PRIVET	15	N	, ,	885	BLUE OAK	24" BOX	2
	886	AUSTRALIAN BUSH	7, 6, 5, 5	Ν	<u> </u>	886	BLUE OAK	24" BOX	2
		CHERRY AUSTRALIAN BUSH							
	887	CHERRY	14	N	\rightarrow	887	BLUE OAK	24" BOX	2
	888	AUSTRALIAN BUSH CHERRY	14	N		888	BLUE OAK	24" BOX	2
	900	AUSTRALIAN BUSH	7	K1	<i>'</i>	900	DILIE OAK		2
	890	CHERRY	/	N		890	BLUE OAK	24" BOX	2
	891	WEEPING BOTTLE BRUSH	14, 6	N	\rightarrow	891	BLUE OAK	24" BOX	2
	896	ENGLISH WALNUT	17	N	·	896	BLUE OAK	24" BOX	2
	897	ORANGE	7	Υ	,				
	899	CHERRY	13	Υ					
	900	ENGLISH WALNUT	17	Υ					
	901	ORANGE	7	Υ					
	902	CHINESE ELM	24	Y					
	903	CHINESE ELM MONTERREY PINE	26 34	Y N	\	904	BLUE OAK	24" BOX	2
	904	RAYWOOD ASH	7	N		905	BLUE OAK	24 BOX 24" BOX	2
	907	RAYWOOD ASH	10, 12	Y	,		. =		
ב	908	RAYWOOD ASH	11	Υ					
<	910	RAYWOOD ASH	9	Υ					
-)	911	RAYWOOD ASH	10	Y					
)	912 913	PLUM BOXELDER	30 20	Y					
_	914	BOXELDER	20	Y					
_ ב	915	BOXELDER	31	Y					
_	916	TULIP TREE	24	Υ					
	917	COAST LIVE OAK	17	N	<u> </u>	917	BLUE OAK	24" BOX	2
	920	ITALIAN CYPRESS	14	Y					
ζ	921	ITALIAN CYPRESS	11	Y					
~	922	ITALIAN CYPRESS	12	Y					
<	923 924	PLUM APPLE	12, 8 15	Y					
ر	926	PLUM	13	Y					
>	928	CABBAGE PALM	11, 9	N	<i></i>	928	BLUE OAK	24" BOX	2
_	929	RIVER RED GUM	32	N	<i></i>	929	BLUE OAK	24" BOX	2
_	931	SILVER DOLLAR GUM	21	N	<u> </u>	931	BLUE OAK	24" BOX	2
	932	RIVER RED GUM	36	N	, -	932	BLUE OAK	24" BOX	2
	937	RIVER RED GUM	24	N		937	BLUE OAK	24" BOX	2
7	938	CABBAGE PALM	50	Y		070	DILIE OAK	04" 500	0
	939 940	SOUTHERN MAGNOLIA COAST LIVE OAK	30 27	N Y		939	BLUE OAK	24" BOX	2
	940	COAST LIVE OAK COAST LIVE OAK	26	Y					
	941	SOUTHERN MAGNOLIA	26	Y					
		SOUTHERN MAGNOLIA	23	Y					
	944	COAST REDWOOD	30	Y					
	947	VICTORIAN BOX	17, 15	Y					
_	948	PLOM	15						
1						EXTRA TREES	BLUE OAK	24" BOX	9
l			ES REMOVED	21		I TOTAL TREES	REQUIRED REPLACED	(DATIO 1:2)	42

PROTECTED TREE AND REPLACEMENT TREE LISTS

Woodland Park Euclid Improvements

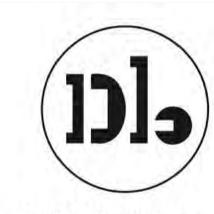

David Baker Architects

dbarchitect.com 461 Second St, Loft c127 San Francisco, CA 94107 415.896.6700



HOOD DESIGN STUDIO, II 3616 FILBERT street studio 2 OAKLAND, CA 94608 510 . 595 0688 www.hooddesignstudio.com

Description Date

Entitlements Submission 09/25/2019

Revisions

Rev. Description Date

1 Response to Comments 10/05/2020

Set Title

Application - September 2019

Drawing Title

Tree
Protection and
Removals List
and Notes

Sneet IV

Date 25 September, 2019 Project No. 21620





David Baker Architects

dbarchitect.com 461 Second St, Loft c127 San Francisco, CA 94107 415.896.6700



HOOD DESIGN STUDIO, 3016 FILBERT street studio 2 OAKLAND, CA 94608 510 . 595 9688 www.hooddesignstudio.com

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1 Response to Comments 10/05/2020

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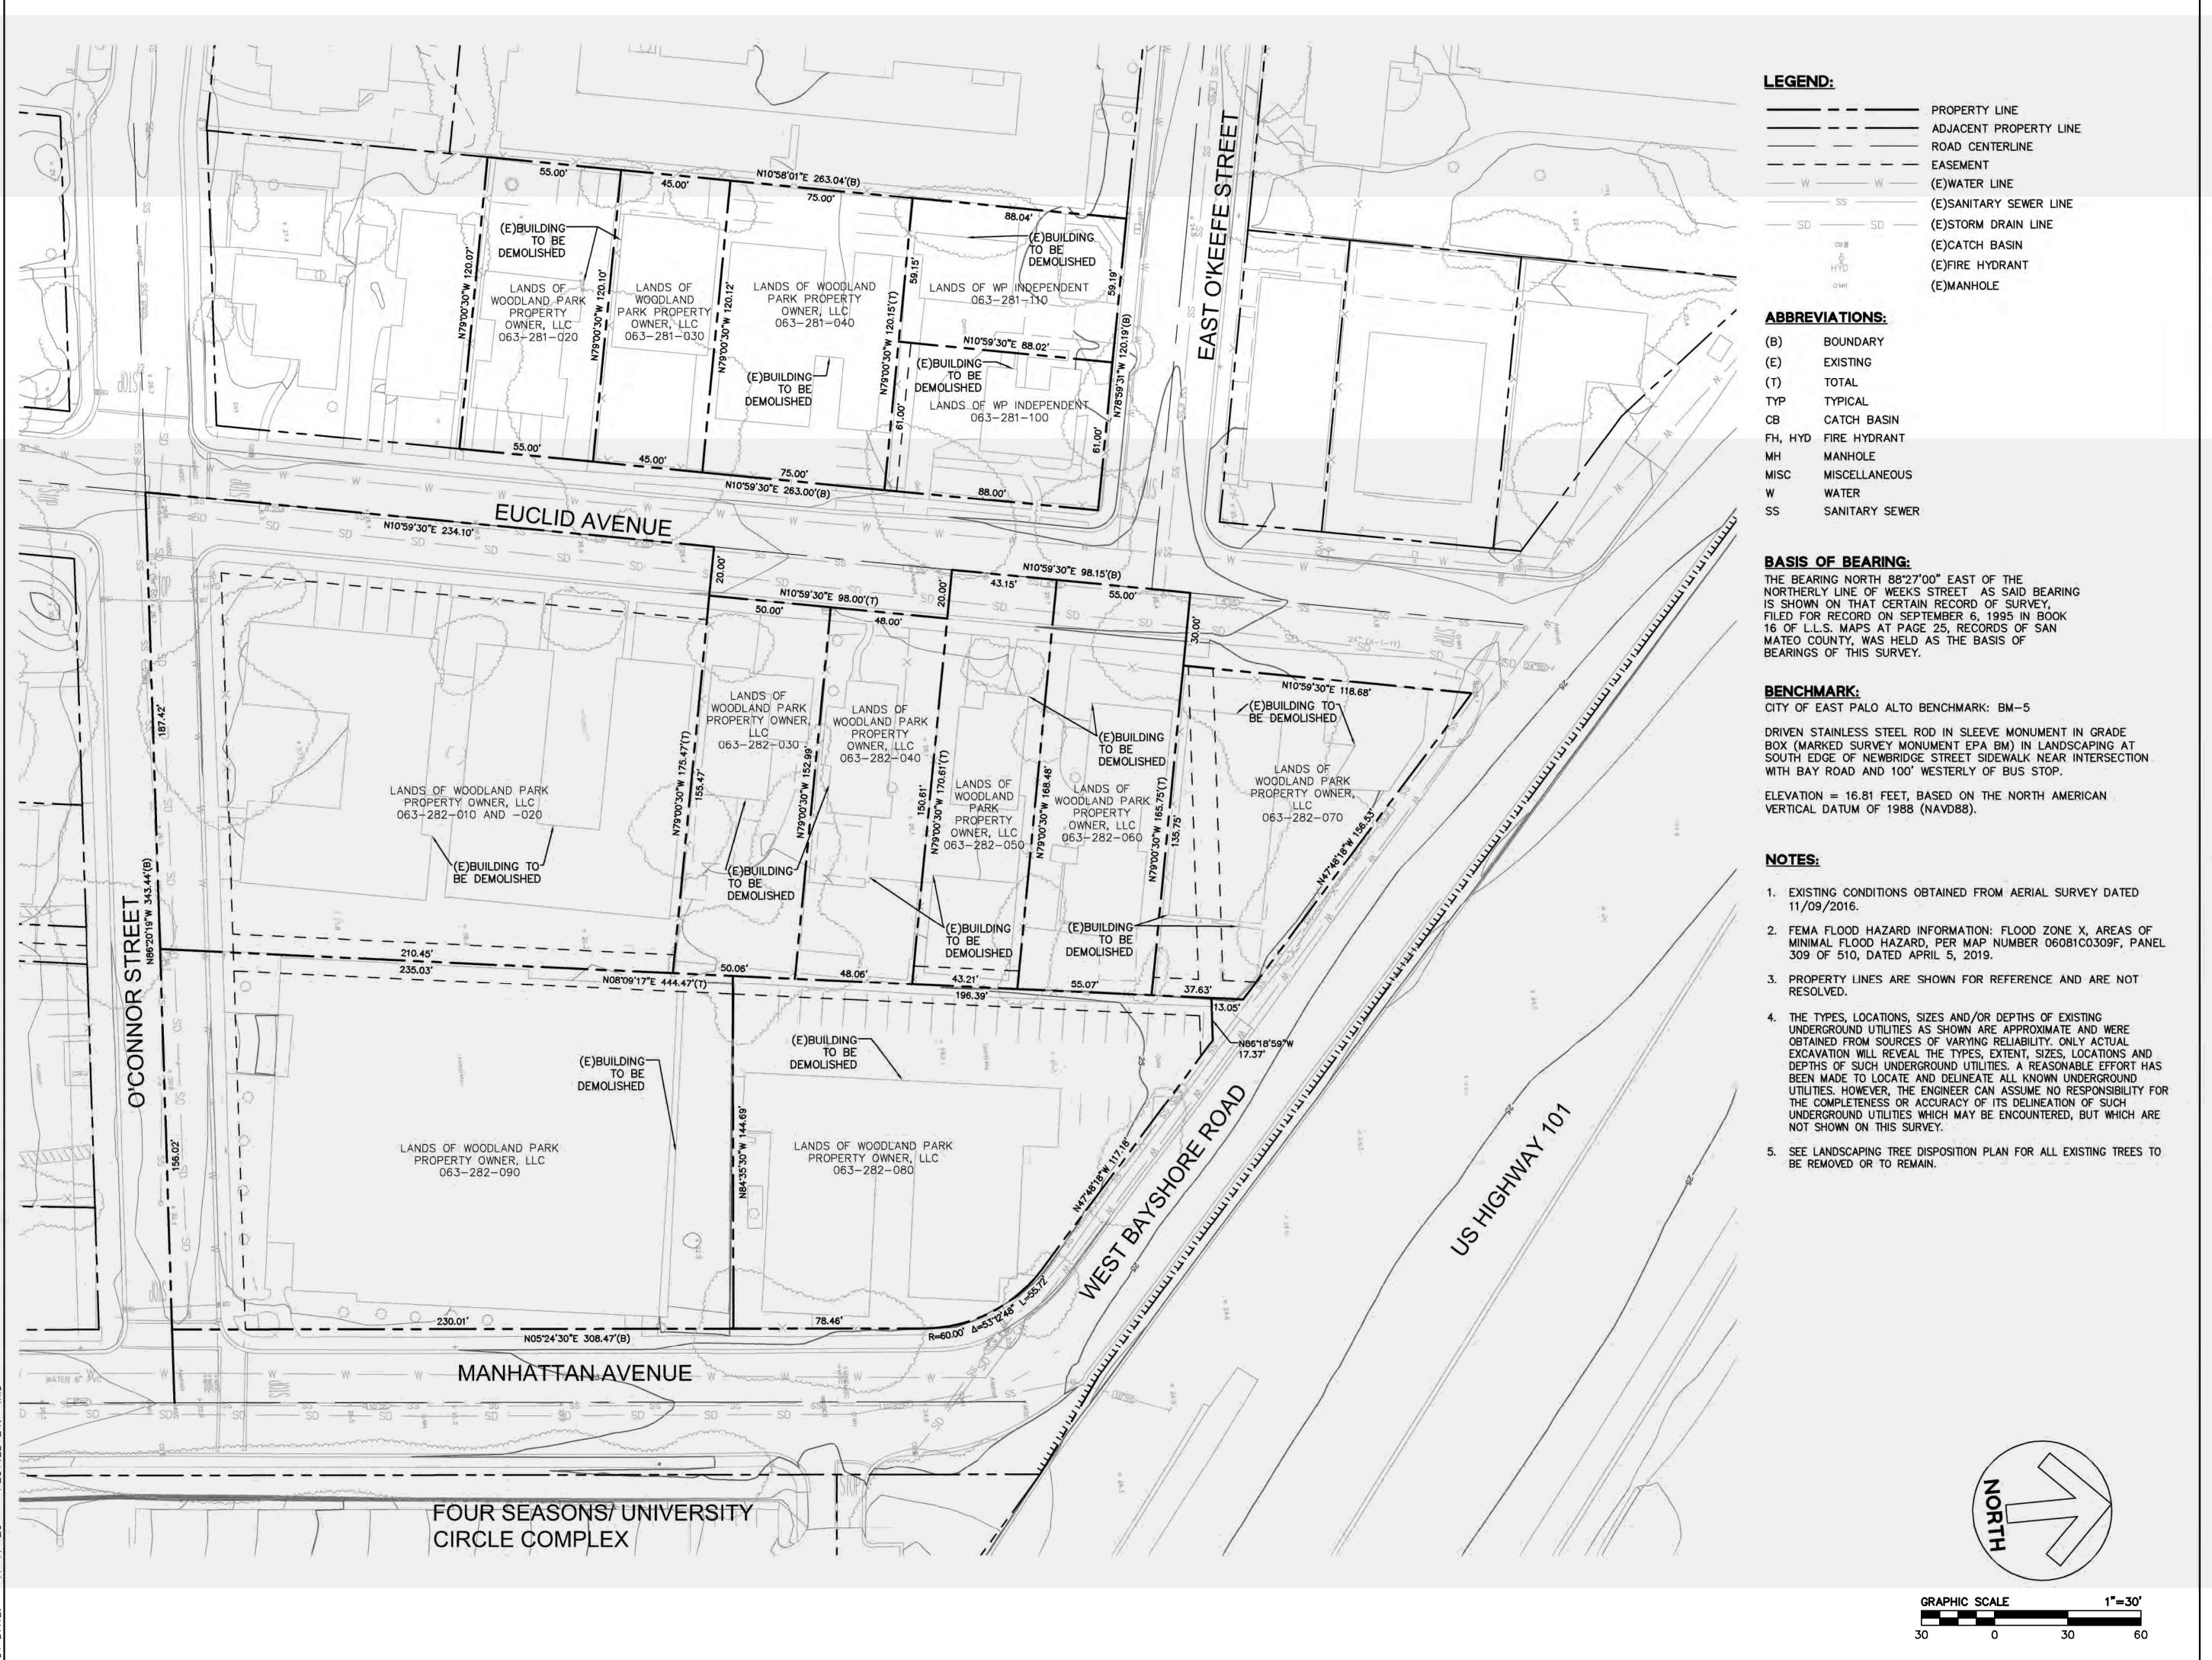
Application - September 2019

Drawing Title

Tree Protection & Removal Plan

T-1.1

Date 25 September, 2019 Project No. 21620



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Revisions

Rev. Description Date

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Drawing Title


EXISTING CONDITIONS AND DEMOLITION PLAN

Sheet No.

C1.0

 Date
 2020-11-17

 Project No.
 20166089-20

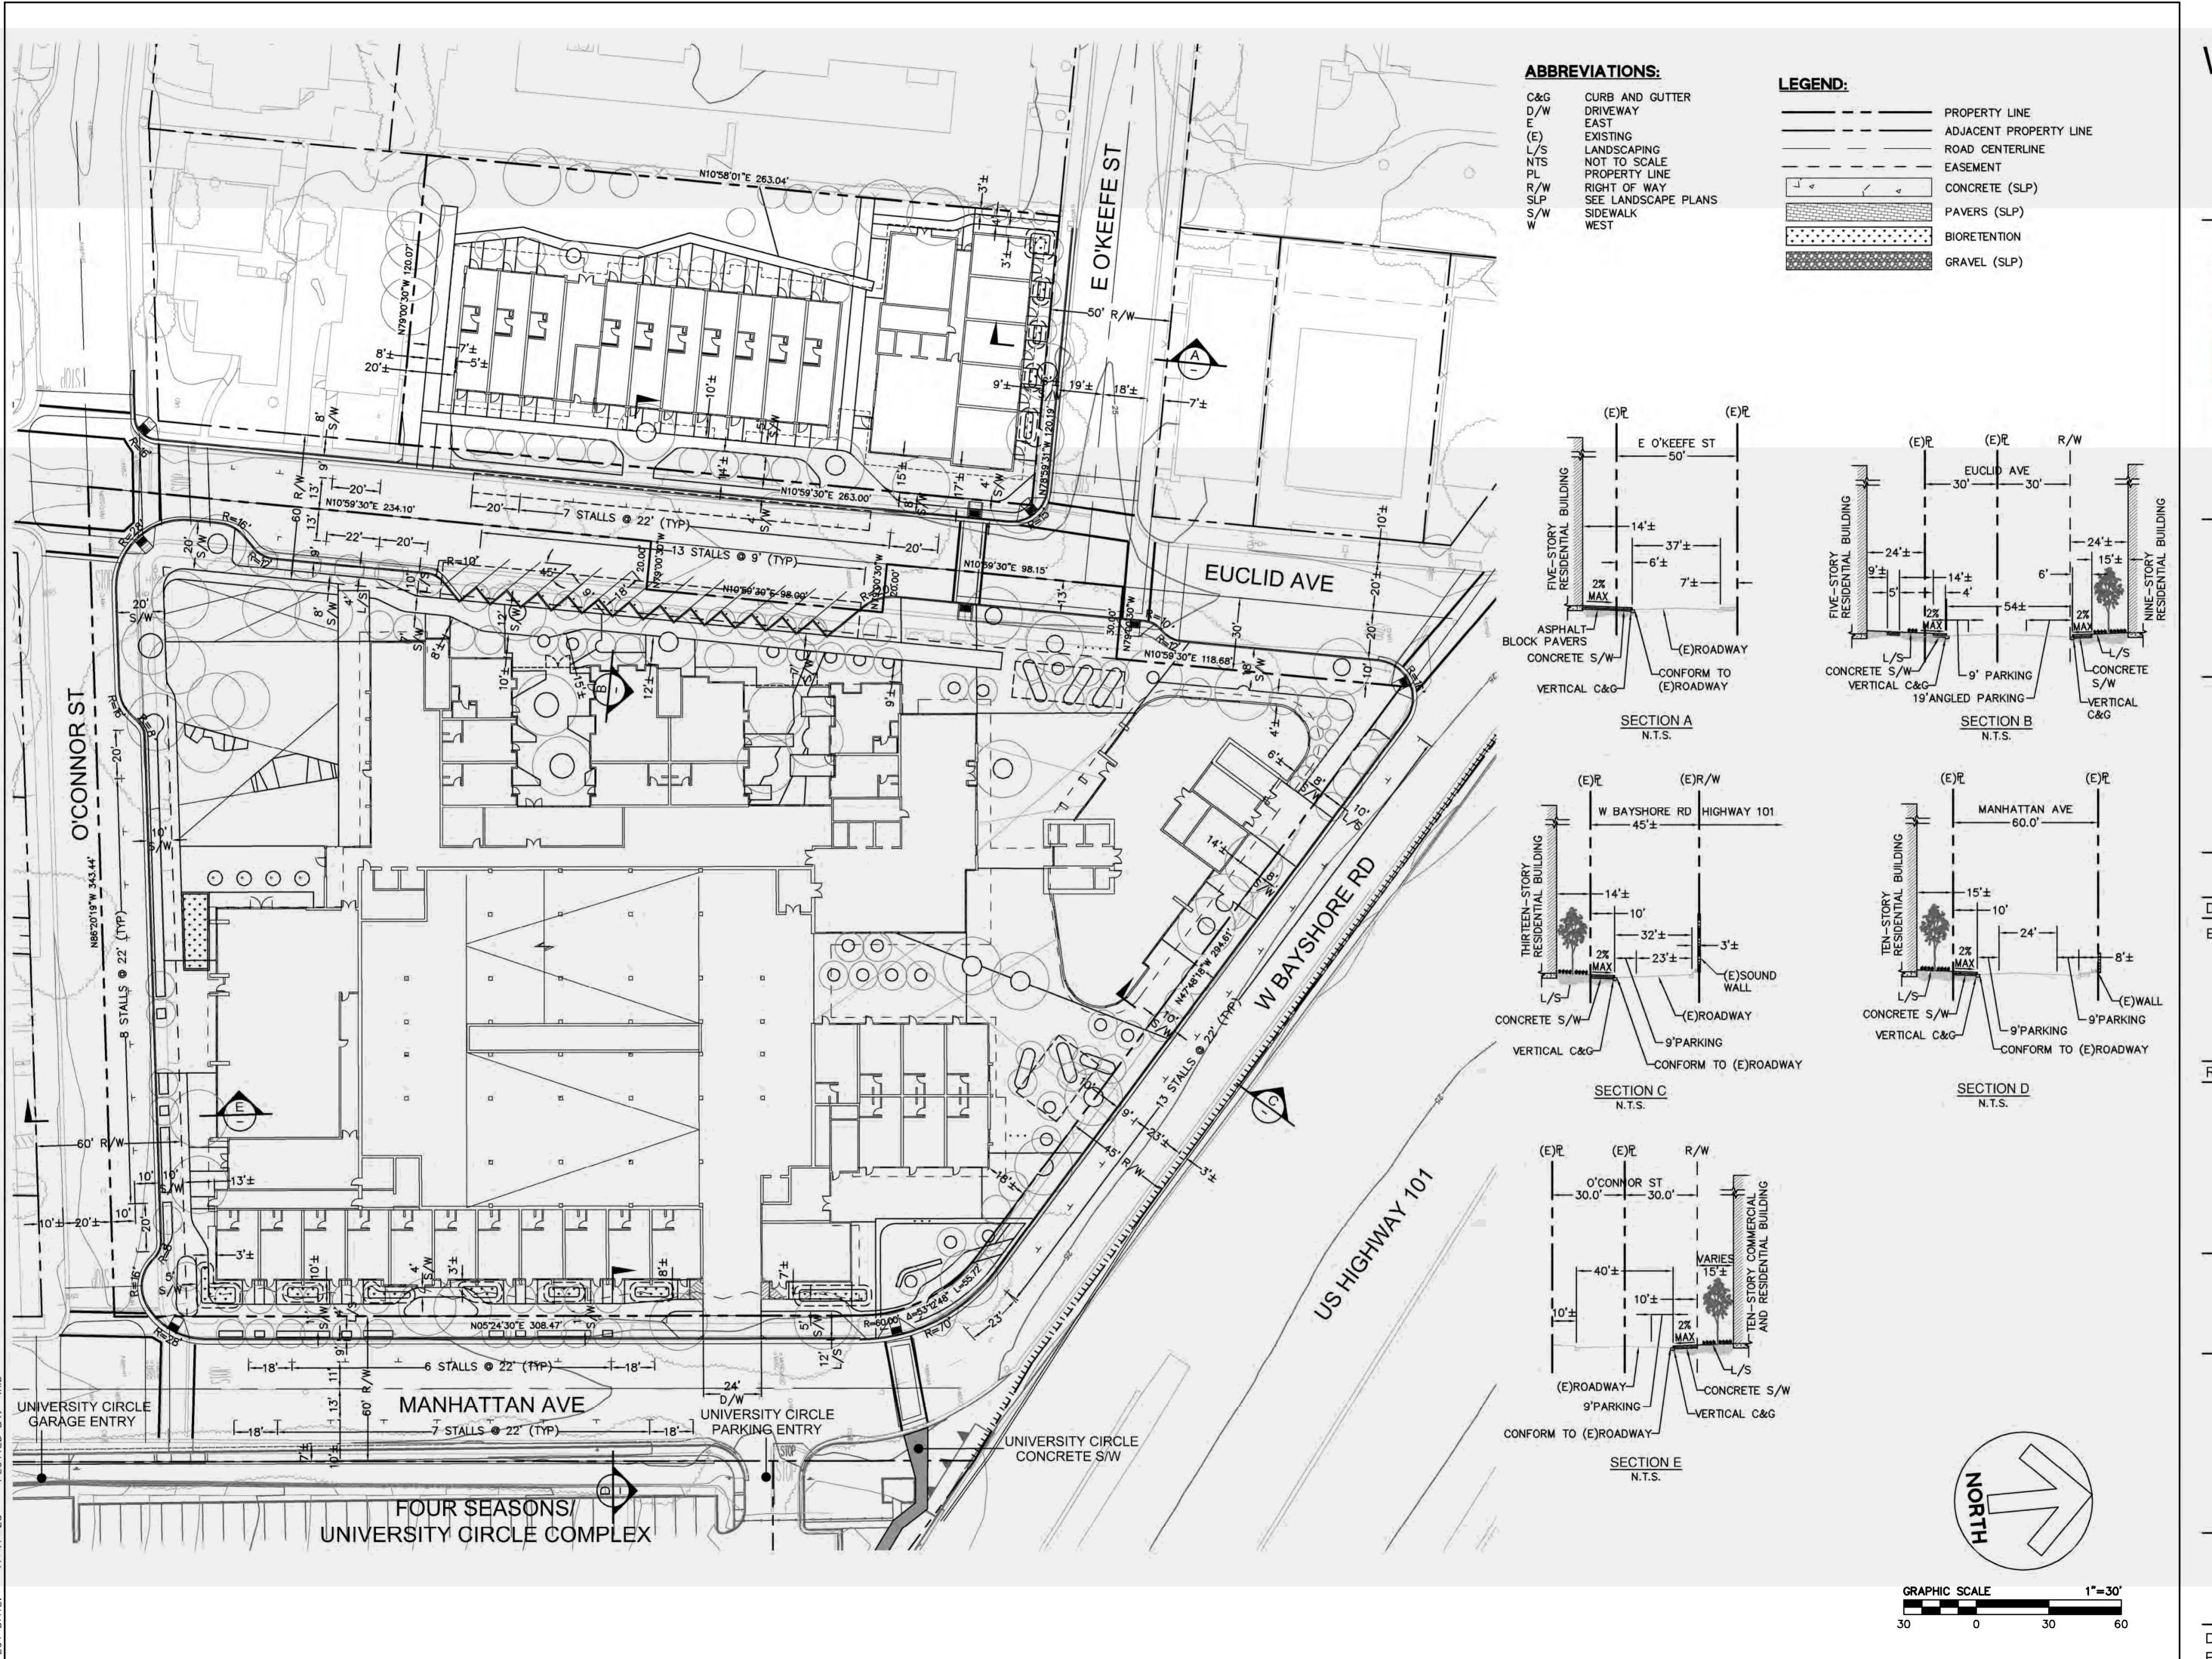

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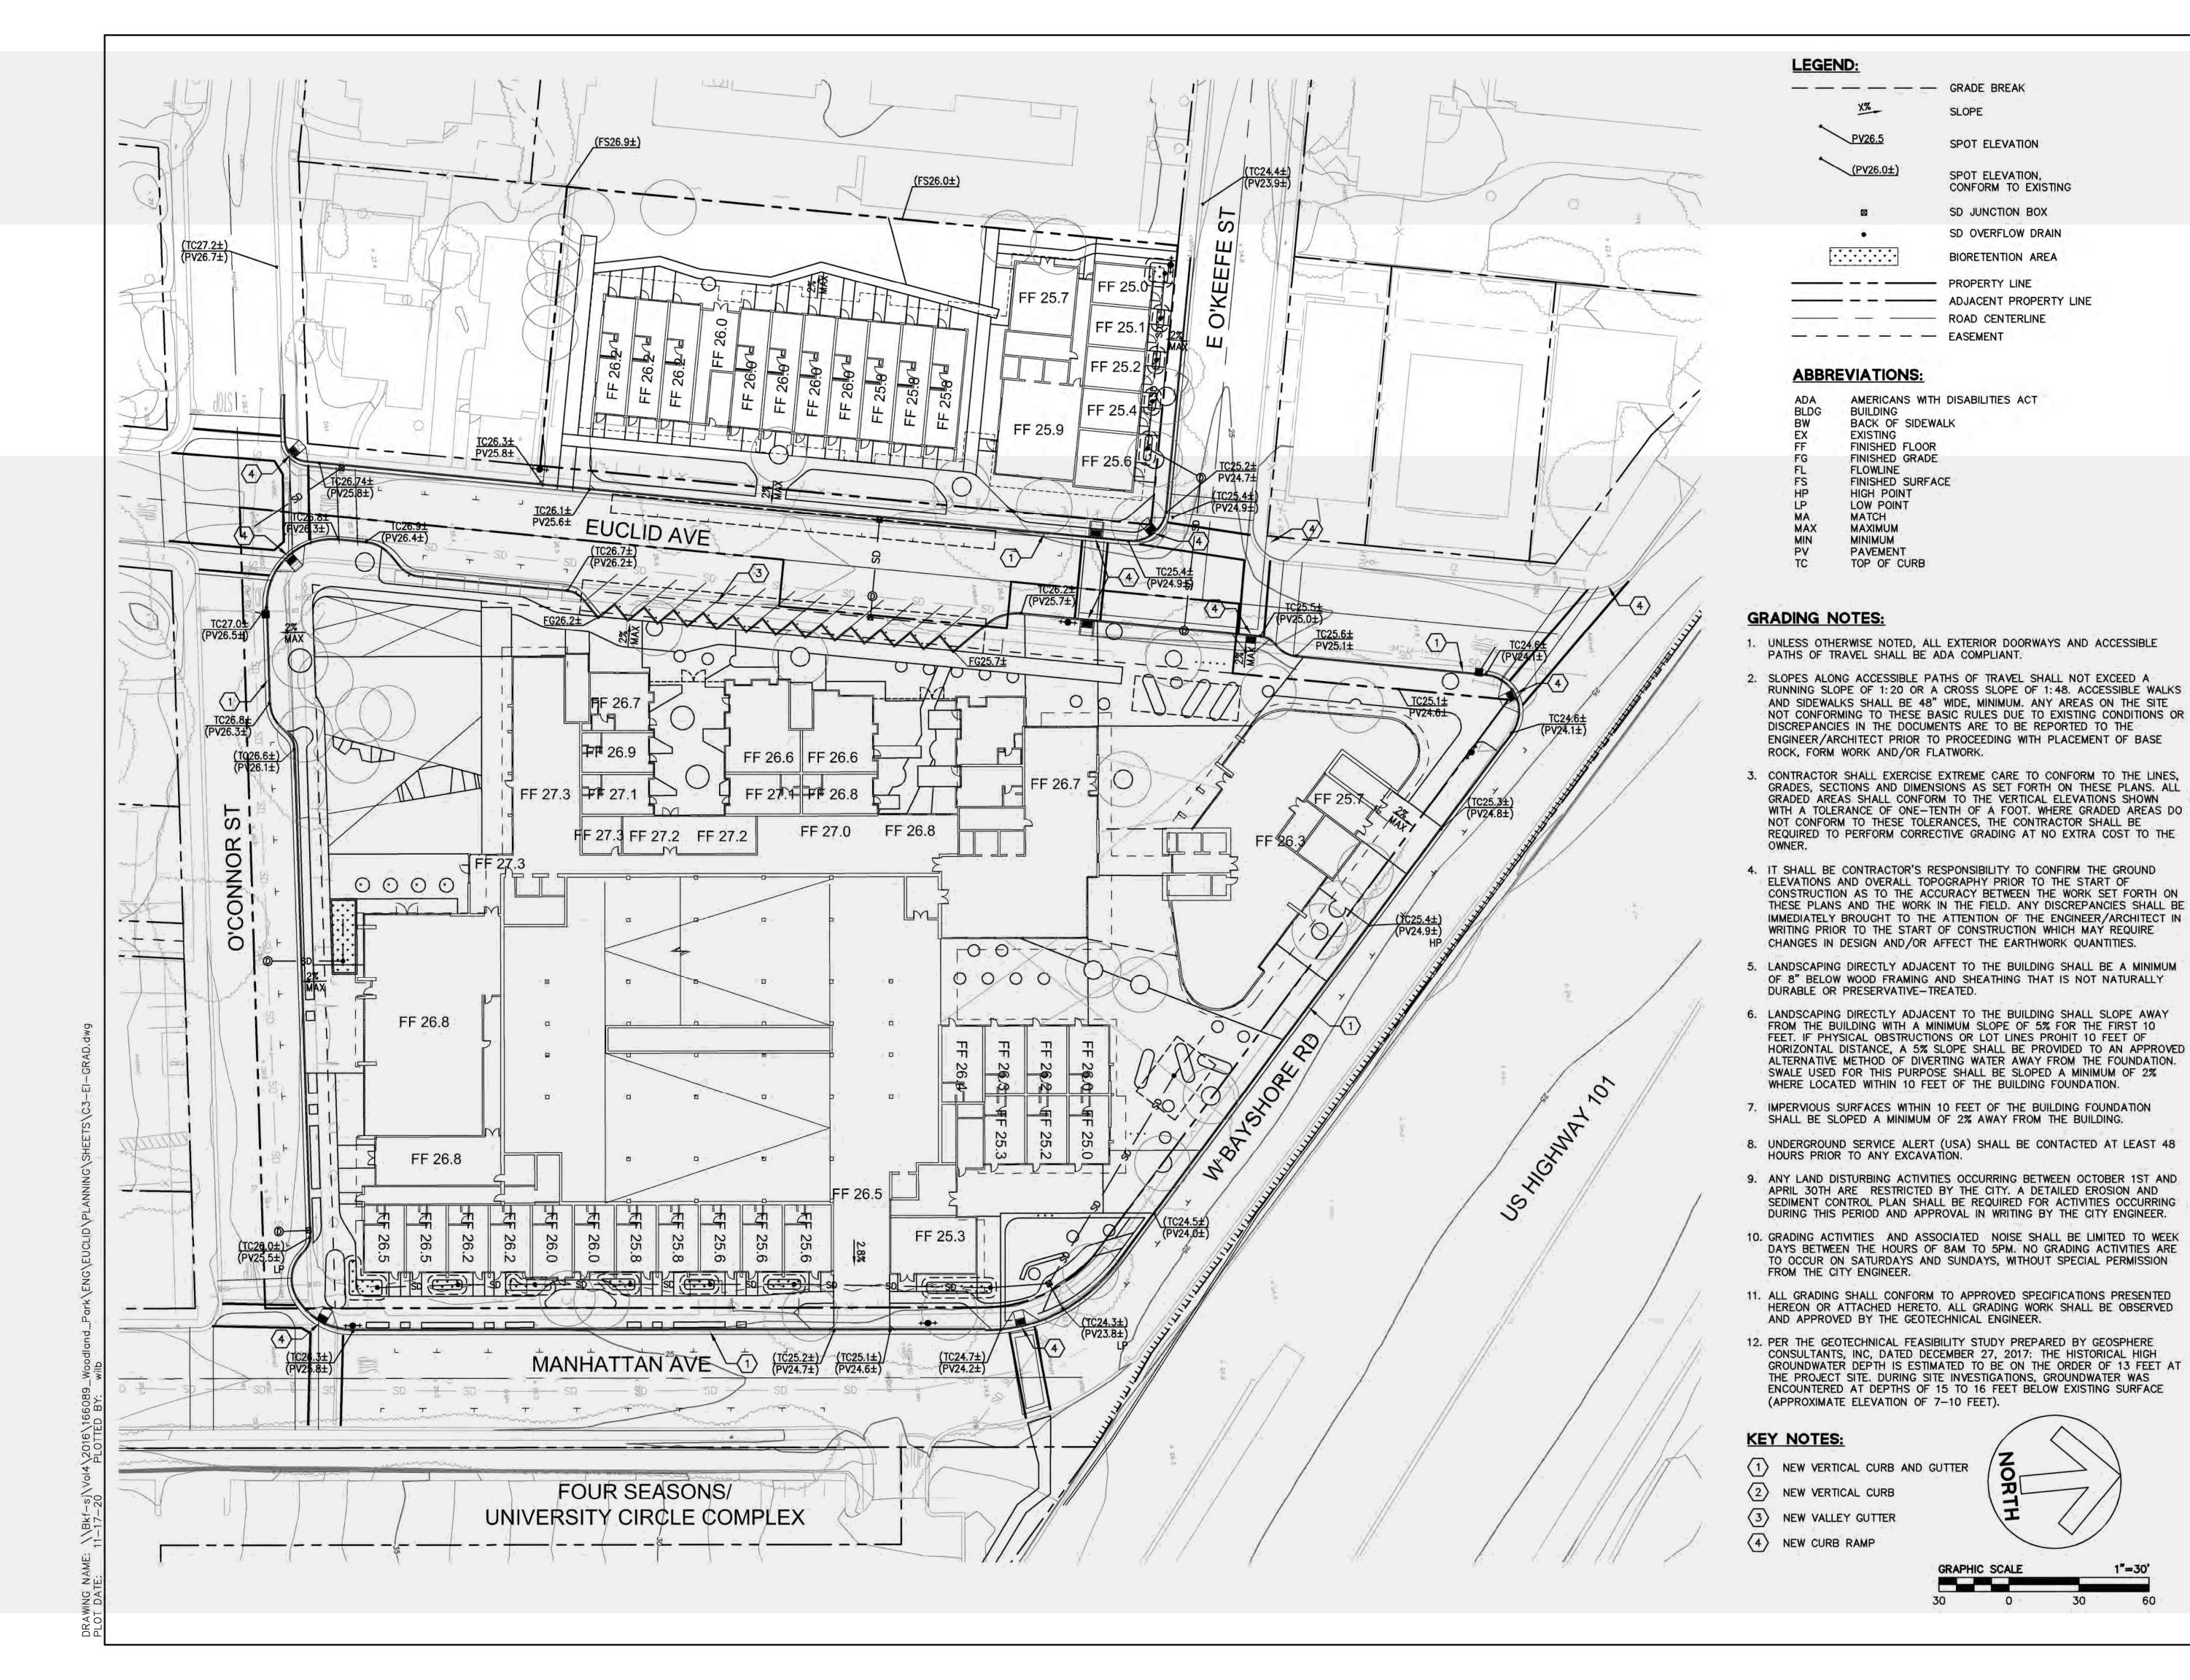
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Drawing Title

PRELIMINARY SITE PLAN

Sheet No.

Date 2020-11-17 Project No. 20166089-20



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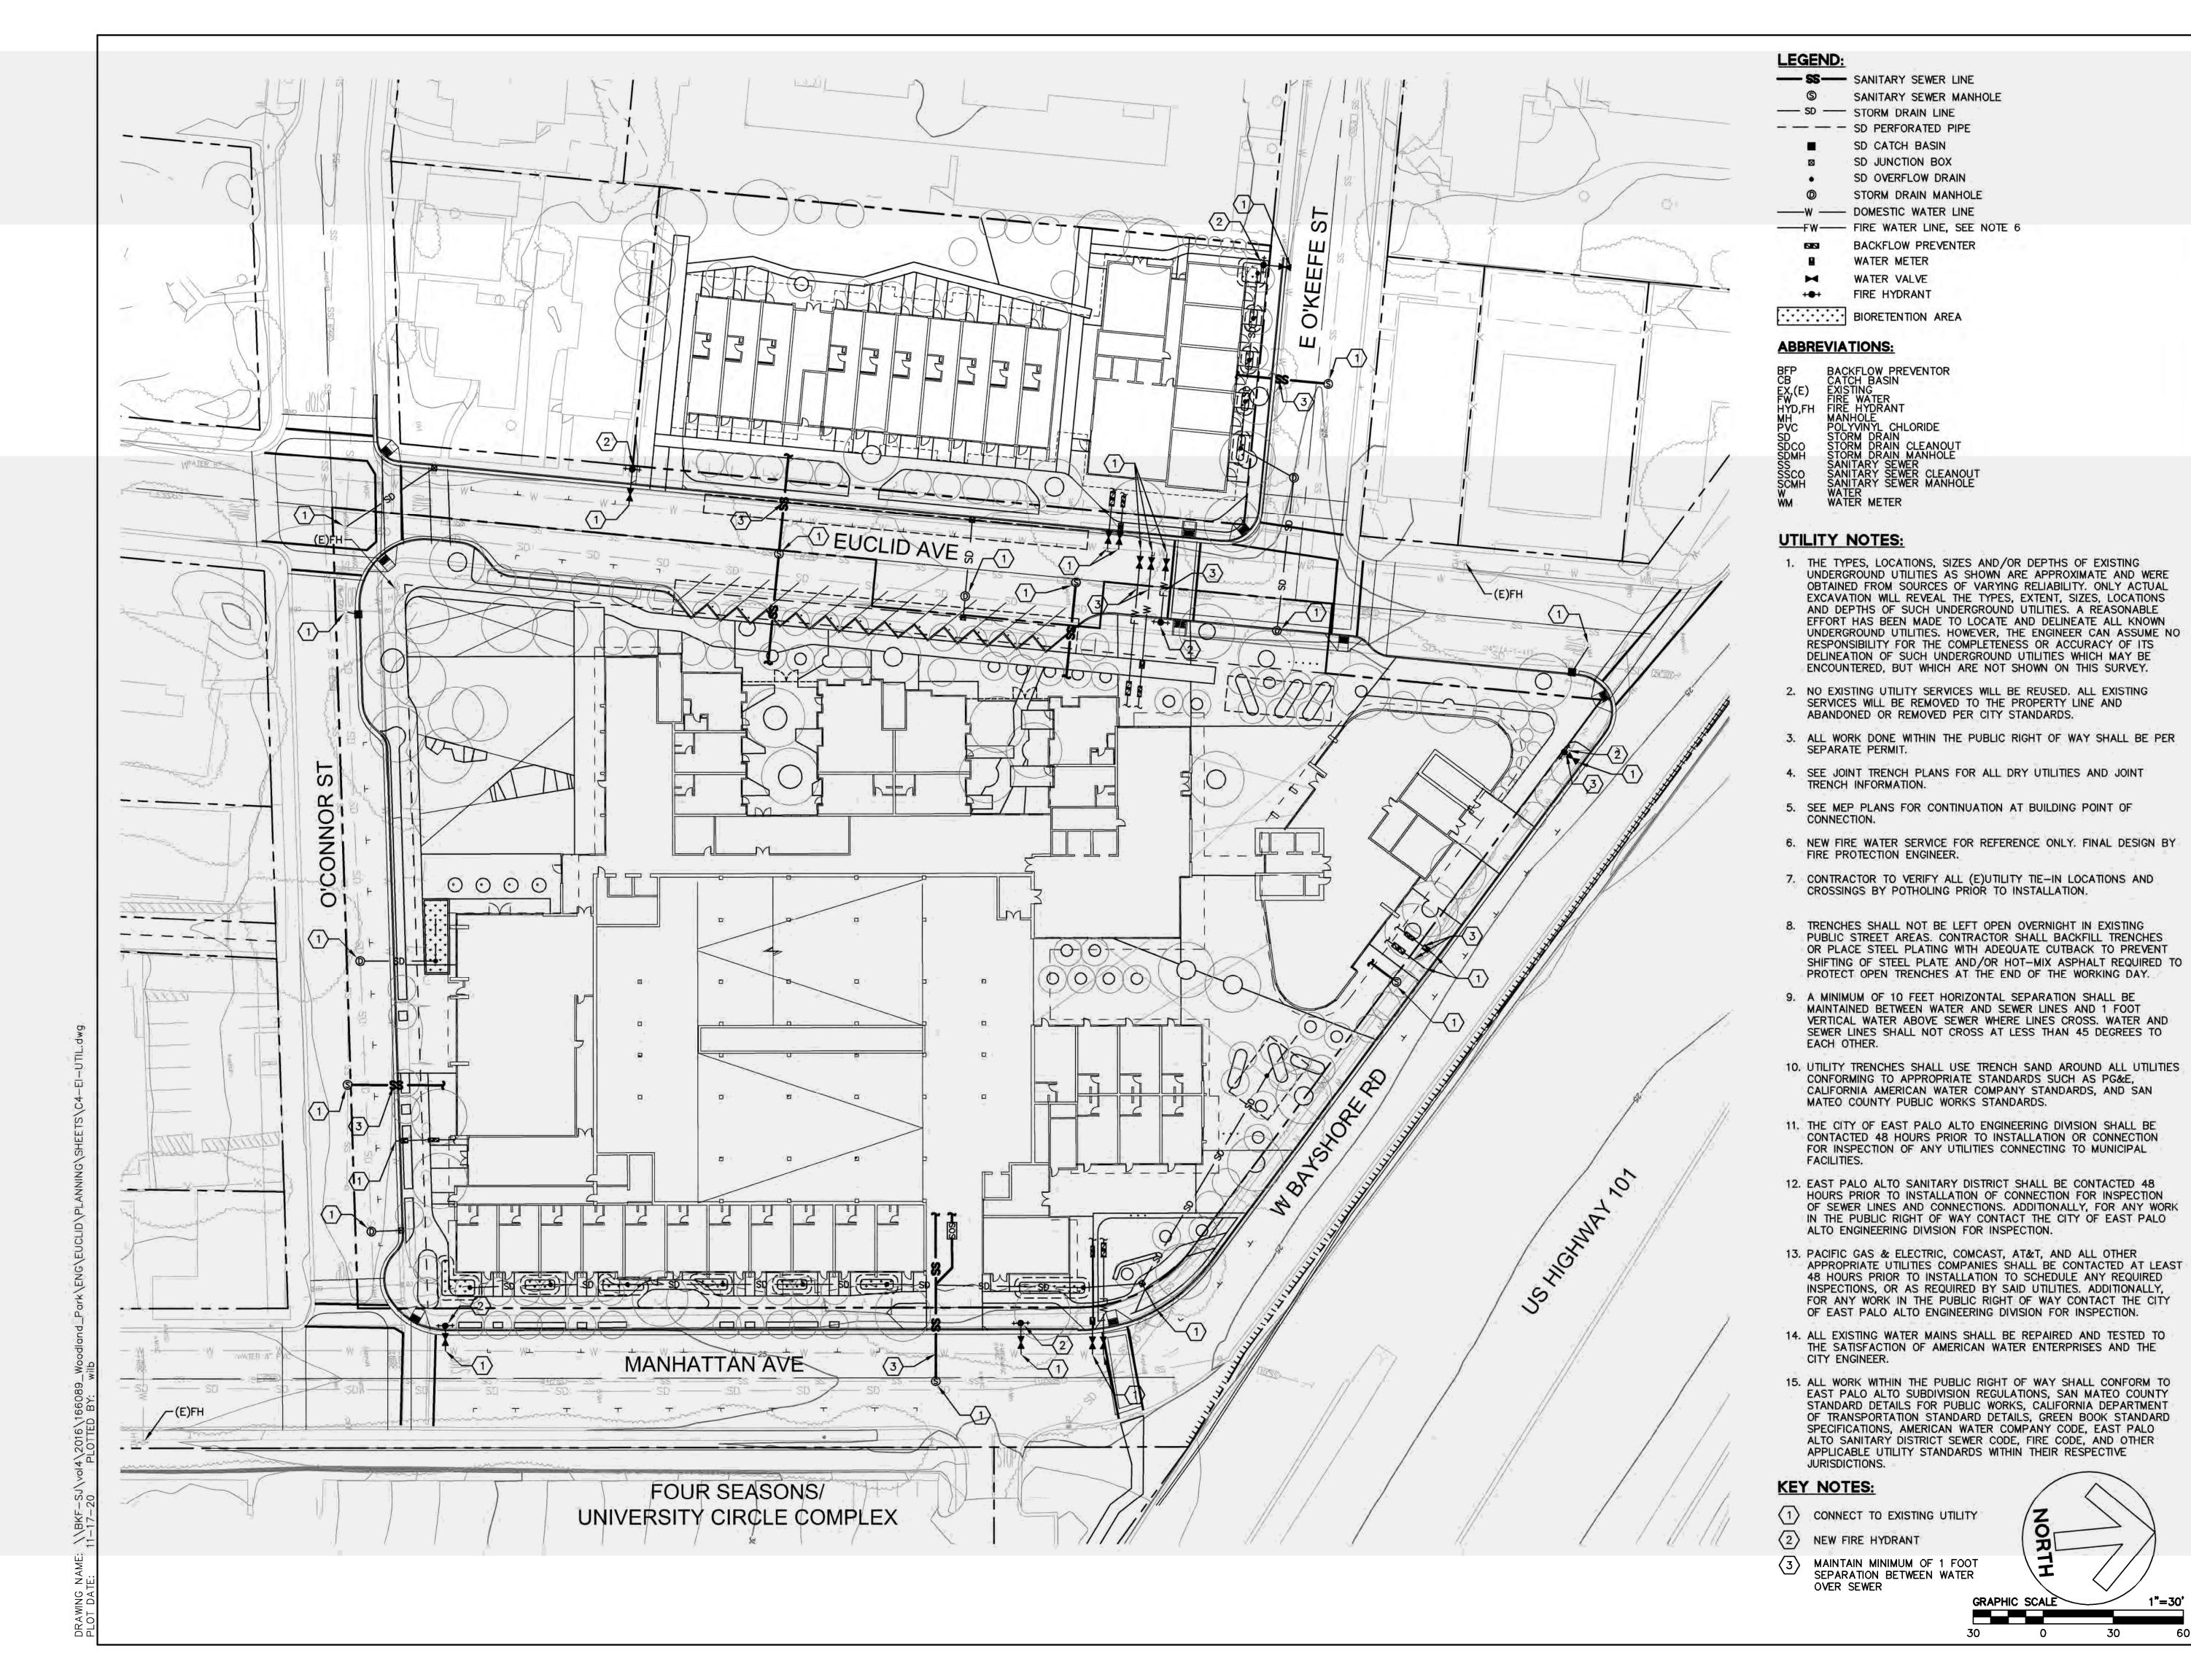
Drawing Title

PRELIMINARY GRADING AND DRAINAGE PLAN

Sheet No.

C3.0

Date 2020-11-17 Project No. 20166089-20



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PRELIMINARY UTILITY PLAN

Sheet No.

Date 20166089-20 Project No.

1"=30'

2020-11-17


YEARS

Entitlements Submission 09/25/2019

Set Title September 2019

Drawing Title

C4.0

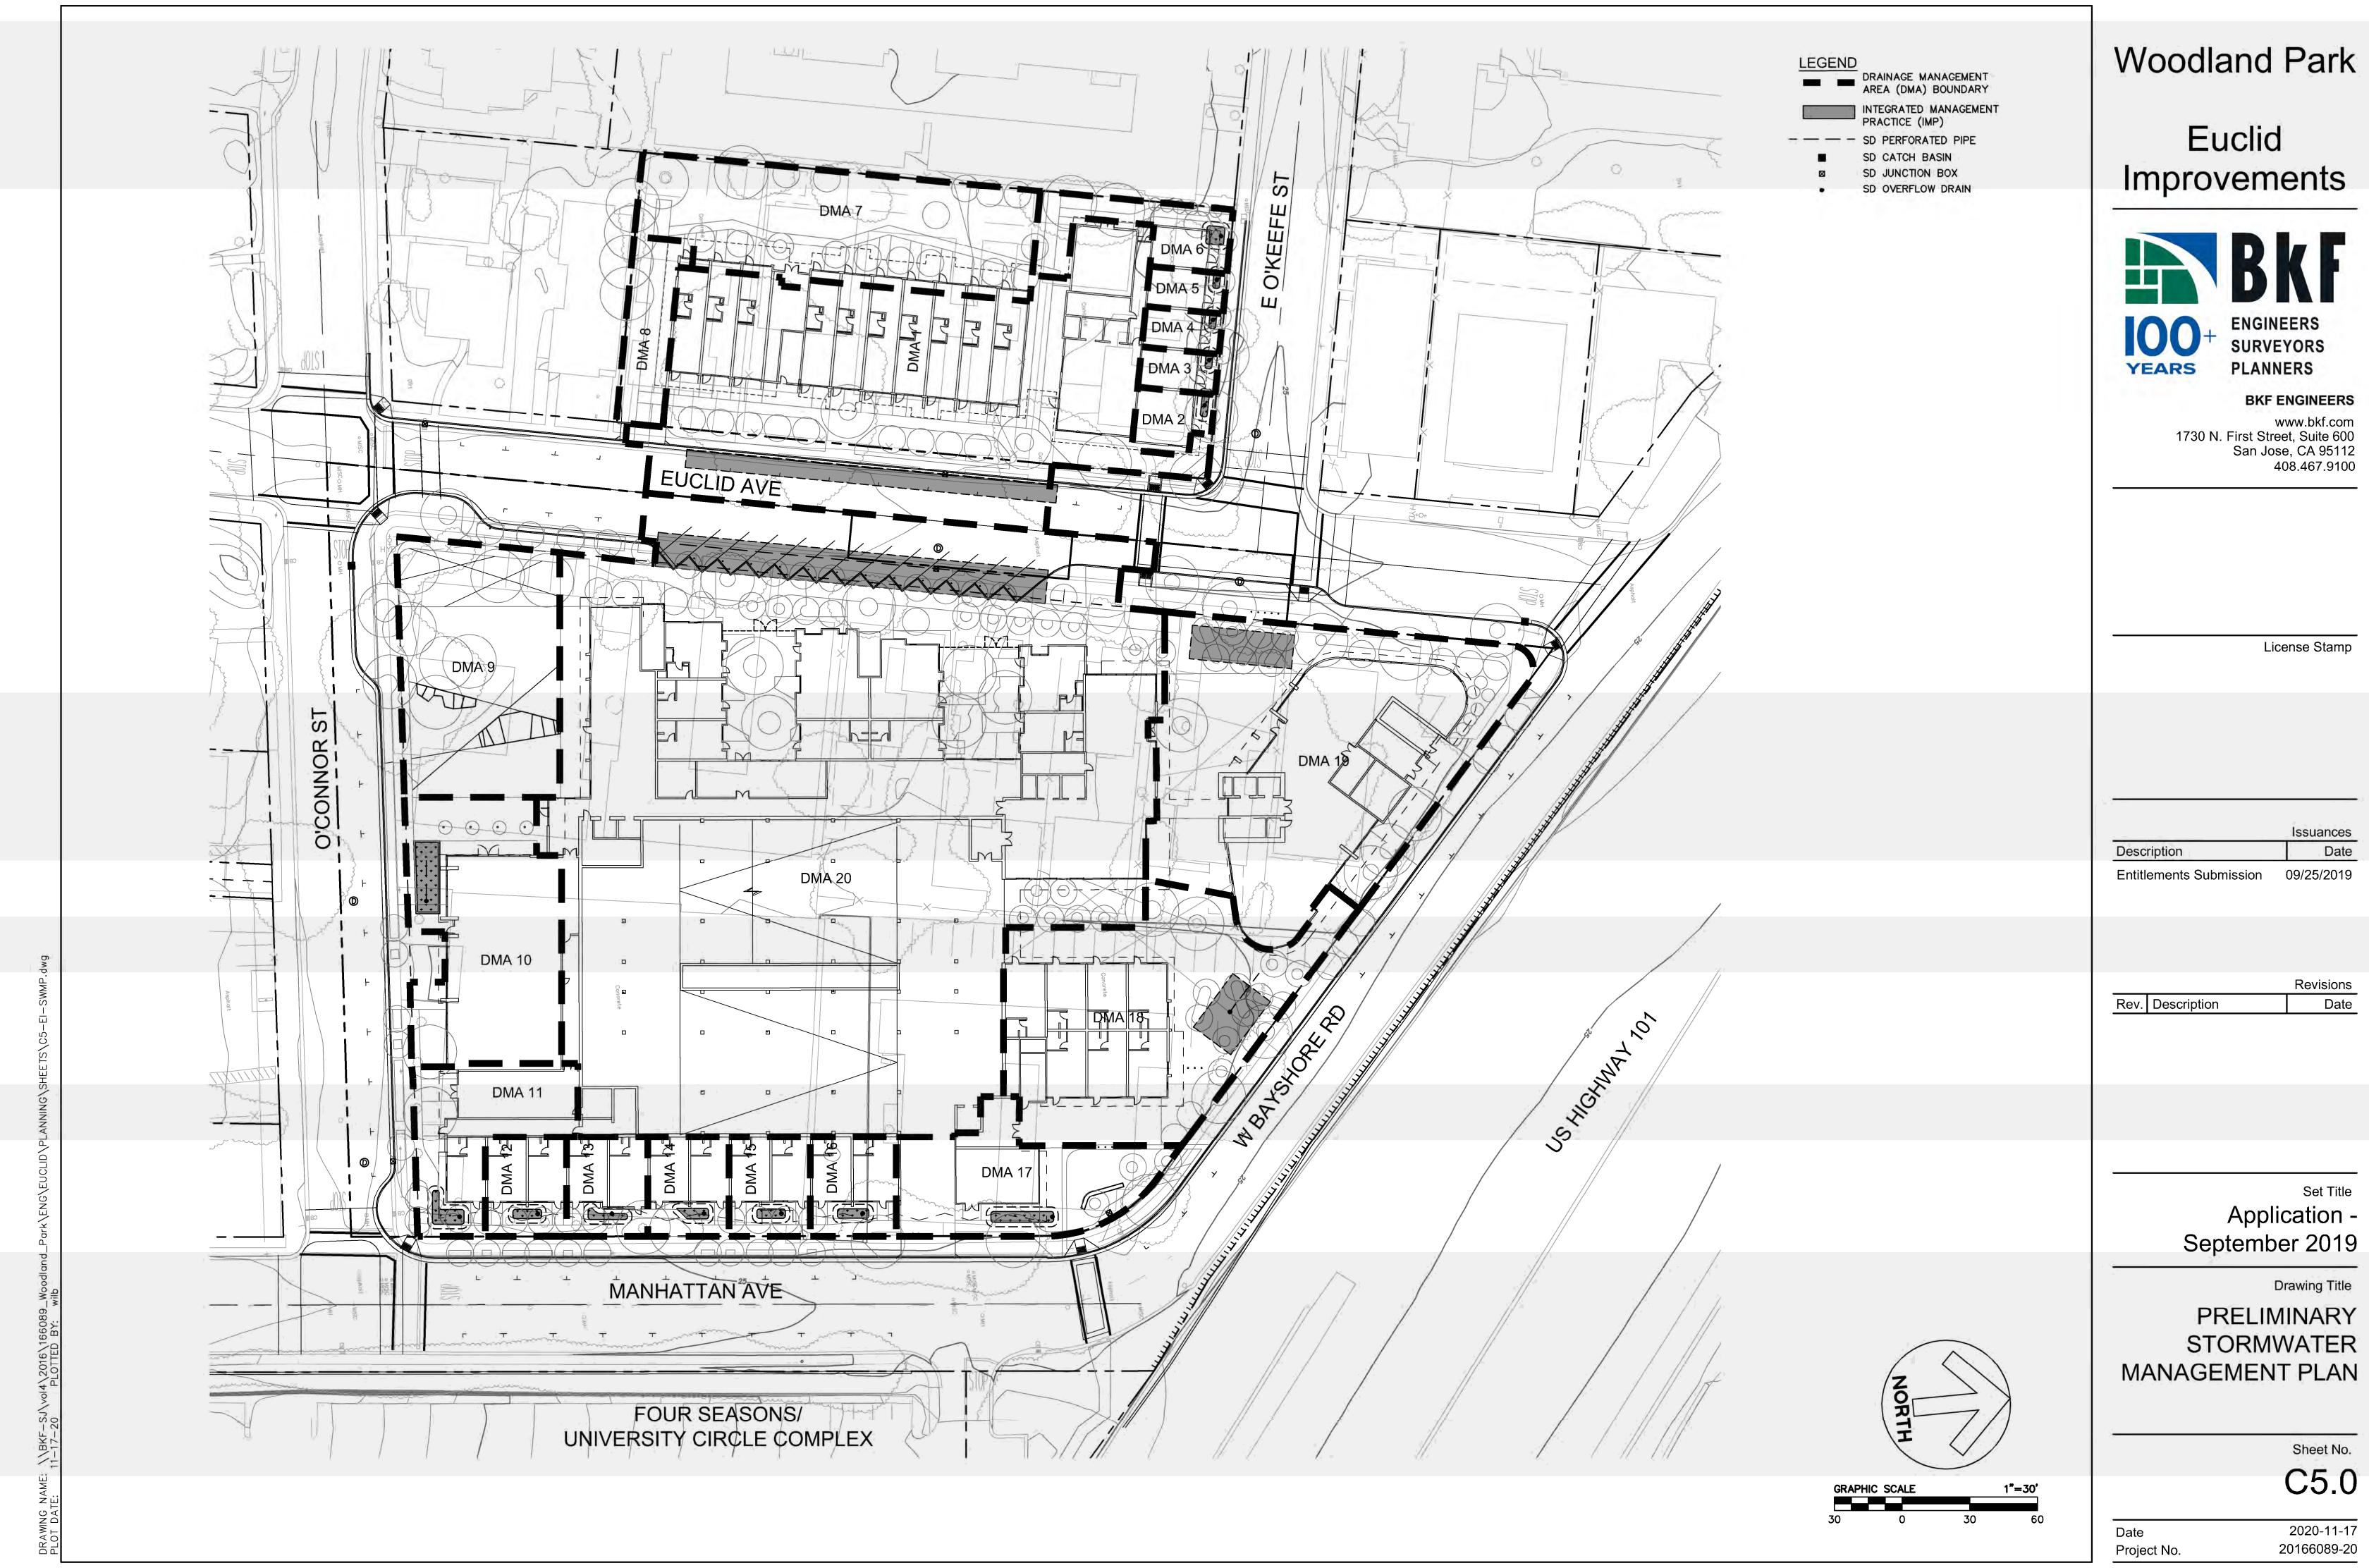

PRELIMINARY STORMWATER

TREATMENT CONTROL MEASURE SUMMARY EXISTING CONDITION TREATMENT MEASURE SIZE PROPOSED CONDITION DRAINAGE DRAINAGE AREA TREATMENT MEASURE TYPE PERVIOUS SURFACE IMPERVIOUS SURFACE PERVIOUS SURFACE IMPERVIOUS SURFACE REQUIRED PROVIDED AREAS SIZE (SF) (SF) (SF) (SF) (SF) (SF) (SF) STREETS/PARKING STREETS/PARKING MODULAR GRID BIORETENTION LANDSCAPE 9,260 LANDSCAPE 5,655 22,160 799 1,320 DMA-1 ROOF/SIDEWALK 14,320 2,340 2,185 ROOF/SIDEWALK (E.G. SILVA CELL) 10,560 LANDSCAPE 100 ROOF/SIDEWALK 780 LANDSCAPE ROOF/SIDEWALK NON-STRUCTURAL 880 31 31 DMA-2 BIORETENTION AREA LANDSCAPE 110 LANDSCAPE ROOF/SIDEWALK 420 ROOF/SIDEWALK 510 NON-STRUCTURAL DMA-3620 22 22 **BIORETENTION AREA** STREETS/PARKING LANDSCAPE LANDSCAPE NON-STRUCTURAL ROOF/SIDEWALK 620 20 22 DMA-4 **BIORETENTION AREA** ROOF/SIDEWALK 100 STREETS/PARKING 495 LANDSCAPE 110 ROOF/SIDEWALK 510 LANDSCAPE NON-STRUCTURAL DMA-5 620 20 22 **BIORETENTION AREA** STREETS/PARKING 455 LANDSCAPE ROOF/SIDEWALK 1,575 LANDSCAPE NON-STRUCTURAL 1,925 63 DMA-6 63 1,090 350 **BIORETENTION AREA** ROOF/SIDEWALK 380 STREETS/PARKING LANDSCAPE 1,030 LANDSCAPE 1,810 ROOF/SIDEWALK 6,600 STRUCTURAL DMA-7 8,410 336 336 ROOF/SIDEWALK BIORETENTION AREA 3,570 STREETS/PARKING LANDSCAPE 1,795 N/A N/A N/A N/A DMA-8 PERMEABLE PAVERS ROOF/SIDEWALK 1,090 STREETS/PARKING LANDSCAPE 7,905 N/A N/A N/A N/A DMA-9 PARK: SELF-TREATING AREA 3,065 ROOF/SIDEWALK 4,200 STREETS/PARKING LANDSCAPE 2,000 ROOF/SIDEWALK STRUCTURAL N/A DMA-10 7,405 296 300 ROOF/SIDEWALK 7,405 BIORETENTION AREA LANDSCAPE 980 ROOF/SIDEWALK 2,725 ROOF/SIDEWALK 2,725 LANDSCAPE NON-STRUCTURAL 3,705 109 DMA-11 115 **BIORETENTION AREA** ROOF/SIDEWALK 1,135 LANDSCAPE ROOF/SIDEWALK 1,275 LANDSCAPE NON-STRUCTURAL 1,585 51 DMA-12 51 BIORETENTION AREA LANDSCAPE 310 ROOF/SIDEWALK 1,250 ROOF/SIDEWALK 1,275 LANDSCAPE NON-STRUCTURAL 1,585 DMA-13 51 51 **BIORETENTION AREA** LANDSCAPE 310 ROOF/SIDEWALK 1,315 ROOF/SIDEWALK 1,275 LANDSCAPE NON-STRUCTURAL 1,585 DMA-14 51 51 **BIORETENTION AREA** ROOF/SIDEWALK 1,415 LANDSCAPE 310 ROOF/SIDEWALK 1,275 LANDSCAPE NON-STRUCTURAL 1,585 51 51 DMA-15 **BIORETENTION AREA** 170 LANDSCAPE 285 ROOF/SIDEWALK 1,390 LANDSCAPE 25 ROOF/SIDEWALK 1,650 NON-STRUCTURAL 1,675 56 DMA-16 56 BIORETENTION AREA LANDSCAPE 1,645 ROOF/SIDEWALK 3,230 ROOF/SIDEWALK 4,860 LANDSCAPE NON-STRUCTURAL 4,875 DMA-17 129 129 **BIORETENTION AREA** STREETS/PARKING 6,710 ROOF/SIDEWALK 11,730 LANDSCAPE STRUCTURAL N/A 11,730 469 DMA-18 490 BIORETENTION AREA ROOF/SIDEWALK 4,900 STREETS/PARKING 100 LANDSCAPE 3,675 ROOF/SIDEWALK MODULAR GRID BIORETENTION LANDSCAPE 16,730 522 680 DMA-19 6,520 (E.G. SILVA CELL) ROOF/SIDEWALK 13,055 10,110 STREETS/PARKING STREETS/PARKING MODULAR GRID BIORETENTION LANDSCAPE 12,520 29,270 N/A 64,930 2,597 2,604 DMA-20 ROOF/SIDEWALK 41,995 ROOF/SIDEWALK 35,660 10,415 (E.G. SILVA CELL)

162,325

28,480

133,845

12,600

140,025

5,673

6,406

TOTAL

NOTES

1) TREATMENT AREAS WERE SIZED USING THE "4 PERCENT METHOD" FLOW-BASED SIZING CRITERIA IN THE 2014 SAN MATEO COUNTY C.3 STORMWATER TECHNICAL GUIDANCE HANDBOOK.

Woodland Park

Euclid Improvements



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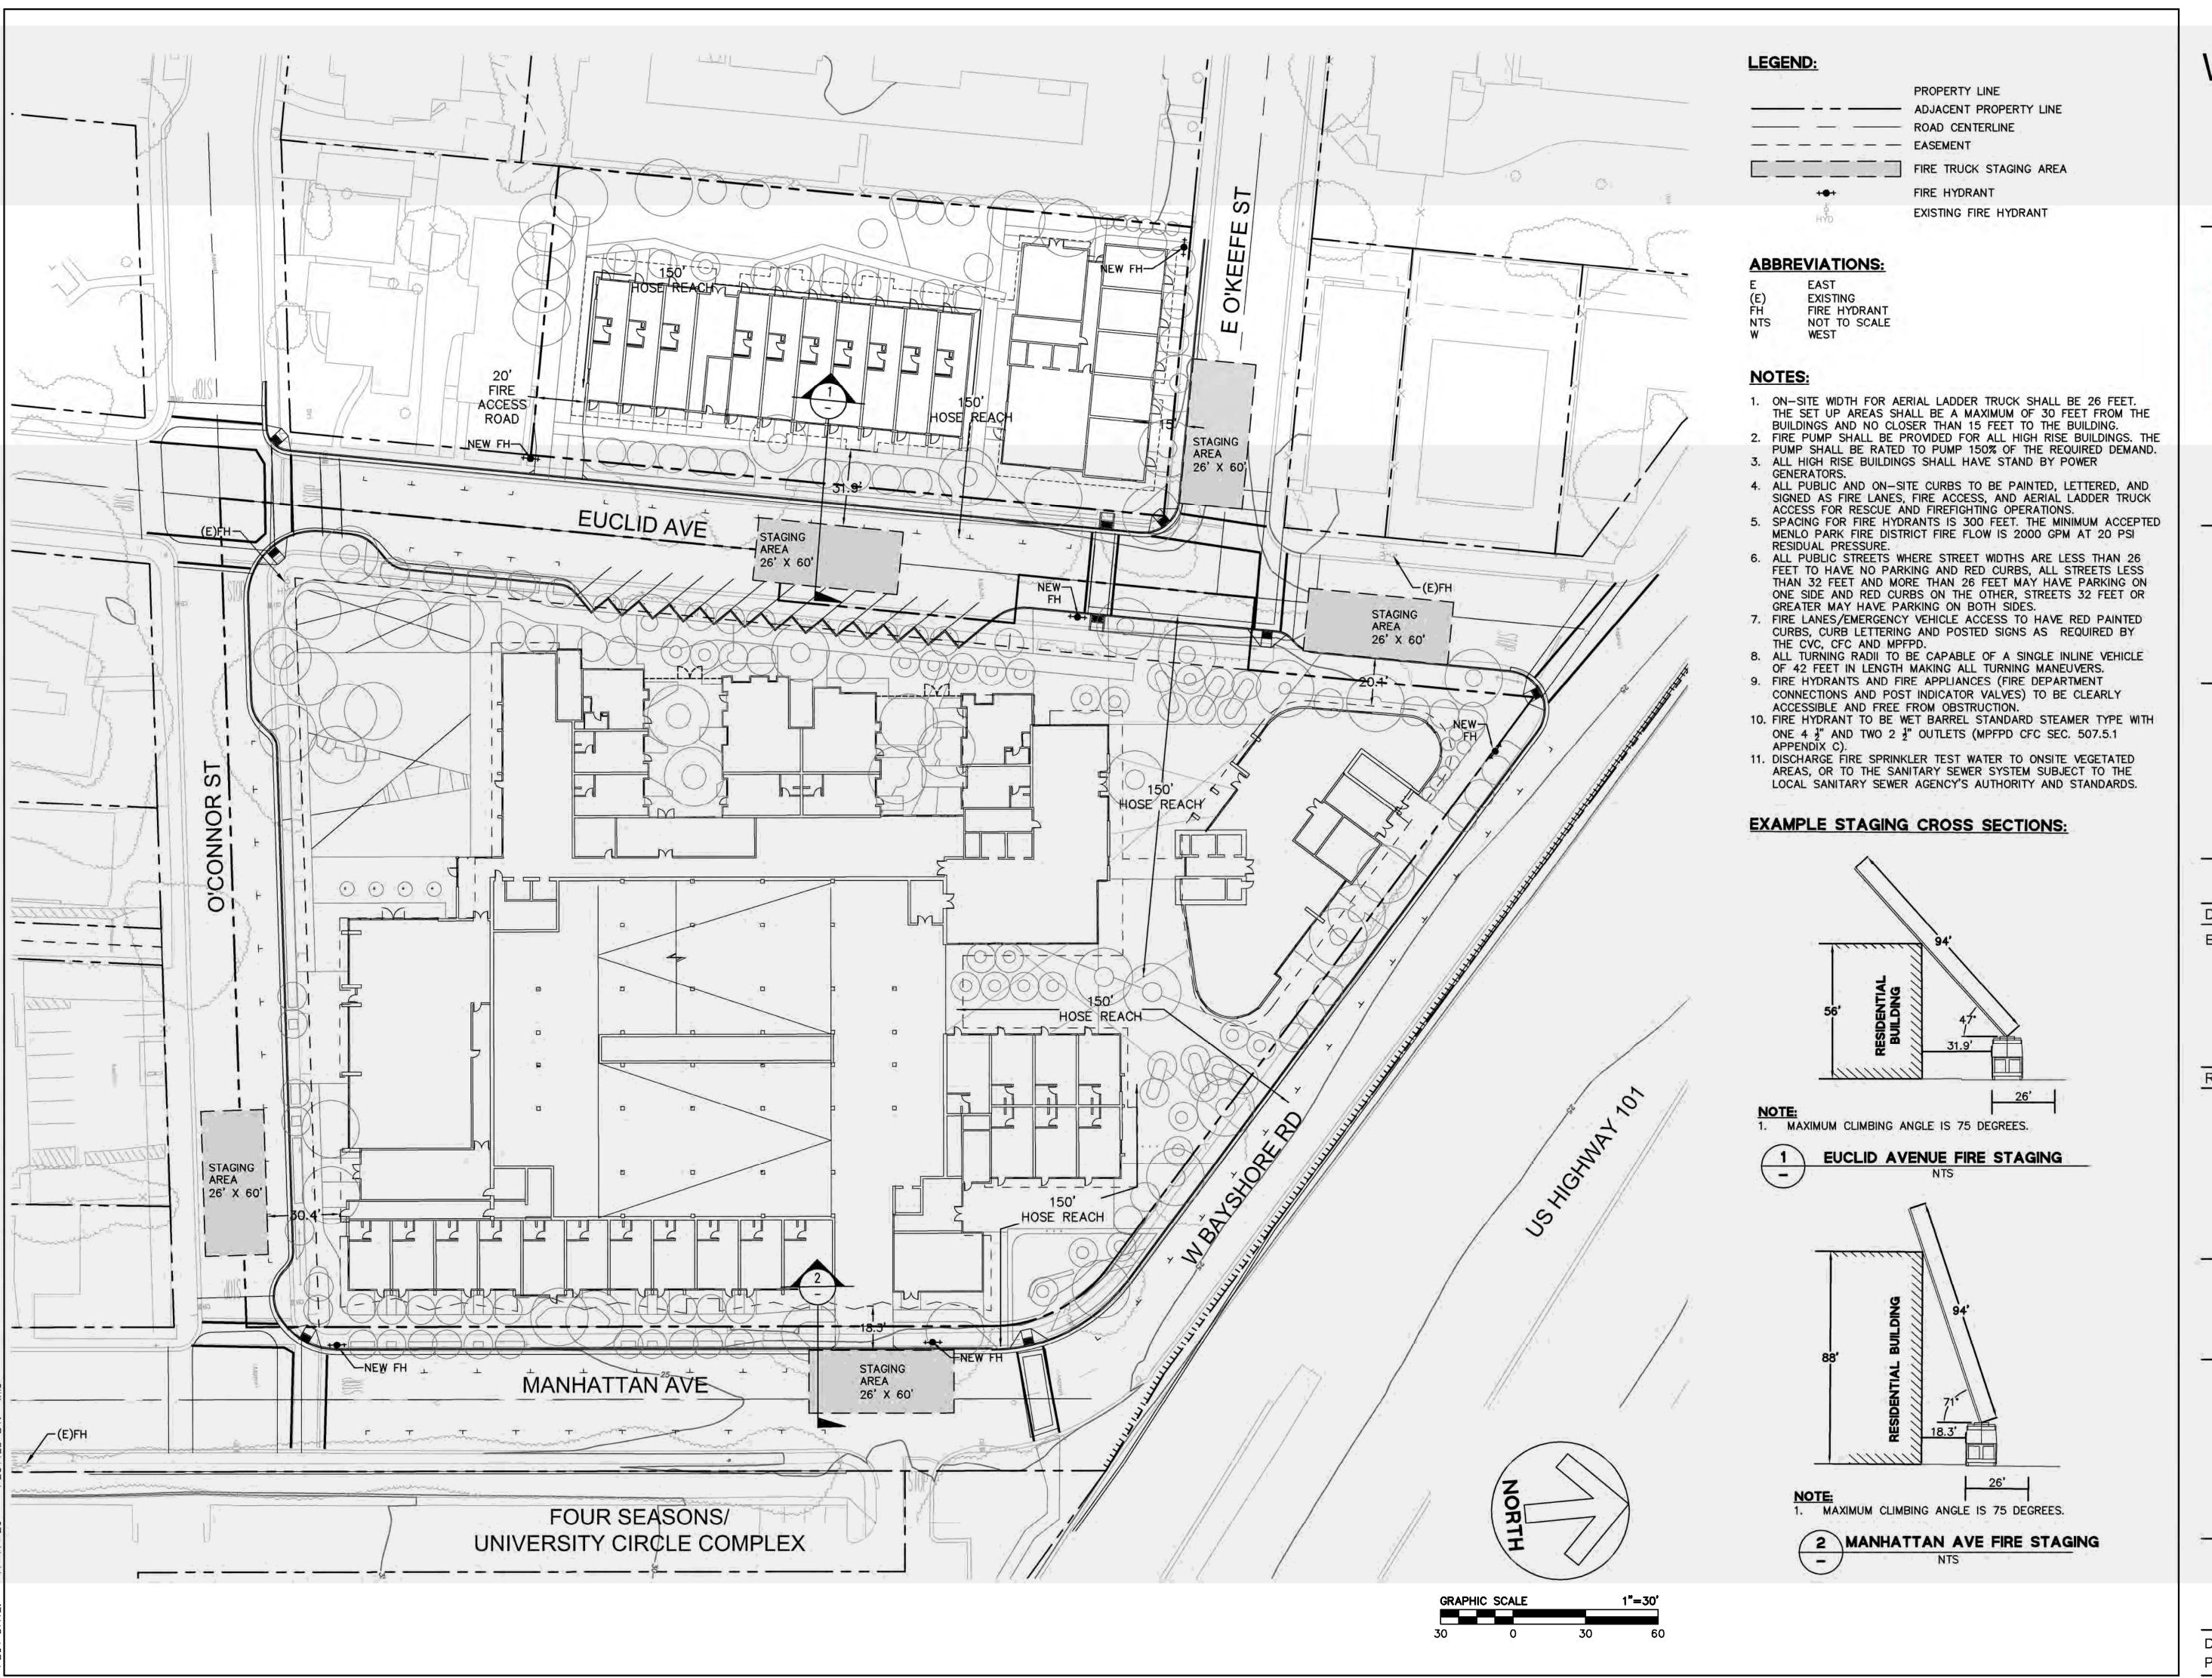
PRELIMINARY STORMWATER MANAGEMENT PLAN

Sheet No.

C5.1

2020-11-17 20166089-20 Project No.

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PRELIMINARY FIRE ACCESS PLAN

Sheet No.

C6.0

Project No. 20166089-20

ABBREVIATIONS

EXISTING

TYPICAL

INDEX

TITLE SHEET

MAPPING SHEET

NOT TO SCALE


RIGHT OF WAY

SQUARE FEET

Drawing Number:

VESTING TENTATIVE PARCEL MAP **EUCLID IMPROVEMENTS**

EAST PALO ALTO, SAN MATEO COUNTY, CA CONSISTING OF 1 VERTICAL AIRSPACE LOT FOR

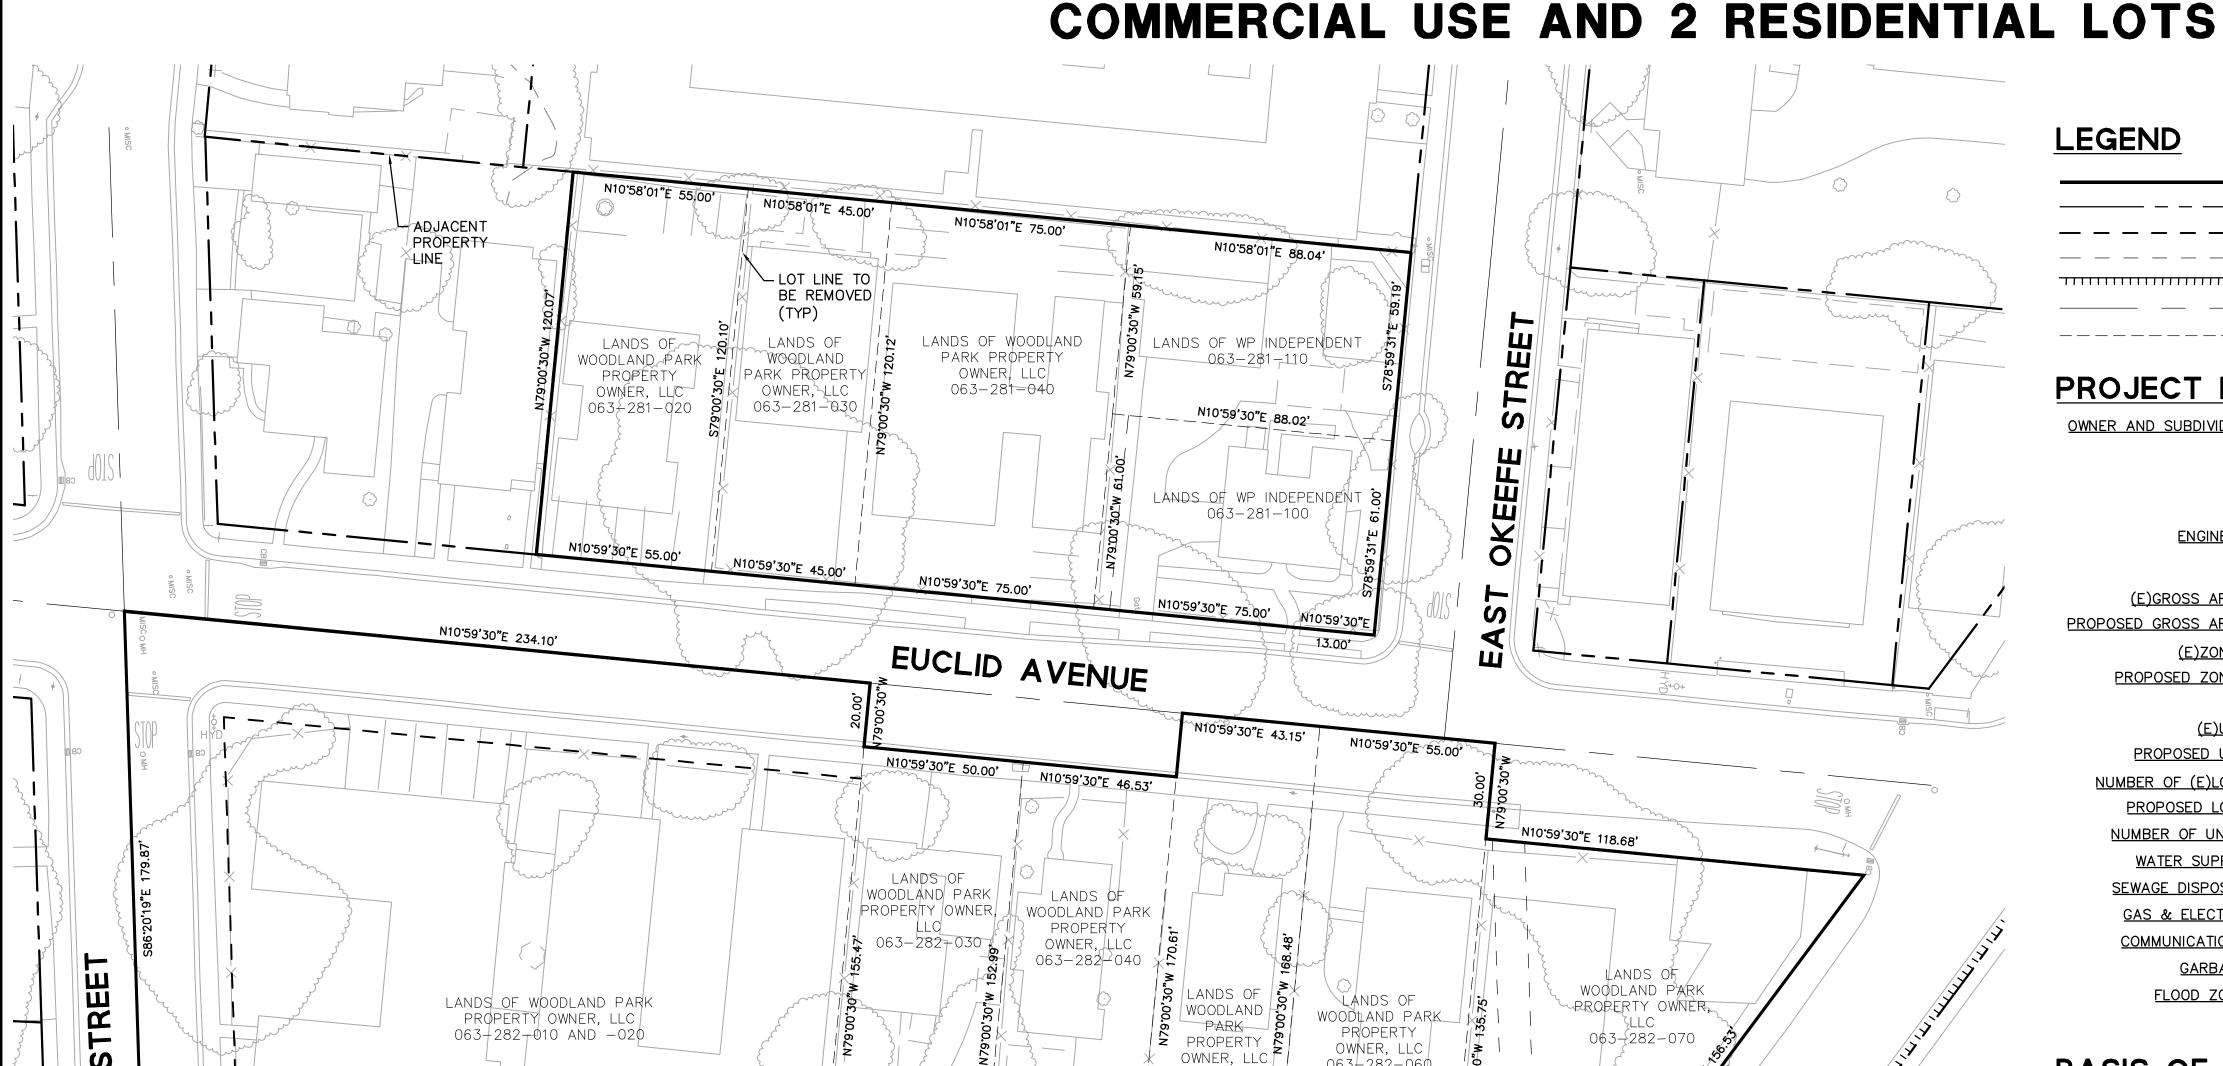

LOT LINE TO — BE REMOVED

EASEMENT TO BE REMOVED (TYP)

LANDS OF WOODLAND PARK

PROPERTY OWNER, LLC

063-282-090

N05'24'30"E 230,01

MANHATTAN AVENUE

ONNOR

0

063-282-060

113±SF OF PUBLIC R/W — TO BE VACATED BY CITY OF EAST PALO ALTO

063-282-050

LANDS OF WOODLAND PARK

PROPERTY OWNER, LLC

063-282-080

N05'24'30"E

N05°24'30"E 50.00'

LEGEND

PROJECT BOUNDARY LINE ADJACENT PROPERTY LINE (E)EASEMENT CENTERLINE

PROJECT DATA

WOODLAND PARK PROPERTY OWNER, LLC

965 PAGE MILL ROAD PALO ALTO, CA, 94304 CONTACT: MICHAEL KRAMER

(E)LOT LINE TO BE REMOVED

BKF ENGINEERS 1730 N. FIRST STREET, SUIT 600 SAN JOSE, CA 95112

(E)GROSS AREA: PROPOSED GROSS AREA ± 3.93 ACRES R-HD-5 AND R-UHD

> R-HD-5 AND R-UHD WITH OVERLAY (SEE GENERAL NOTE 5)

PROPOSED USE: RESIDENTIAL/COMMERCIAL

NUMBER OF (E)LOTS: PROPOSED LOTS: NUMBER OF UNITS:

AMERICAN WATER SERVICES

COMMUNICATIONS: AT&T, COMCAST

FLOOD ZONE: ZONE X, AREA OF MINIMAL FLOOD HAZARD PER MAP 06081C0309F EFFECTIVE 4/5/2019.

THE BEARING, NO4'43'36"E, TAKEN ON THE CENTERLINE OF MANHATTAN AVENUE AS SHOWN ON THAT CERTAIN PARCEL MAP FILED FOR RECORD ON MAY 17TH, 2000 IN BOOK 72 OF PARCEL MAPS AT PAGES 70-75, SAN MATEO COUNTY RECORDS, WAS TAKEN AS THE BASIS OF ALL BEARINGS SHOWN HEREON

THIS VESTING TENTATIVE PARCEL MAP SUBMITTAL HAS BEEN PREPARED BY ME OR UNDER MY DIRECTION IN ACCORDANCE WITH STANDARD ENGINEERING

COLE GAUMNITZ No.75787 EXP 06/30/20

- 1. VESTING TENTATIVE MAP: THIS VESTING TENTATIVE MAP IS BEING FILED IN ACCORDANCE WITH ARTICLE 2, SECTION 86452 AND CHAPTER 4.5 OF THE SUBDIVISION ACT MAP.
- 2. BUILDING TYPE: THE BUILDING FOOTPRINTS SHOWN ARE FOR CONCEPTUAL PURPOSES ONLY. THE BUILDING TYPE, LOCATION AND STYLES WILL BE PERMITTED AS CONSTRUCTED IN CONFORMANCE WITH PROJECT PLANNING REQUIREMENTS PRIOR TO THE APPLICATION FOR BUILDING PERMITS.
- 3. MULTIPLE FINAL MAPS: PURSUANT TO SECTION 66456.1 OF THE SUBDIVISION MAP ACT, THE DEVELOPER RESERVES THE RIGHT TO FILE MULTIPLE FINAL MAPS. ONLY THE IMPROVEMENTS REQUIRED TO SUPPORT THE LEVEL OF DEVELOPMENT, AS DETERMINED BY THE CITY, OF EACH PARTICULAR FINAL MAP NEEDS TO BE COMPLETED OR BOUNDED.
- 4. APPROXIMATELY 113 SF OF PUBLIC R/W ON WEST BAYSHORE ROAD TO BE VACATED BY THE CITY OF EAST PALO ALTO.
- 5. THESE PARCELS WILL BE PART OF A NEW NEIGHBORHOOD CENTER RESIDENTIAL OVERLAY (NCO) TO AUTHORIZE GROUND-FLOOR NEIGHBORHOOD-SERVING COMMERCIAL AND COMMUNITY USES AND ADDITIONAL HOUSING UNITS IN SELECT PORTIONS OF THE MULTIPLE-FAMILY HIGH DENSITY RESIDENTIAL ZONE (R-HD-5) AND THE MULTIPLE-FAMILY URBAN HIGH DENSITY RESIDENTIAL ZONES (R-UHD),

PROJECT DESCRIPTION

WITH NO DISPLACEMENT, THIS PROJECT PROPOSES THE REPLACEMENT OF SEVERAL AGING, OUTDATED STRUCTURES CONTAINING 160 RENT-STABILIZED HOUSING UNITS AND ONE SINGLE FAMILY RENTAL (NON-RSO) WITH NEW MIXED-INCOME BUILDINGS CONTAINING 605 APARTMENTS, 26% OF WHICH WILL BE DEED-RESTRICTED RENT-CONTROLLED, REPLACING THE EXISTING APARTMENTS ONE-FOR-ONE.

(E)EASEMENT TO BE QUITCLAIMED RELINQUISHMENT OF ABUTTERS RIGHTS

AND WP INDEPENDENT, LLC

± 3.92 ACRES

PROPOSED ZONES:

RESIDENTIAL (E)USE:

GAS & ELECTRIC: PACIFIC GAS AND ELECTRIC


GARBAGE: RECOLOGY

BASIS OF BEARING

N	GINE	ER'S	STA	TE	MENT	•	
						· <u>-</u>	

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GENERAL NOTES

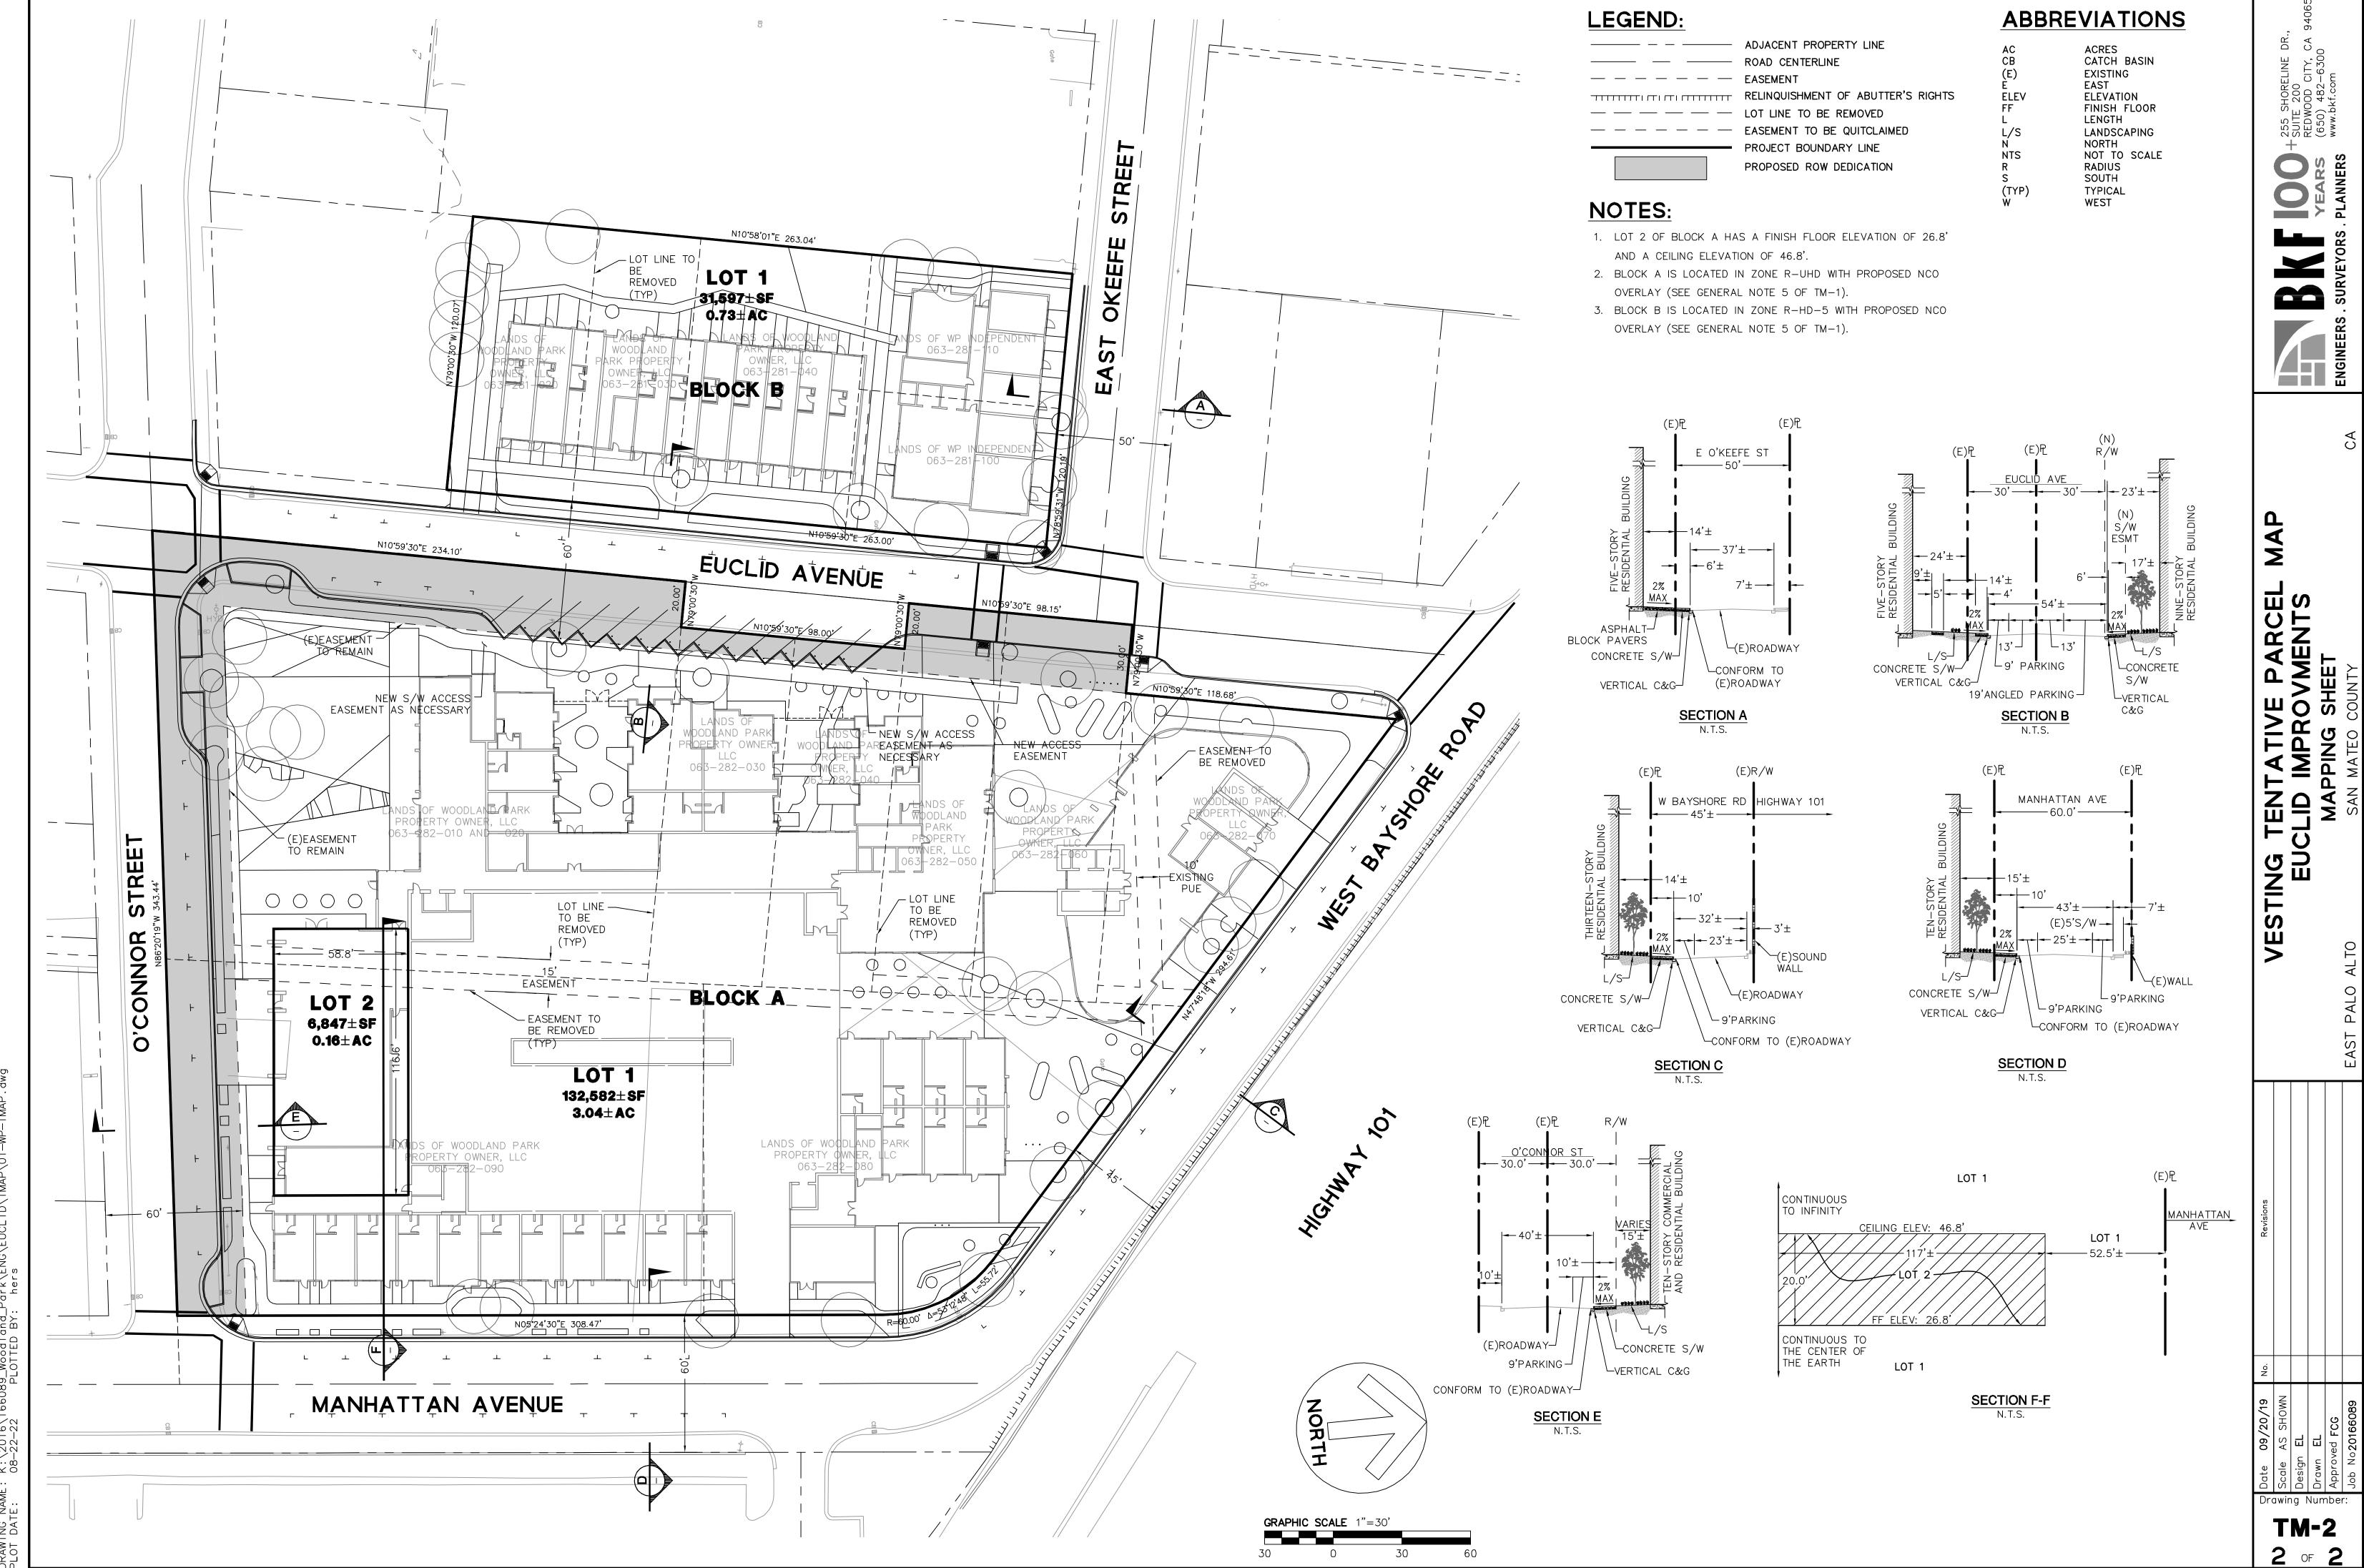

ENGI


TM-2



2 DONOHOE ST. ELEVATION 1/16" = 1'-0"

PUMP HOUSE WATER TANK DUMBARTON AVE.

3 W.BAYSHORE ELEVATION 1/16" = 1'-0"

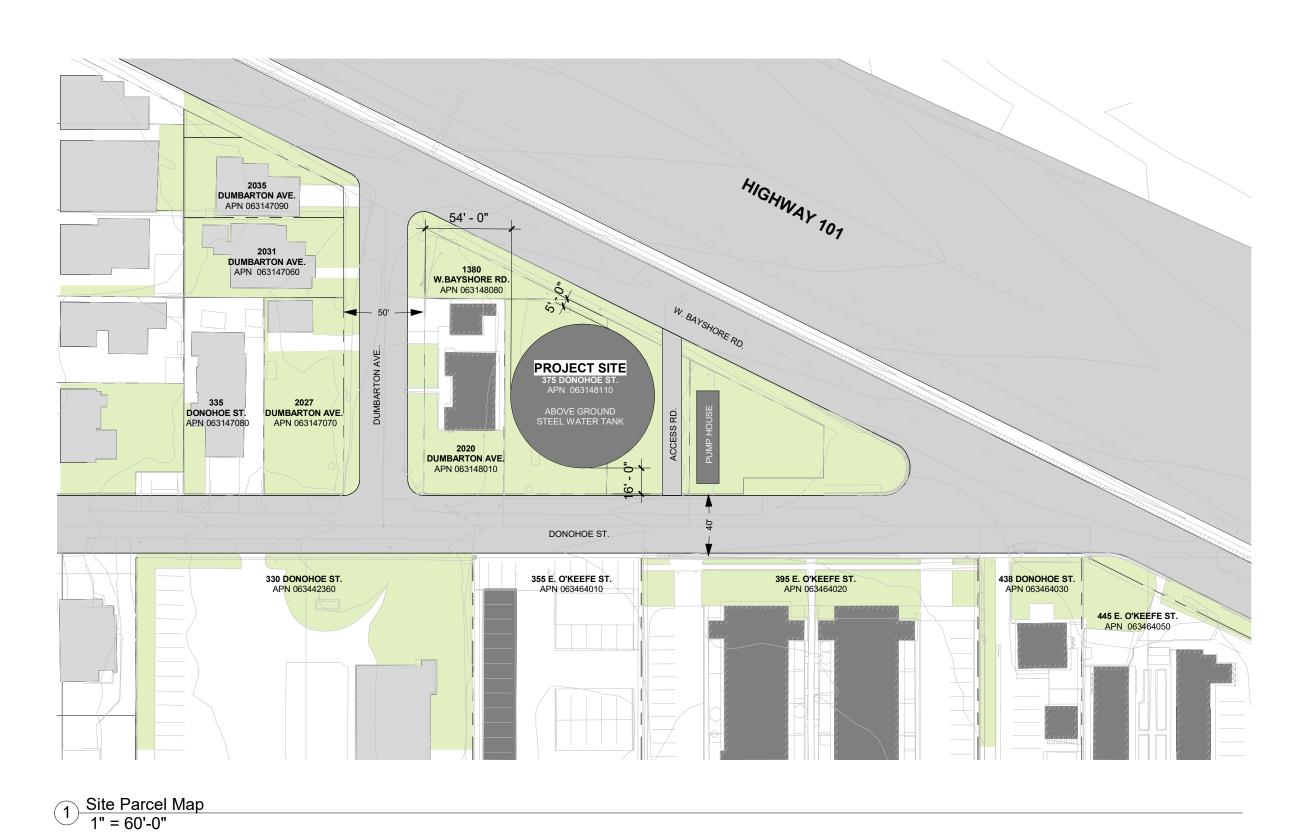

3D View - Donohoe St.

Woodland Park Euclid Improvements



David Baker Architects

dbarchitect.com 461 Second St, Loft c127 San Francisco, CA 94107 415.896.6700

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WATER TANK EXHIBIT

WT-001