# Four Seasons Temporary Skate Area

CHANG ARCHITECTURE Architecture | Planning | Interiors

**University Circle** 

Fax: 650.340.9641 Web: www.changarchitecture.com

**ADDRESS:** 2050 UNIVERSITY AVE, EAST PALO ALTO

**JANITOR** 

MACHINE MANUFACTURER

MECHANICAL

MINIMUM

NOMINAL

ON CENTER

PAINT/POINT

PLASTIC

PLATE

PLYWOOD

POLISHED

QUANTITY

RADIUS REINFORCED

REQUIRED

ROUGH OPENING

STAINLESS STEEL

SIMILAR

STEEL

STORAGE STRUCTURAL

NOT INCLUDED

JOINT

CLIENT:

ALUM.

**APPROX** 

BOTT. BD.

BLDG.

CEM. CLG. CLR. COL. CONC. CTR.

CMU CONST.

CONT.

CONTR.

DEMO

DIA.

DN

DWG.

ELEC.

EQUIP.

(E)

ÈXT.

FLR. FURN.

JOB NAME:

#### **ABBREVIATIONS**

AIR CONDITIONING

APPROXIMATE

CABINET

CEMENT

CEILING

CONCRETE

COUNTER

CONSTRUCTION

CONTINUOUS

CONTRACTOR

DEMOLITION

DIAMETER

DOWN

DRAWING

ELECTRICAL

EQUIPMENT

**EXISTING** 

EXTERIOR

**FURNISH** 

FINISH FLOOR FIRE RESISTIVE

CONCRETE MASONRY UNIT

CLEAR COLUMN

#### PROJECT DESCRIPTION + SUMMARY

DESCRIPTION: THIS PROJECT INCLUDES A TEMPORARY OUTDOOR SYNTHETIC ISKATE AREA LOCATED IN AN EXISTING PARKING LOT AT THE UNIVERSITY CIRCLE OFFICE COMPLEX. THE SKATE AREA WILL BE LOCATED BETWEEN THE FOUR SEASONS HOTELAND 1950 UNIVERSITY AVE BUILDING. THE SKATE SURFACE IS SYNTHETIC ICE COMPOSED OF INTERLOCKING 4'x8' PANELS OVER 4'x8' SHEETS OF POLYETHELENE. THERE IS A 42" TALL FENCE SURROUNDING THE SKATE AREA TO DILINEATE THE SKATING AREA (IT IS NOT A GUARD RAIL).. ADJACENT TO THE FENCED SKATE AREA IS A RUBBERIZED SAFETY SURFACE FOR SKATERS TO PUTTHEIR SKATES ON. THERE IS A PRE-MANUFACTURED SKATE SHOP MADE OF WOOD AND A SIMILAR ONE FOR HANDING OUT SWEETS. (2) WATER-FILLED K-RAILS WILL BE PLACED BETWEEN DRIVE AISLES + THE RINK AREA FOR SAFETY THE AREA IS LIGHTED WITH AN EXISTING FLOOD LIGHT LOCATED ON THE ROOF OF THE FOUR SEASONS LOWER MECHANICAL BUILDING. BECAUSE THE SKATE AREA WILL BE LOCATED OVER (3) EXISTING HOTEL ADA STALLS, (3) NEW TEMPORARY ONES WILL BE LOCATED ACROSS THE DRIVE AISLE. PATRONS ARRIVING BY FOOT CAN ENTER VIA MULTIPLE ENTRIES OFF WOODLAND AND WALK TO THE SKATE AREA. THOSE ARRIVING BY CAR DRIVE TO THE HOTEL ENTRY AND THEIR CARS WILL BE VALET. DRIVERS CHOOSING TO SELF—PARK MAY PARK ADJACENT TO THE SKATE AREA.

THE TEMPORARY FENCE IS LOWER THAN 7', SO DOES NOT NEED TO BE PERMITTED. HOWEVER, DETAILS ARE SHOWN.

2019 CBC, CEC, CFC, CMC, CPC, CALIFORNIA STATE TITLE-24

	BUILDING STATISTICS
--	---------------------

SKATE AREA: PREMANUF. SHOPS

CONSTRUCTION TYPE:

PROPOSED OCCUPANCY:

A-41,760 SF

144 SF/EA. X 2 = 288 SF

TYPE V-B

#### SHEET INDEX

ARCHITECTURAL COVER


PROPOSED OVERALL SITE PLAN

RESTROOM ACCESS PLAN

PREFABRICATED SKATE SHOP

PREFABRICATED SKATE SHOP

#### **EXISTING SITE PLAN**

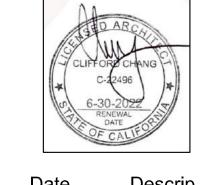

2/17/21 REVIEW 2/21/21 PERMIT SUBMIT

Temporary Ice Rink

Four Seasons

University Circle East Palo Alto, CA


COVER


A4095.00 12/17/21 AS NOTED BR + CC Drawn By:

Copyright 2022 by Chang Architecture, Inc.

- UNIVERSITY AVE -Drawing Title MANHATTAN AVE **EXISTING SITE PLAN** SCALE: 1"=100'

SUSPENDED TEMPORARY GYP. BD GYPSUM BOARD TAPE FLOAT & PAINT HEATING, VENTILATING & AC UNLESS OTHERWISE NOTED HOLLOW CORE INCLUDING WATER RESISTANT INTERIOR

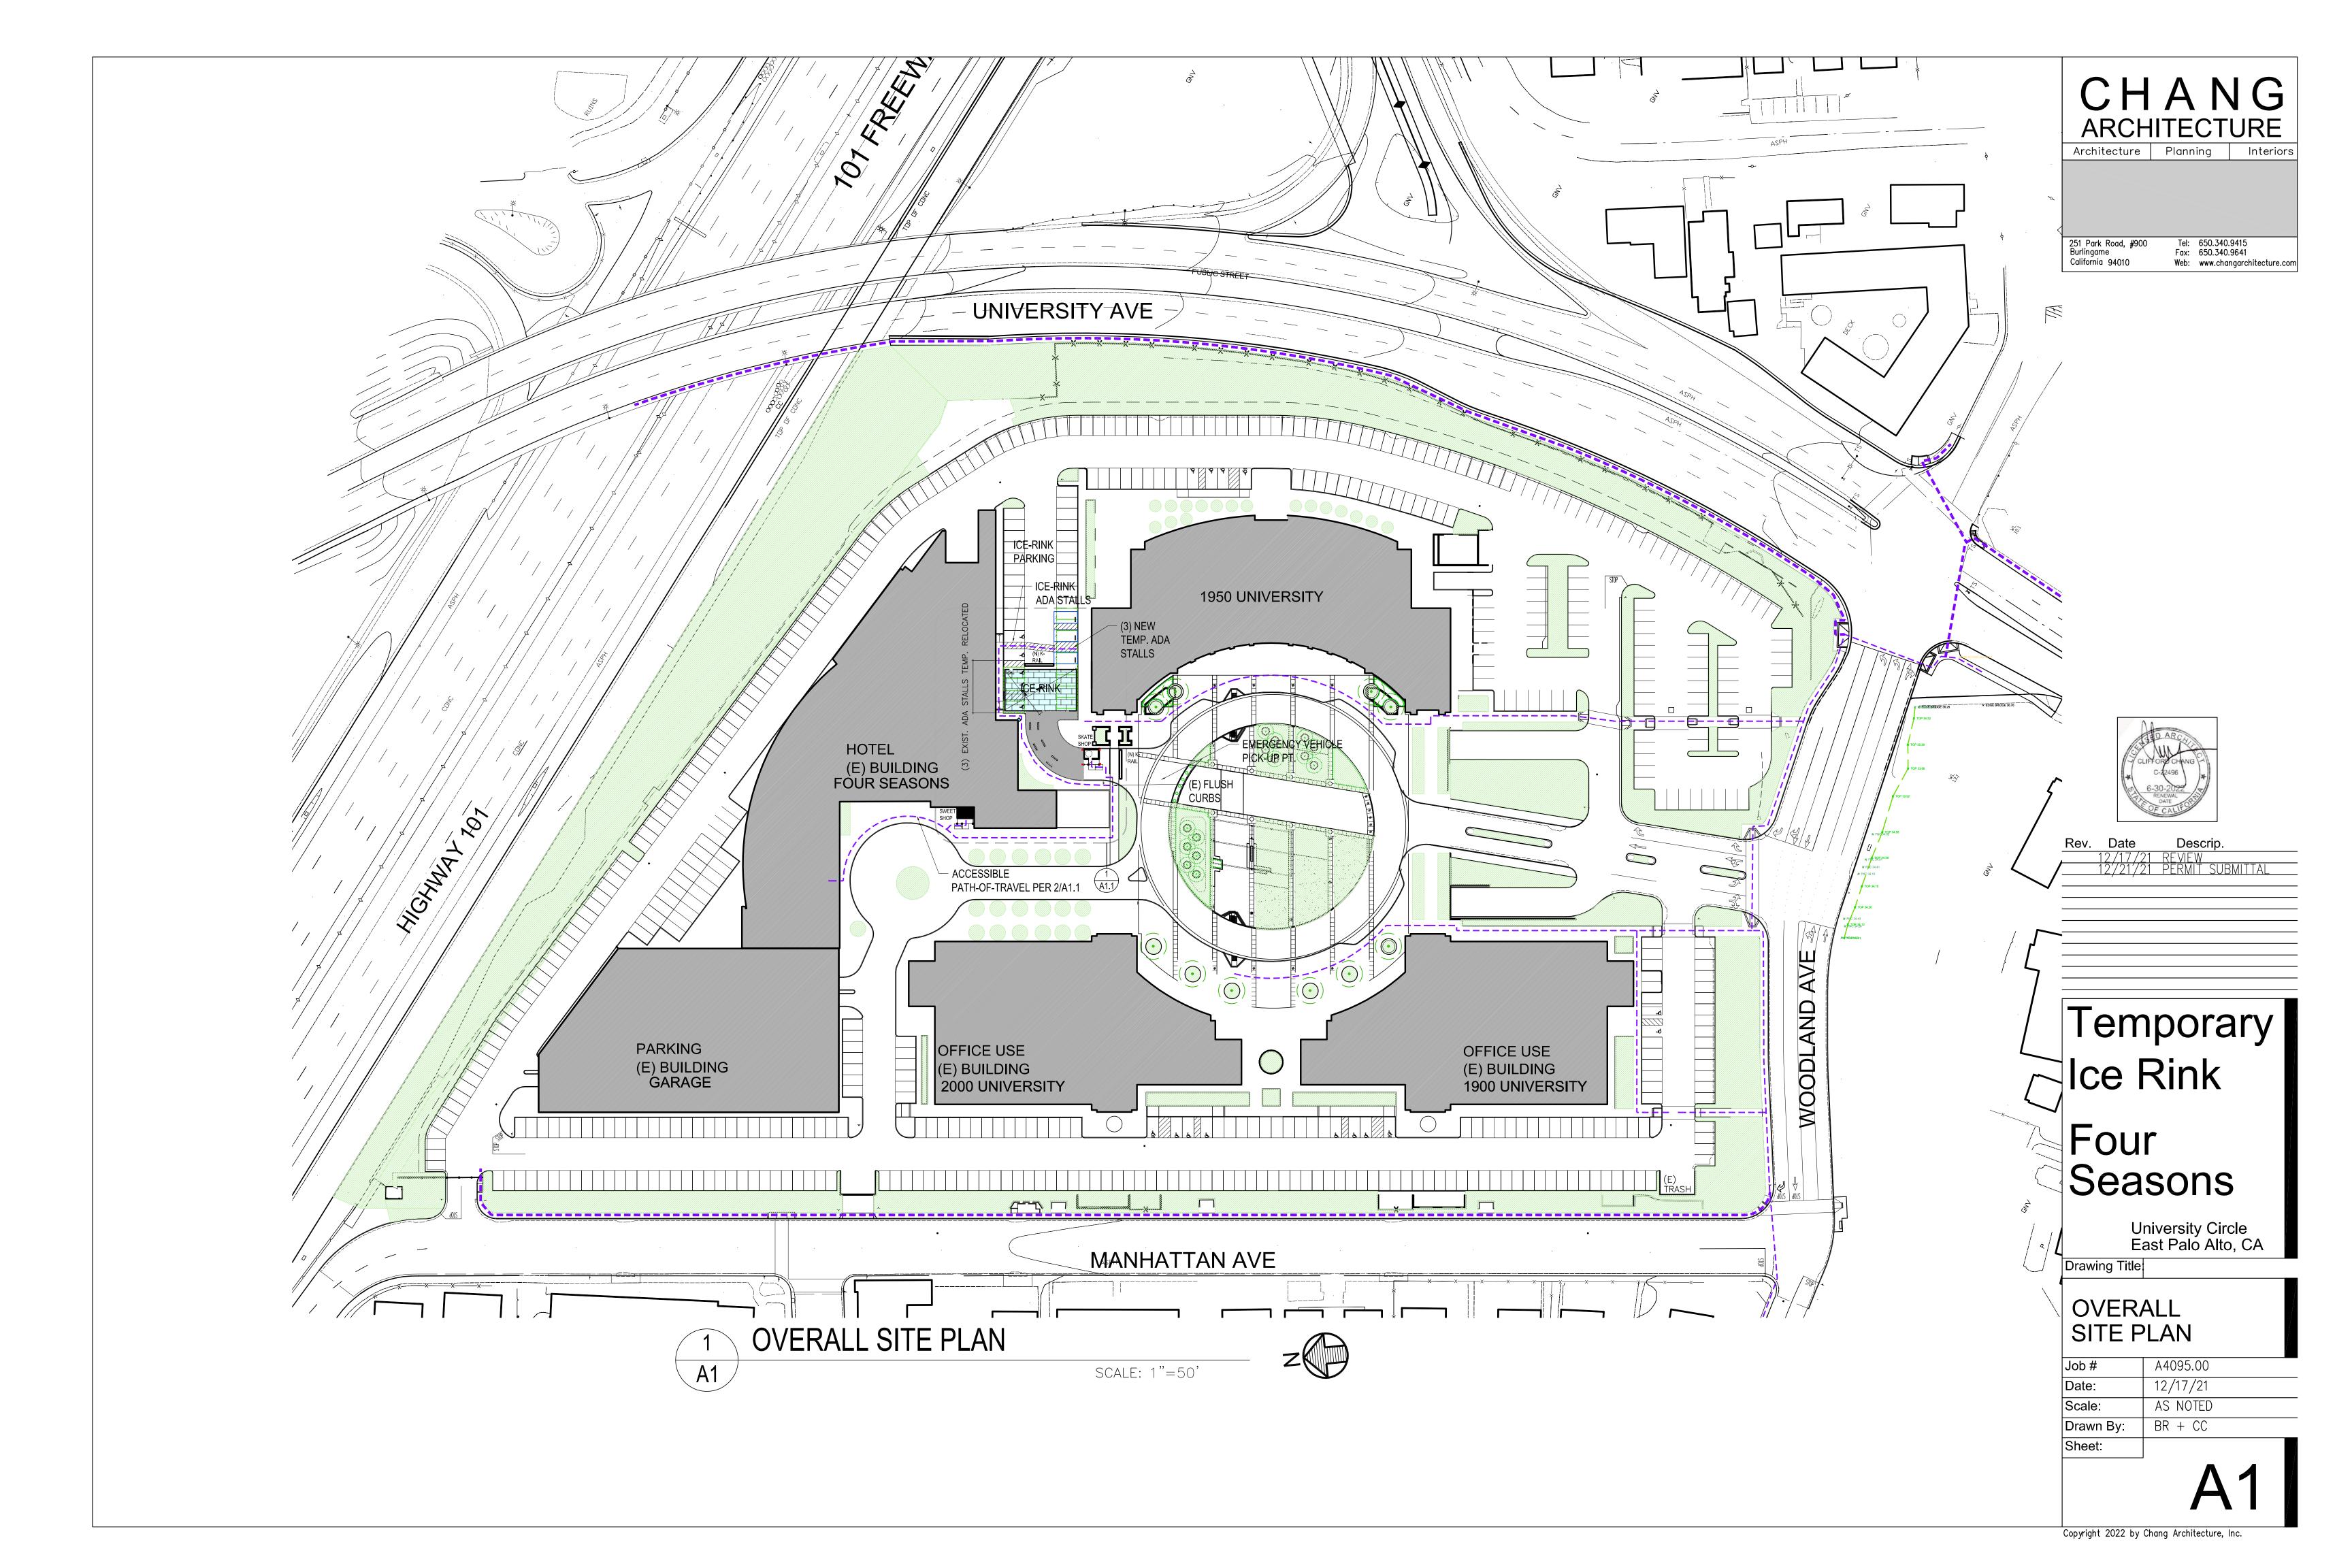


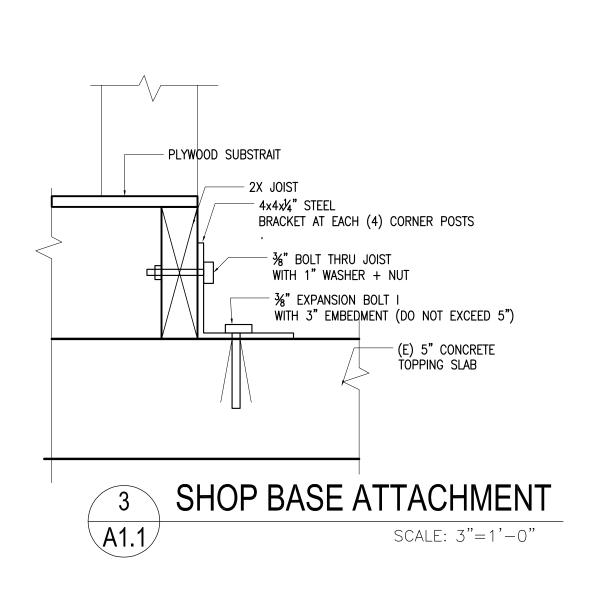

#### **ACCESSIBILITY NOTES:**

EXISTING WALKWAYS AND SIDEWALKS ALONG ACCESSIBLE ROUTES OF TRAVEL:

- A. ARE CONTINUOUSLY ACCESSIBLE
- B. HAVE MAXIMUM  $\frac{1}{4}$ " VERTICAL CHANGES IN ELEVATION, OR ½" BEVELED CHANGES PER CBC 11B-303. CHANGES
- GREATER THAN  $\frac{1}{2}$ " SHALL BE RAMPED PER 11B-405 OR 11B-406 C. ARE MINIMUM 48" IN WIDTH.
- D. WHERE NECESSARY TO CHANGE ELEVATION AT A SLOPE EXCEEDING 5% (1:20) SHALL HAVE PEDESTRIAN RAMPS COMPLYING WITH CBC 11B-405
- E. MAX. 1/2" THRESHOLD AT ALL ENTRIES

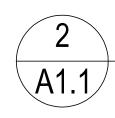



(E)ACCESSIBILITY NOTES


SCALE: 1/8"=1'-0"

SCALE: 1/8"=1'-0"



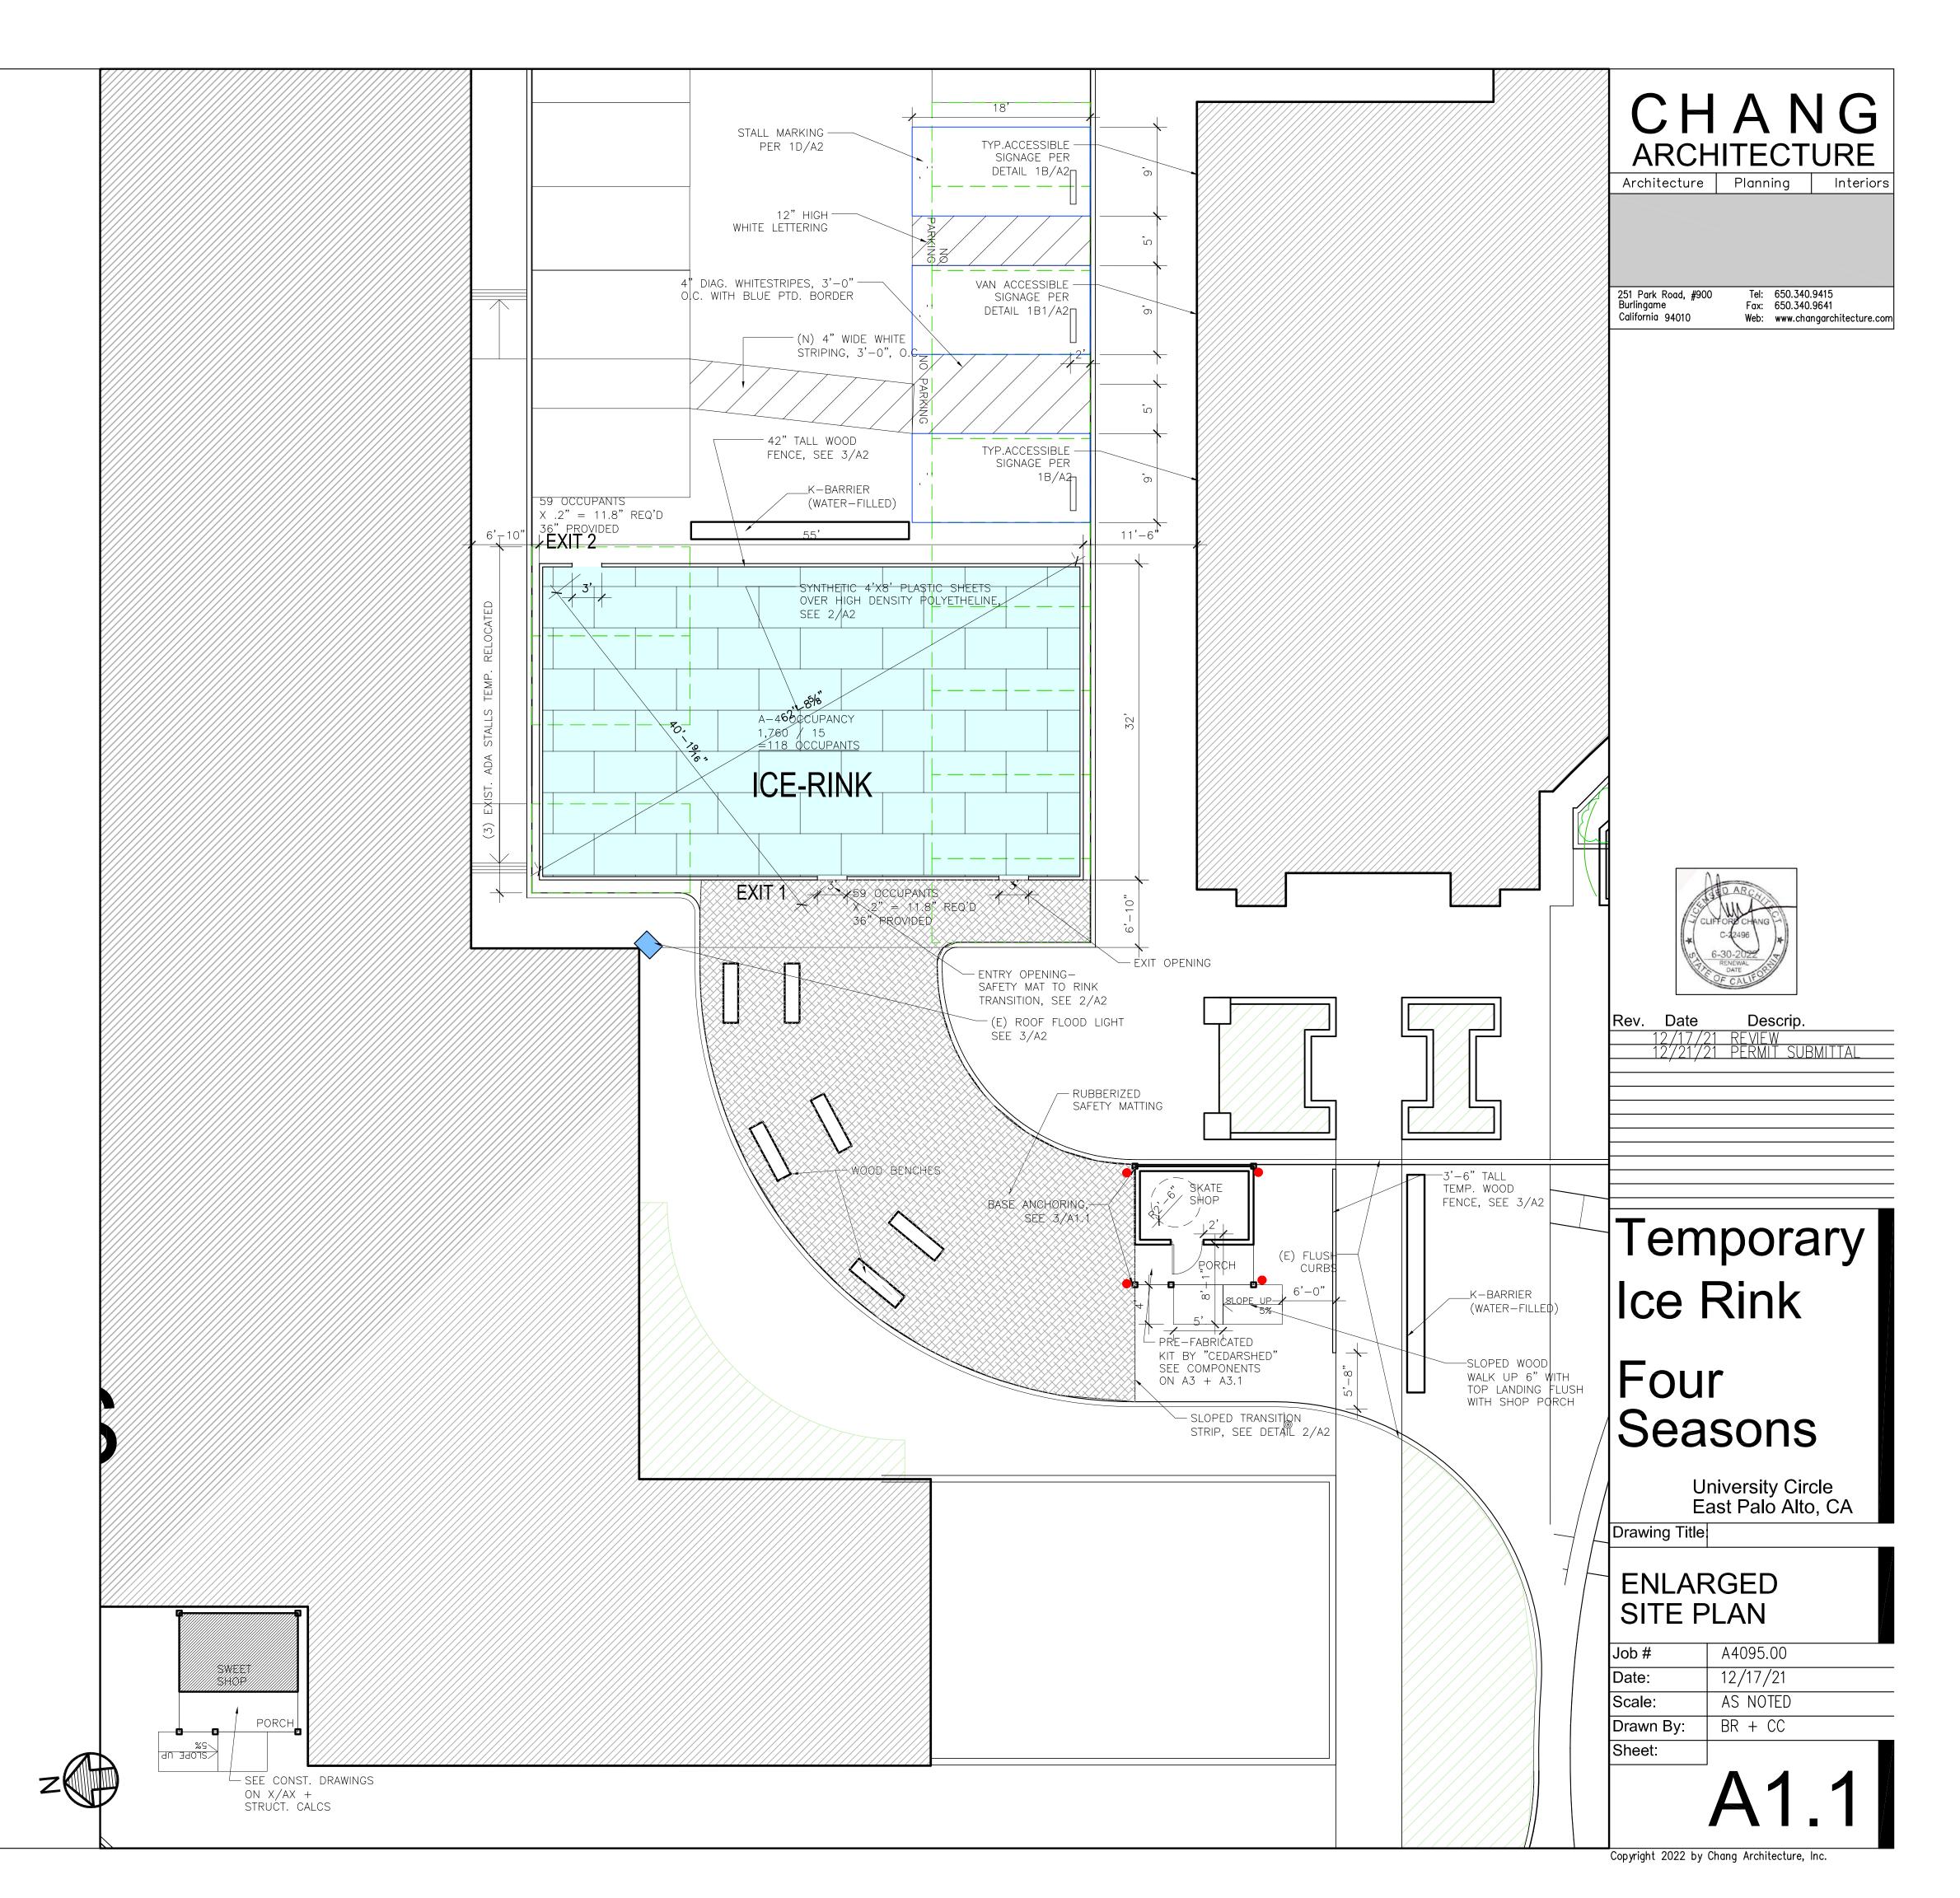

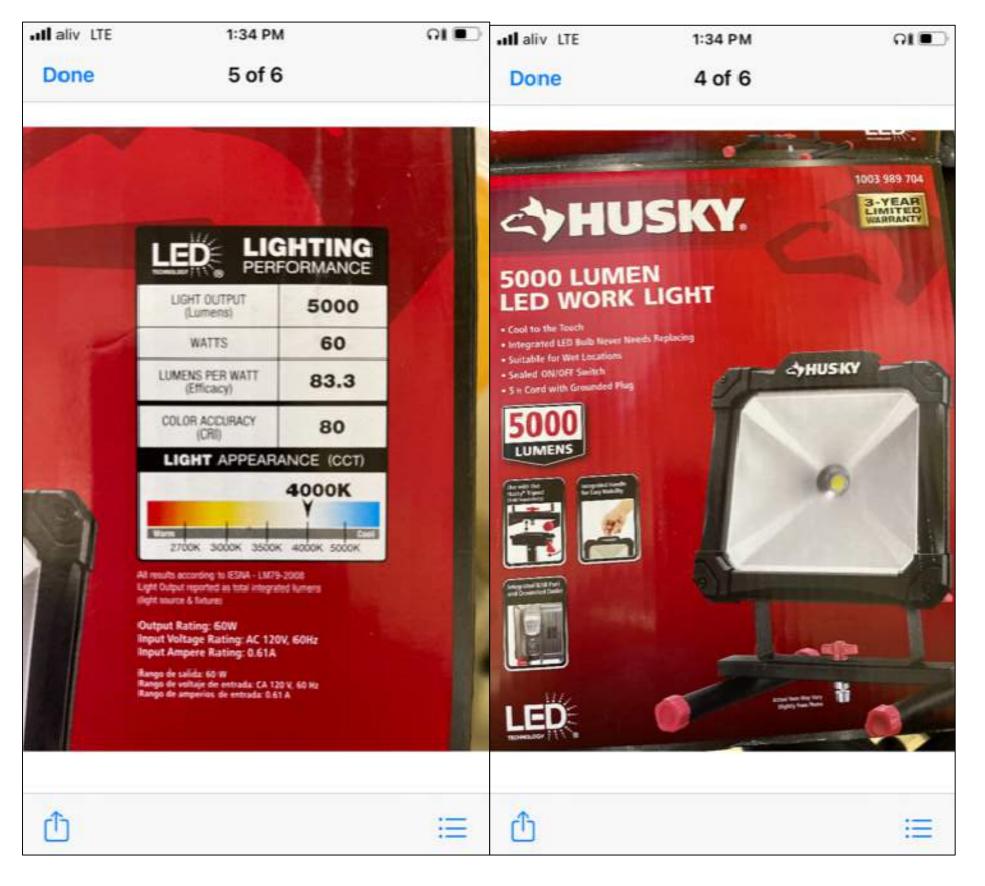

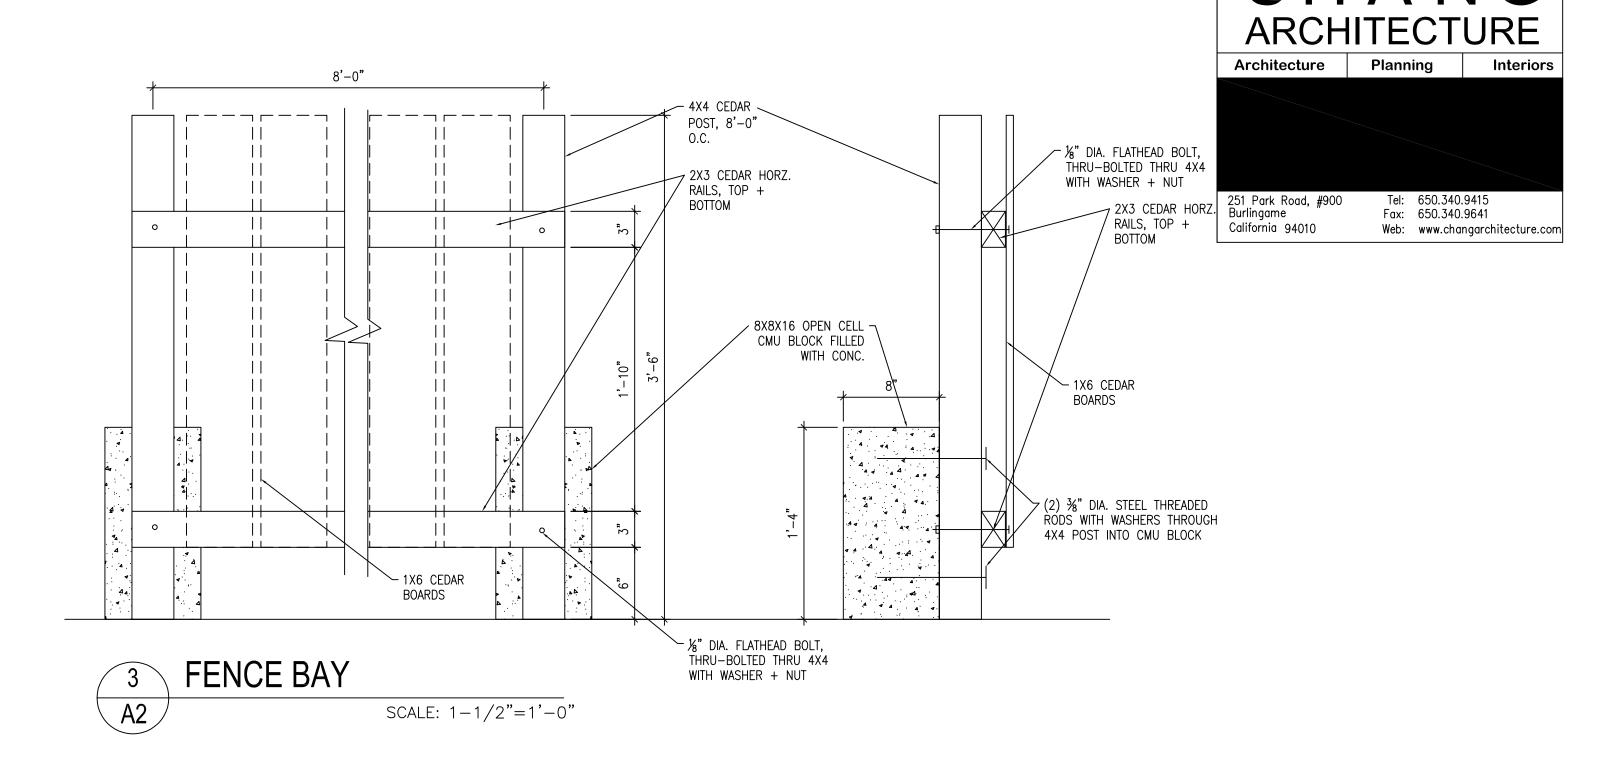

### EXISTING FLOOD LIGHT A2

A2

SCALE: 1/8"=1'-0"


BACKGROUND

— 16" DIA. X 2'-0"

DEEP CONC. FOOTING.

STOP PIPE 3" FROM

BOTTOM OF FOOTING

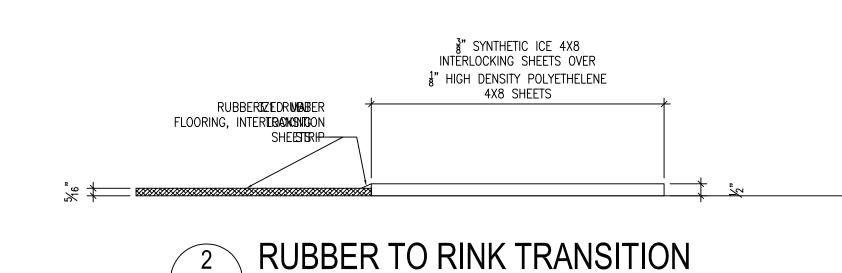

PARKING OF PARKING SPACE STALL - CENTERLINE OF SYMBOL WITHIN 6" OF CENTERLINE OF STALL BACKGROUND LOWER EDGE ALIGNED WITH BOTTOM EDGE OF STALL 3'-0" LOWER SIDE ALIGNED -WITH END OF STALL

- SIDES PARALLEL TO LNGTH

SCALE: 3/4"=1'-0"

SHALL HAVE A SIGN OF NOT LESS THAN 17" X 22" WITH LETTERING NOT LESS THAN 1" HIGH STATING THE FOLLOWING: "UNAUTHORIZED VEHICLES PARKED IN DESIGNATED ACCESSIBLE SPACES NOT DISPLAYING DISTINGUISHING PLACARDS OR SPECIAL LICENSE PLATES ISSUED FOR PERSONS WITH DISABILITIES WILL BE TOWED AWAY AT OWNER'S EXPENSE TOWED VEHICLES MAY BE RECLAIMED AT SPECIALTY TOWING, (650)365-1011 LOCATED AT 264 TARA STREET, EAST PALO ALTO 94303 POLE MTD. 80"
ABOVE GRADE PARKING ENTRY SIGNAGE

EACH ENTRANCE TO OFF-STREET PARKING

PLACE SIGN AT EACH END OF PARKING STRING AS IDENTIFIED ON SITE PLAN "THESE SPACES ARE RESERVED FOR VAN OR LOW-EMISSIONS VEHICLES BETWEEN THE HOURS OF 8AM-10AM." POLE MTD. 80" ABOVE GRADE VAN + LOW EMISSIONS VEHICLÉ SIGNAGE

SCALE: N.T.S.

- 8-8" X 8-8" REFLECTORIZED SIGN TO BE BEADED (OR EQUAL). DARK BLUE WITH WHITE STRIPING DIRECTIONAL ARROW STATE "MIN. \$250 FINE" -- 2 $-\frac{1}{2}$ " GALV. PIPE

 $-8-\frac{3}{8}$ " X  $8-\frac{3}{8}$ " REFLECTORIZED SIGN TO BE BEADED (OR EQUAL). DARK BLUE BACKGROUND WITH WHITE STRIPING "ELECTRIC VEHICLE" AT ELECTRIC VEHICLE PARKING - POLE MOUNTED OR WALL MOUNTED STATE "MIN. \$250 FINE"  $-2-\frac{1}{2}$  GALV. PIPE - 16" DIA. X 2'-0" DEEP CONC. FOOTING.

STOP PIPE 3" FROM

BOTTOM OF FOOTING


SCALE: 3/8"=1'-0"

SURFACE IDENTIFICATION

- 8-3" X 8-3" REFLECTORIZED SIGN TO BE BEADED POLE MOUNTED -OR WALL MOUNTED (OR EQUAL). DARK BLUE BACKGROUND WITH WHITE STRIPING STATE "RESERVED PARKING" STATE "VAN ACCESSIBLE MINIMUM FINE \$250"  $2-\frac{1}{2}$ " GALV. PIPE 16" DIA. X 2'-0" DEEP CONC. FOOTING. STOP PIPE 3" FROM

BOTTOM OF FOOTING

SCALE: N.T.S.

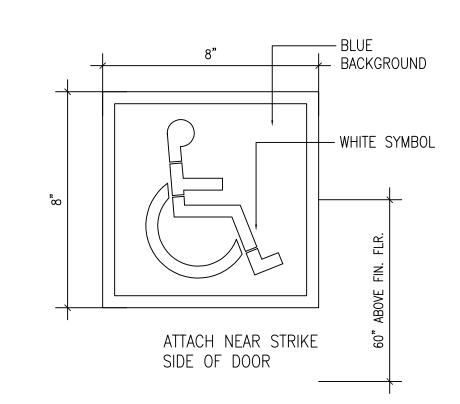

SCALE: 3"=1'-0"

SCALE: 3/8"=1'-0"

B STALL SIGNAGE

SCALE: 3/8"=1'-0"

ACCESSIBILITY SIGNAGE A2 SCALE: 3/4"=1'-0" INTERNATIONAL ACCESSIBILITY SYMBOL SCALE: NTS



Rev. Date Descrip 12/17/21 REVIEW 12/21/21 PERMIT SUBMITTA

## Temporary Ice Rink

## Four Seasons


**University Circle** East Palo Alto, CA

Drawing Title


### **DETAILS**

Job #	A4095.00
Date:	12/17/21
Scale:	AS NOTED
Drawn By:	BR + CC
Sheet:	


Copyright 2022 by Chang Architecture, Inc.

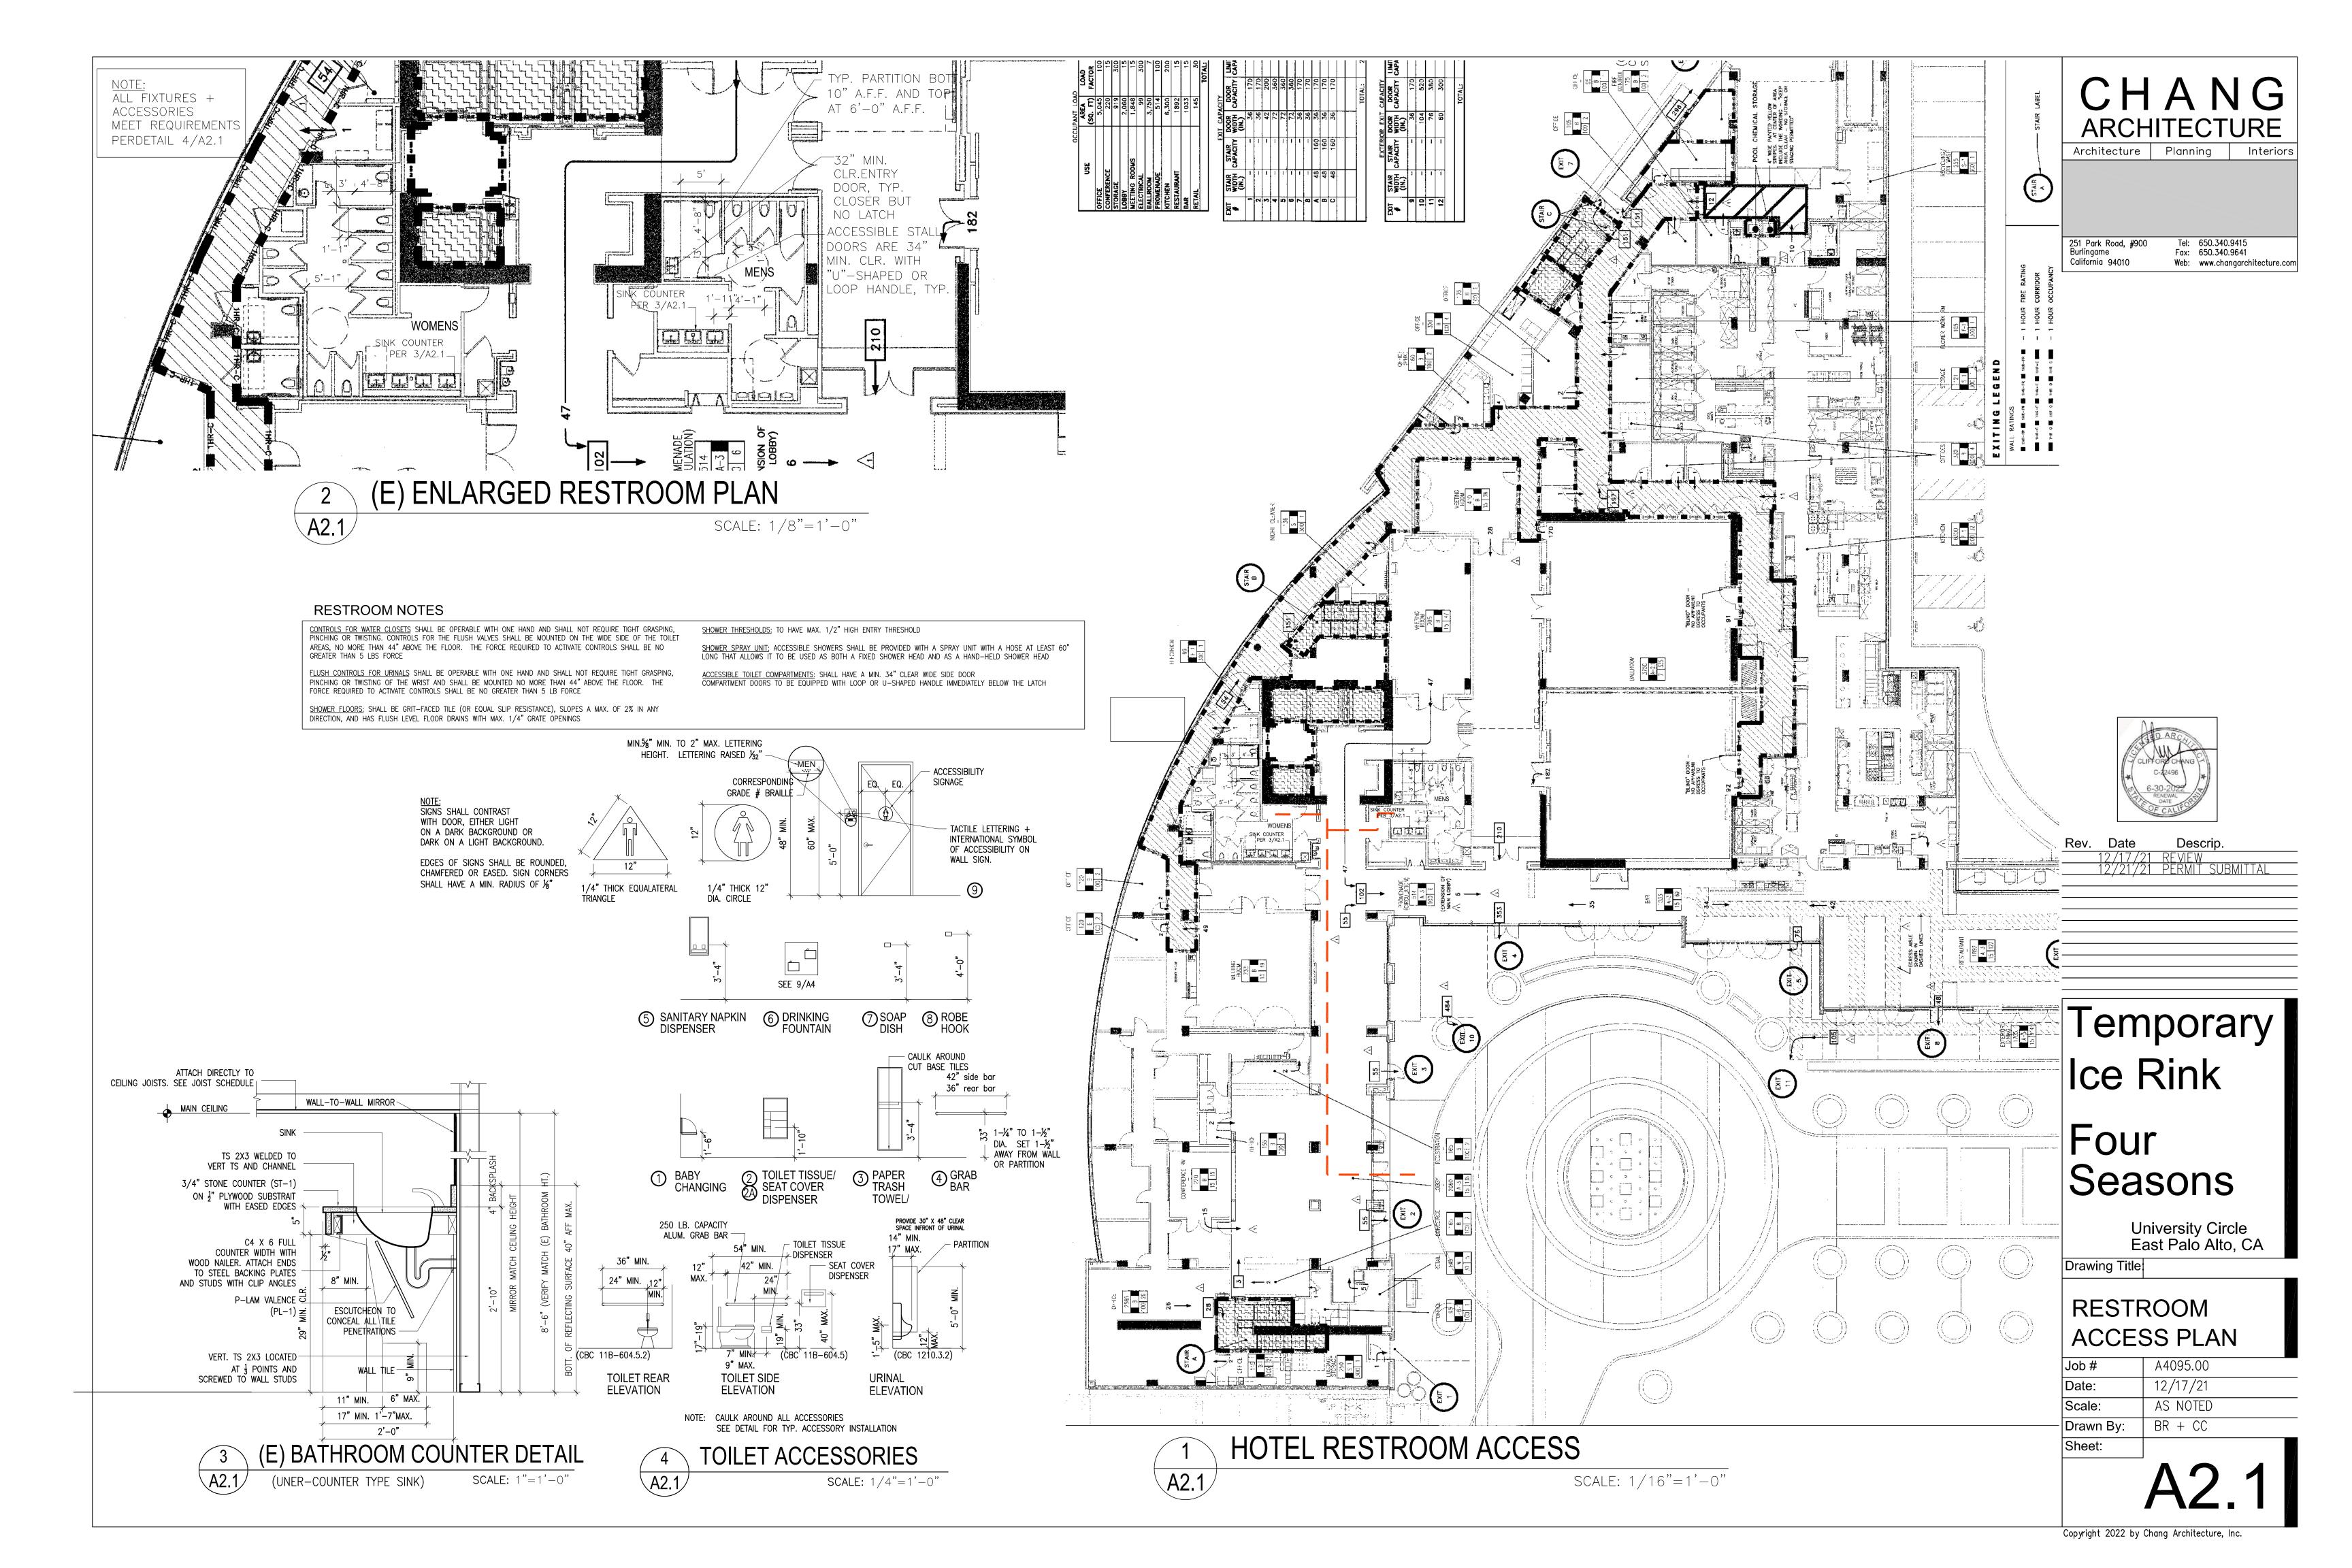

## BUNKHOUSE 12 x 12 12 Ft x 12 Ft MODEL BK1212

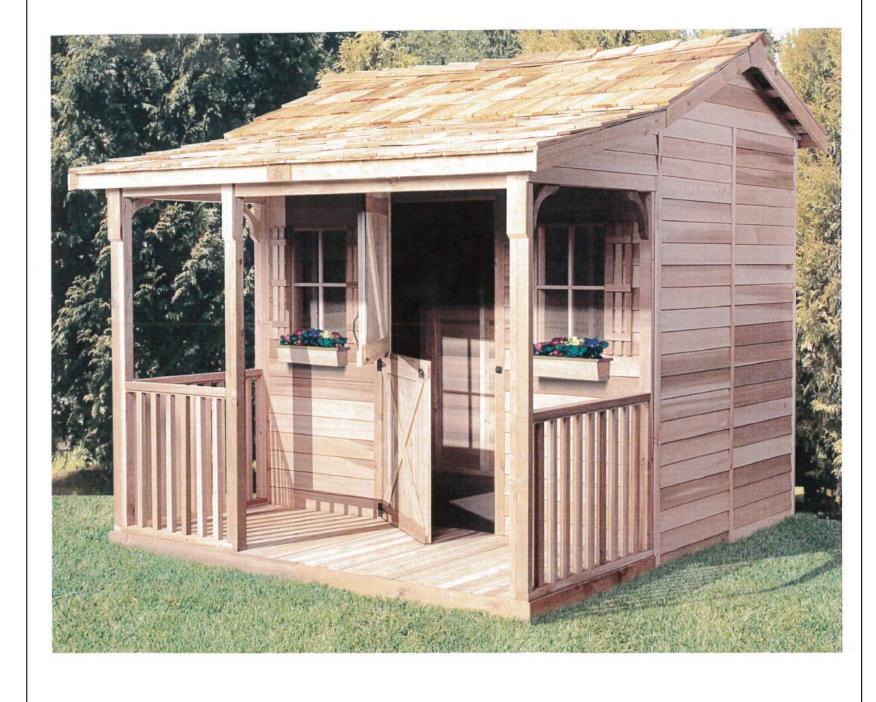

#### BEARING POINTS FOR 1212 AND BUILDING THE FLOOR JOIST BOXES

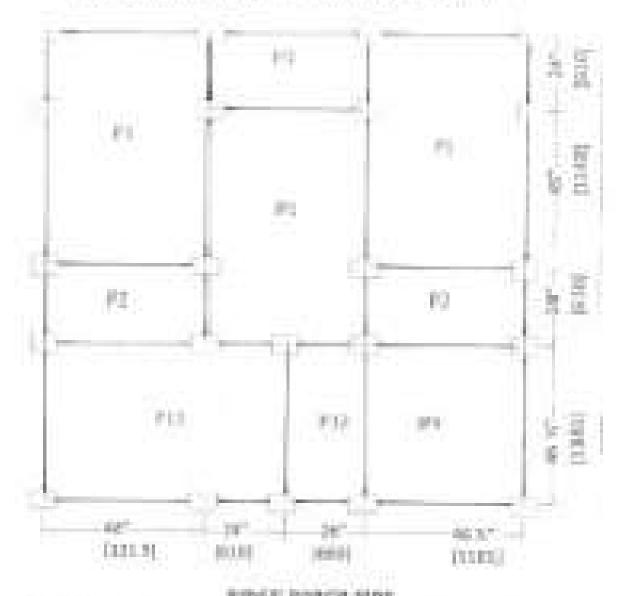

Tight intering police represents a spot subset the jets' force reserved north other. Thing a research line kan each of those position beautiful jobs assume that is not jobs. bineral new busin official regarder. You the disgress absences planting training points. or principaliting are. These rice that does not the interest auction of healthy.

protein and you was with the one additional commet trivels no used would justify.

#### FLOOR JOIST PARTS

1212

PIKRT #	DESCRIPTION FLOOR PARTS	CONTRACTOR DESIGNATION OF THE PERSON OF THE	
P-2103	The second second second second	£ 4 1 1 2 E	
F-3454	John .	2.34334	
F-04430	3090	24-45-4210	4
P-3645	1167	2.44444	23
P:24HG	100	11414111	
P-3409	1045	E-9-6 (199)	- 90
F-CHRHID	grant time beared	17 4 6 16 4 65 10	


#### BUILDING OF JOIST BOXES

By satisfy the joint poem as statistical about and the matria essential in the right few pages. promptile the point boxes semantingly. There are tolerate at point boxes that make an the joint straction. The resolver of such share profited in the retre-

2015 T. BOXES REQUIRED FOR THOS WOOD.					
\$1 827 (M) #1	Julied Stean Gillion	f of Bues fings			
Pil	25, 145,				
77	#0.127.x (6.37)				
BH	45.52 + 72				

## CHANG ARCHITECTURE Architecture Planning Interiors Tel: 650.340.9415 Fax: 650.340.9641 Web: www.changarchitecture.com

SHOP MANUFACTURER: CEDARSHED www.cedarshed.com 1-800-830-8033

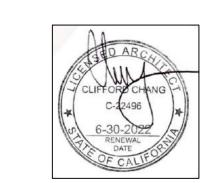

Rev.	Date	Descrip.
	12/17/21	REVIEW
	12/21/21	PERMIT SUBMITTAL

## Temporary Ice Rink

## Four Seasons

University Circle East Palo Alto, CA

Drawing Title:

#### PREMANUFACTURED SHOP

Job #	ŧ	A4095.00	
Date:		12/17/21	
Scale	<b>)</b> :	AS NOTED	
Draw	n By:	BR + CC	
Ola a a	1.		

Lety the joint parts out as the Fig.P1  $\sim$  1. Lates  $3-3^\circ$  remains not joint, assemble to a just be algorithm on part Fig.P1  $-3^\circ$ . The remaind and Source plotted in Fig.P1  $-3^\circ$ . Rithma S. C. T. sangers and strain in both sines. PERMIC 10000 SPACING Cortgowed floor perm

WWW.CDDARSHID.COM - and wiselforchaded com | TELS TRUE CARLESTEES

Photosci SETTARISE


60" a still" and others: Fit

JOIST BOX ASSEMBLY

10.1342月

100" a 10" floor yad at baylast.


1212

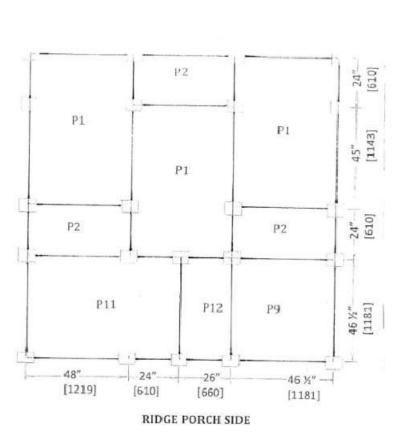

#### COMPLETING THE FLOOR JOIST STRUCTURE


Take the joist boxes and affix them as per the diagram above. Use 3" screws every 12" to affix all the joist boxes together. Once complete, lay the joist structure on top of the building site and level the joist structure on top of the cement blocks. Please use the cedar packaging blocks to assist in the levelling process. Make sure when level the joist structure clears the ground. This will allow the proper air circulation to prevent dry rot occurring on the joist structure.

There may be a need to affix joist trims on your specific model. If it is required the diagram below will show installation details.

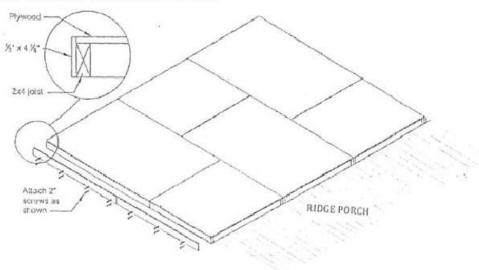

#### INSTALLATION OF PLYWOOD FLOORING & ADDITIONAL JOIST FOR GABLE PORCH SECTIONS

Now lay the plywood sheets over top of the joist frame. Each sheet of plywood (based on size) will lay over top of the various floor boxes that have been built and attached together. Then by using the 2" screws provided, affix each sheet using a screw every 12" on centre on each of the joist members (rows). As an example, to affix a 69" by 48" sheet to the joist frame would require 30 screws (6 joist members by 5 screws per row. See Fig 3 for

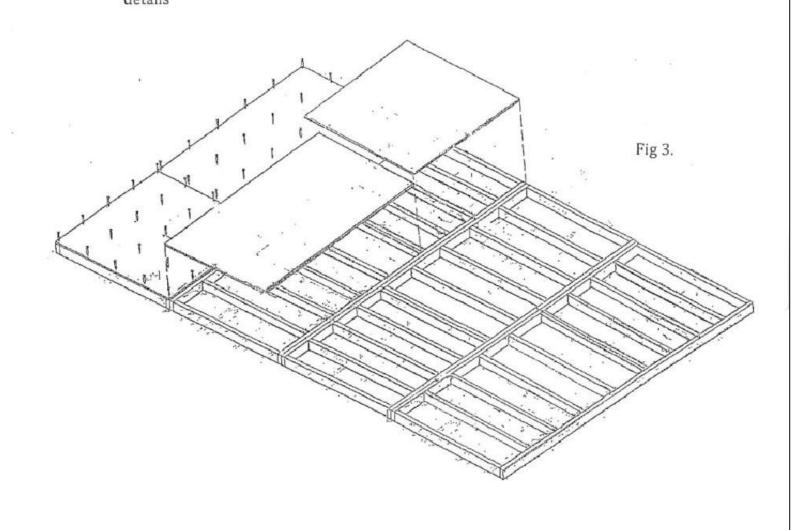



Copyright 2022 by Chang Architecture, Inc.


Lay the 46 ½" long deck boards over top of the level floor joist structure. Use 2-2" screws to attach the ends of each board and 1-2"screw to affix to the interior joist. The number of deck boards will vary based on the width of each board.


Size of deck No	of boards in 2 ½" width	No. of boards in 3 ½" width
9x4	44	31
12x4 (6)	57	41
12x4 (8)	57	41
16x4	76	54


67

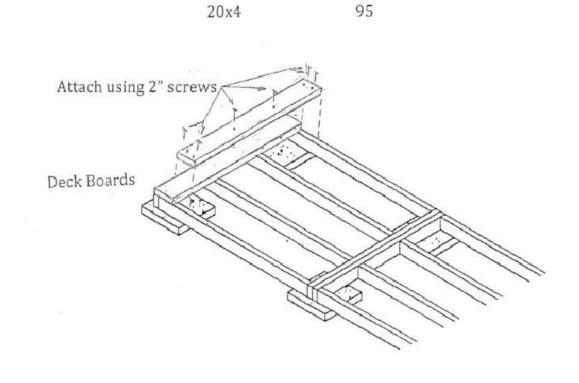

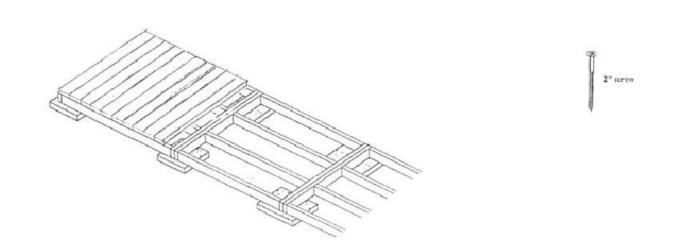

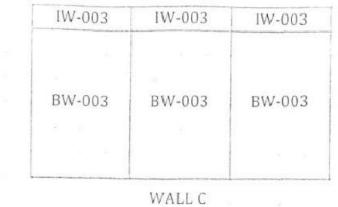

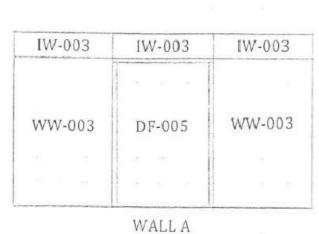

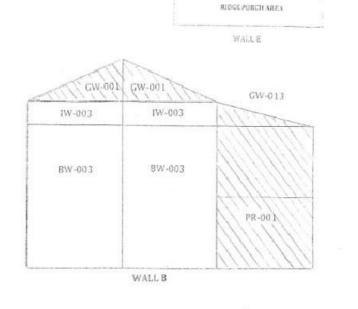

INTERIOR AREA

WALLX

BK1212

NOTE: SHADED AREAS WILL BE INSTALLED IN STEP 2 - WALL INSTALLATIONS.


	IW-003	IW-003
PR-001	BW-003	BW-003

WALL	<b>INSTALLATION - STAGE</b>	
		_


***************************************	TIMEE THO IMPERITION				
PART#	DESCRIPTION	DIMENSIONS (where app.)	# OF PCS	CODE	
P-2346G	header	2 x 3 x 46 1/2	7	not shown	
C-BW-003	wall panel	46 1/2" wall panel	7	BW-003	
C-IW-003	in-fill wall	46 1/2" in-fill wall	10	IW-003	
C-DF-005	door frame	single door frame	1	DF-005	
C-WW-003	window wall	46 1/2" window wall	2	WW-003	




PREIL	DESCRIPTION	THREE MEST WE CARRED AND	LLEUF ECH
	ACCESSORES.		
HFL308.1	SIGNES CO MARKE	Septem CD House	
HIPLASH.	and assort	2008 2450A	1 2
P-PW-801	ACTION BY	WYSIGN SIGN	4.0
Charles .	6542000	andm.	1 . 1
	resting Ret	1,914.8	Say 6
HI-RECARGE	Fright Chart	- M	
H-MPCASS T	not four eng.	11.0	17
PATRICINE	read server	17 4 4 4 71	100
F-29(1)	perill belokets.	14145	
	PARTENERS		
E-1/45 1 TE	TARTENERS AND	1.17.87 (48.9)	79
	1986	134 nen	- 8
EXIST	24/6	£.199.	1 10
	7' sirriws	7 Geres	425
PARSOL	2 8000	3 50944	150
	DOON AND HARDING AT		
G-09-901 1	DOCT-500	15,453,300	
CHAMME	Distant	1. Timps	1
FIRST A	tiers to E	A" Gebitst Dot	
	Byer Spendia	Book harafia	
PHHMP	0400	7160	
radical lines returned	C. money trapped and decision		

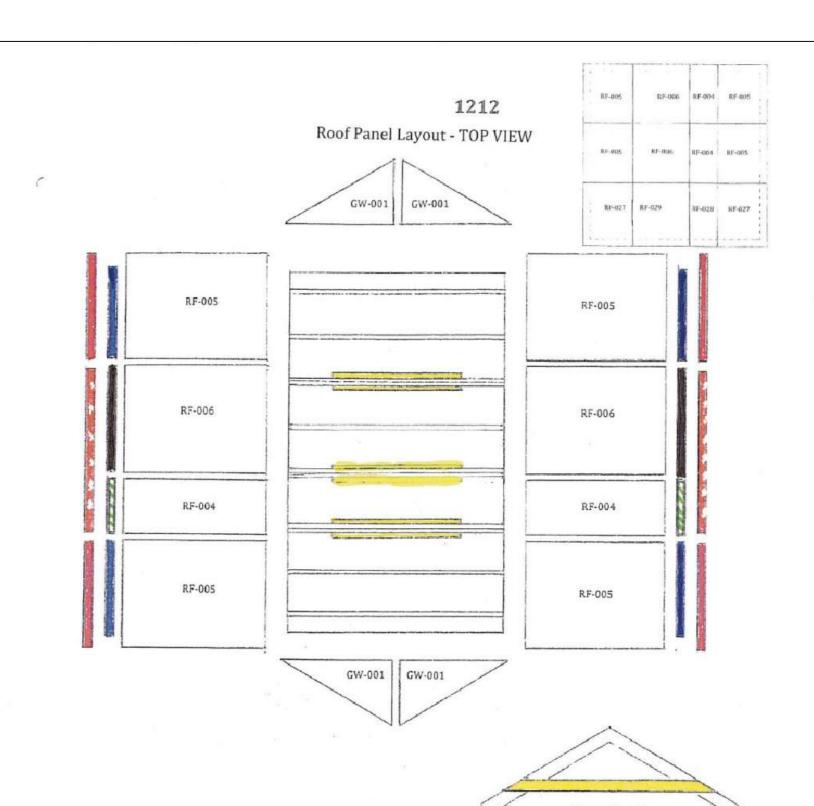

PART#	DESCRIPTION	DIMENSIONS (where app.)	# OF PCS	CODE
P-2371KYb	gusset	2 x 3 x 71 3/4	6	
C-GW-001	gable wall	21 1/4 x 54 7/8	4	GW-001
C-RF-005	roof panel	42 3/4 x 54 7/8	4	RF-005
C-RF-006	roof panel	46 1/2 x 54 7/8	2	RF-006
C-RF-004	roof panel	24 x 54 7/8	2	RF004
P-B-G424	soffits	1/2 x 4 x 24	2	2/2/////
P-B-G437	soffits	1/2 x 4 x 37	4	
P-B-G446G	soffits	1/2 x 4 x 46 1/2	2	
P-1442	fascia	1 x 4 x 42	4	
P-1470G	fascia	1 x 4 x 70 1/2	2	1 11 1
P-H-RCAP24	ridge caps	24"	18	not shown

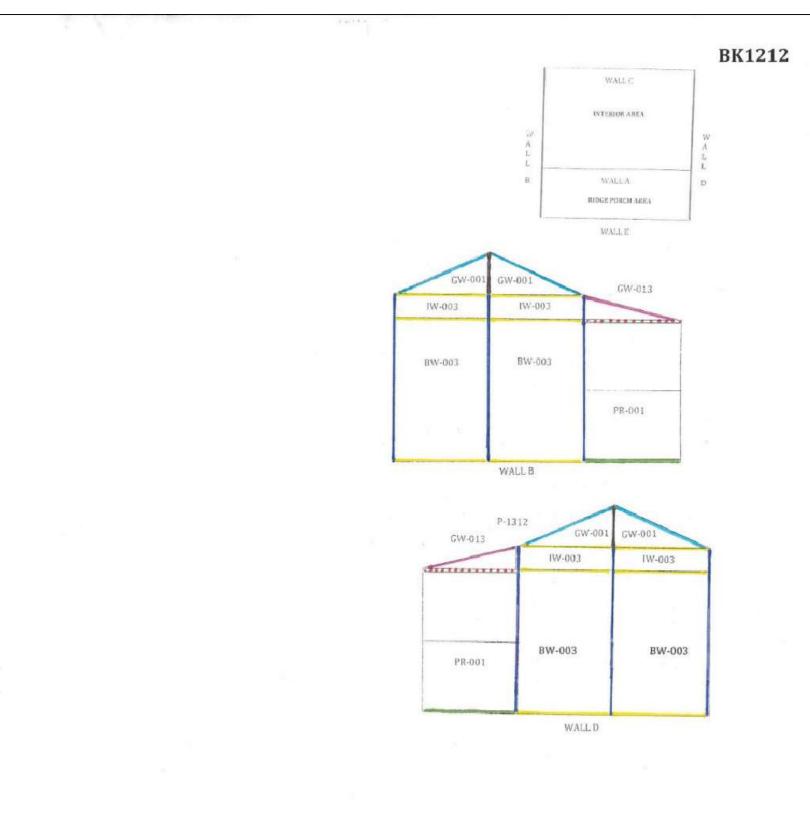

TRIM INSTALLATION - STAGE 3				
PART #	DESCRIPTION	DIMENSIONS (where app.)	# OF PCS	CODE
P-1221C	gable trim	1 x 2 x 21 1/4	2	
P-1292C	trim	1 x 2 x 92 1/4	6	
P-B-G645	skirting	1/2 x 6 x 45	12	
P-B-G646G	skirting	1/2 × 6 × 46 1/2	2	
P-14B45K	bottom skirting	1 x 4 1/8 x 45 3/4	2	
P-1448GYg	fascia	1 x 4 x 48 1/2	2	
P-1458GYa	gable fascia	1 x 4 x 58 1/2	4	38045403

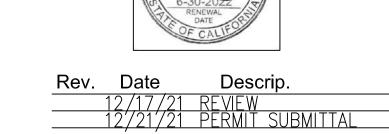

ARCHITECTURE

Architecture Planning Interiors

251 Park Road, #900 Burlingame Tel: 650.340.9415 Fax: 650.340.9641 Web: www.changarchitecture.com

## Temporary Ice Rink

## Four Seasons

University Circle East Palo Alto, CA

Drawing Title

## PREMANUFACTURED SHOP

	Job #	A4095.00
	Date:	12/17/21
	Scale:	AS NOTED
	Drawn By:	BR + CC
	Sheet:	

A3.1

Copyright 2022 by Chang Architecture, Inc.