WOODLAND PARK - EUCLID IMPROVEMENTS

VICINITY MAP



PROJECT DIRECTORY

APPLICANT:

Woodland Park Communities
5 Newell Court
East Palo Alto, CA 94303
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ARCHITECT:

David Baker Architects
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LANDSCAPE ARCHITECT:

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CIVIL ENGINEER:

BKF Engineers 1730 N. First Street. Suite 600 San Jose, CA 95112 ATTN: Jacob Nguyen jnguyen@bkf.com

PROJECT DESCRIPTION

With <u>no displacement</u>, this project proposes the replacement of several aging, outdated structures containing 160 rent-stabilized housing units and one single family rental (non-RSO) with new mixed-income buildings containing 551 apartments, 29% of which will be deed-restricted rent-controlled, replacing the existing apartments one-for-one.

Note: No portion of the property is located in a Flood Zone as designated by the Federal Emergency Managment Agency (FEMA).

PROJECT SITE

ZONING:

R-HD-5, R-UHD, Neighborhood Center Overlay (NCO)

GENERAL PLAN DESIGNATION:

HIGH DENSITY RESIDENTIAL / URBAN RESIDENTIAL, NEIGHBORHOOD CENTER OVERLAY

TOTAL SITE AREA:

170,941 SF = 3.92 ACRES

EXISTING LOTS:

APNS: 063282010 ADDRESSES: 501 O'Connor St. 2012 Euclid Ave. 2032 Euclid Ave. 2036 Euclid Ave. 2040 & 2042 Euclid Ave. 2044 Euclid Ave. 2054 Euclid Ave. 2033 Manhattan Ave. 063282090 2001 Manhattan Ave. 2021 Euclid Ave. 2025 Euclid Ave. 063281030 2031 Euclid Ave. 063281040 2043 Euclid Ave. 2041 Euclid Ave./420 E O'Keefe St.

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ARCHITECTURE

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OPEN SPACE DIAGRAMS

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T-1.1 TREE PROTECTION & REMOVAL PLAN

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4.0 PRELIMINARY UTILITY PLAN
5.0 PRELIMINARY STORMWATER N

5.0 PRELIMINARY STORMWATER MANAGEMENT PLAN 5.1 PRELIMINARY STORMWTER MANAGEMENT PLAN 5.0 PRELIMINARY FIRE ACCESS PLAN

VESTING TENTATIVE PARCEL MAP - TITLE SHEET
VESTING TENTATIVE PARCEL MAP - MAPPING

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OTHER

WT-001 WATER TANK EXHIBIT

PROJECT DATA

GROSS AREAS

CIRCULATION	56065 SF
COMMON	28013 SF
COMMUNITY SPACE	2372 SF
GARAGE / BIKE ROOM	136777 SF
RESIDENTIAL	417205 SF
RETAIL	3371 SF
SERVICE / TRASH	8274 SF
STAIRS / ELEVATORS	31819 SF
	683896 SF

UNIT MIX

TYPE	EXISTING*	MIX	APPROVED	MIX	REVISED	MIX	AVG. AREA
STUDIO	53	33%	228	38%	20**	4%	495 sf
1 BR	102	64%	197	33%	339	61%	688 sf
2 BR	4	2%	178	29%	190	34%	977 sf
3 - 4 BR	2	<1%	2	<1%	2	<1%	1,298 sf
TOTAL	161		605		551		

^{*} There are 160 current rent-stabilized units and one 2 BR single-family rental (non-RSO)

PARKING

S	TALLS	EXISTING	APPROVED	REVISED
OFF	-STREET	155	625	570
ON-	STREET	52	52	72

(14 of the proposed parking stalls are ADA, including 4 ADA van spaces)

Approved Parking Ratio = 1.03 spaces/unit Revised Parking Ratio = 1.03 spaces/unit

LOT COVERAGE CALCULATIONS

TOTAL SITE AREA = 31,596 SF + 139,345 SF = 170,941 SF

TOTAL BUILDING FOOTPRINT AREA = 21,975 SF + 87,812 SF = 109,787

LOT COVERAGE = 109,787 / 170,941 SF = **64%**

F.A.R. REQUIRED: N/A

(PER DEVELOPMENT CODE SECTION 18.10 TABLE 2-2)

BIKE PARKING

TOTAL: 324 STALLS

CLASS II: 45 STALLS


OPEN SPACE				
	AREA			
COMMON OPEN SPACE	32,173 SF			
PRIVATE OPEN SPACE	18,161 SF			
PUBLIC OPEN SPACE	20,662 SF			
Total	70,996 SF			
Open space per unit (excluding the Public Park)	110 SF/UNIT			
PUBLIC PARK	9,355 SF			

BUILDING A (@ O'KEEFE ST.): 72 STALLS BUILDING B (@ EUCLID AVE.): 252 STALLS

ZONING COMPARISON

Development Standard	NCO Zone / GP Designation Requirement	Approved Project (Nov 2022)	Revised Project (Jan 2024)
Maximum Density	175 du/acre	155 du/acre	141 du/acre
Height	13 stories / 140 feet	13 stories / 135 feet	8 stories / 85 feet
Open Space	100 sf/unit	100 sf/unit	105 sf/unit or greater
Setbacks			
Front	5 feet	9-12 feet	5-12 feet
Side/Street Side	5 feet	10-85 feet	5-83 feet
Rear	10 feet	10-20 feet	10-23 feet
Corner vision triangle	12 feet	12 feet	12 feet

Woodland Park Euclid Improvements

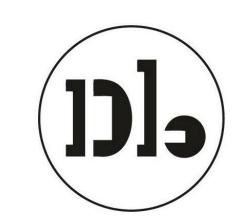

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Design Update - February 2024

Drawing Title

TITLE SHEET

Sheet No.

Date 02/09/2024 Project No. 21620

^{** 33} existing studios will be replace by 1 BR units



1 - Intersection of West Bayshore Road and Euclid Avenue, Looking East




2 - West Bayshore Road, Looking East




3 - Intersection of West Bayshore Road and Manhattan Avenue, Looking South




4 - Intersection of Manhattan Avenue and O'Connor Street, Looking North

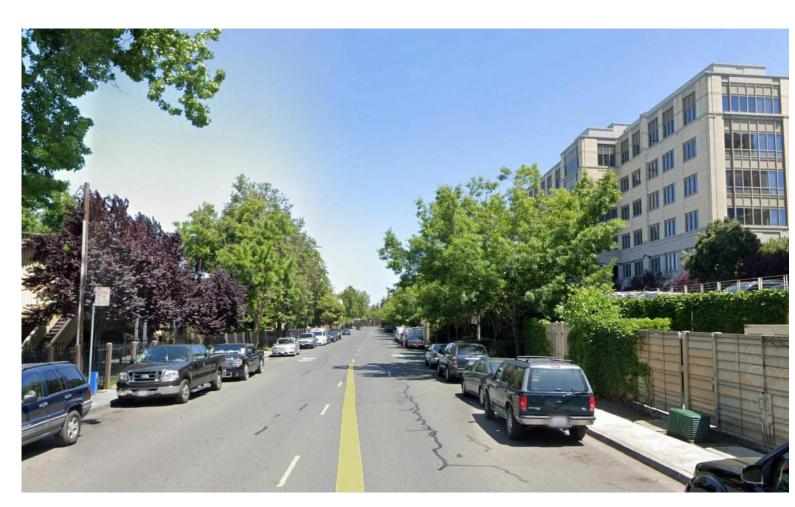


5 - Manhattan Avenue, Looking North

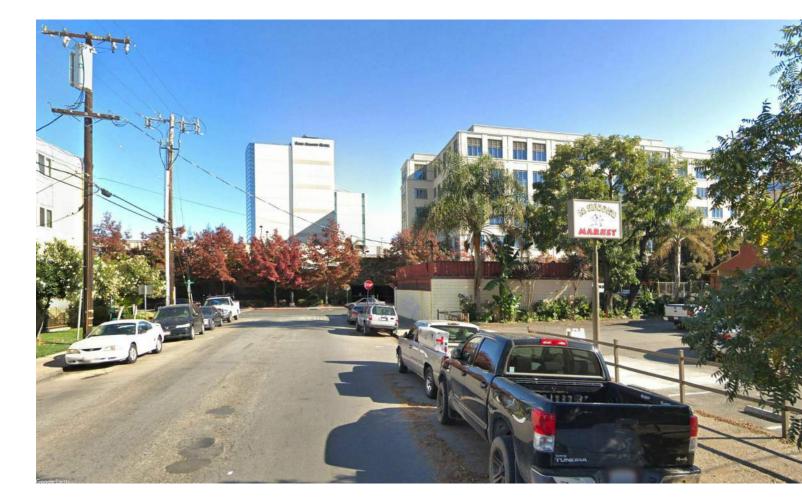


6 - O'Connor Street, Looking East

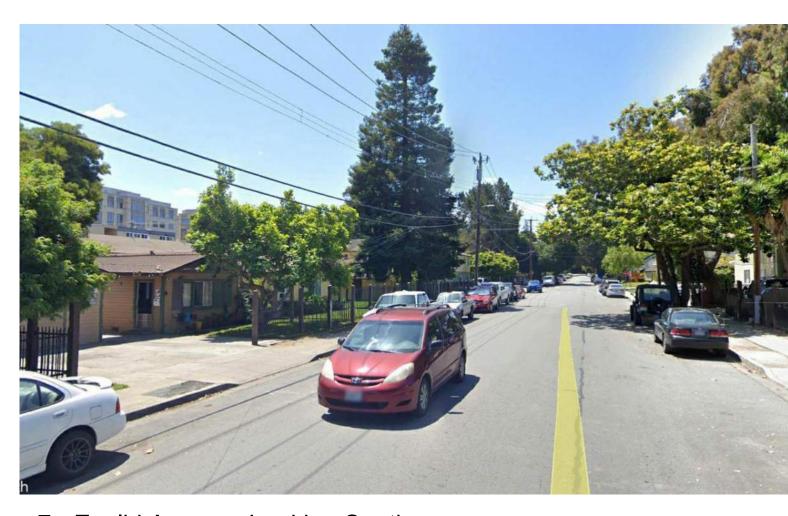

7 - Euclid Avenue, Looking South

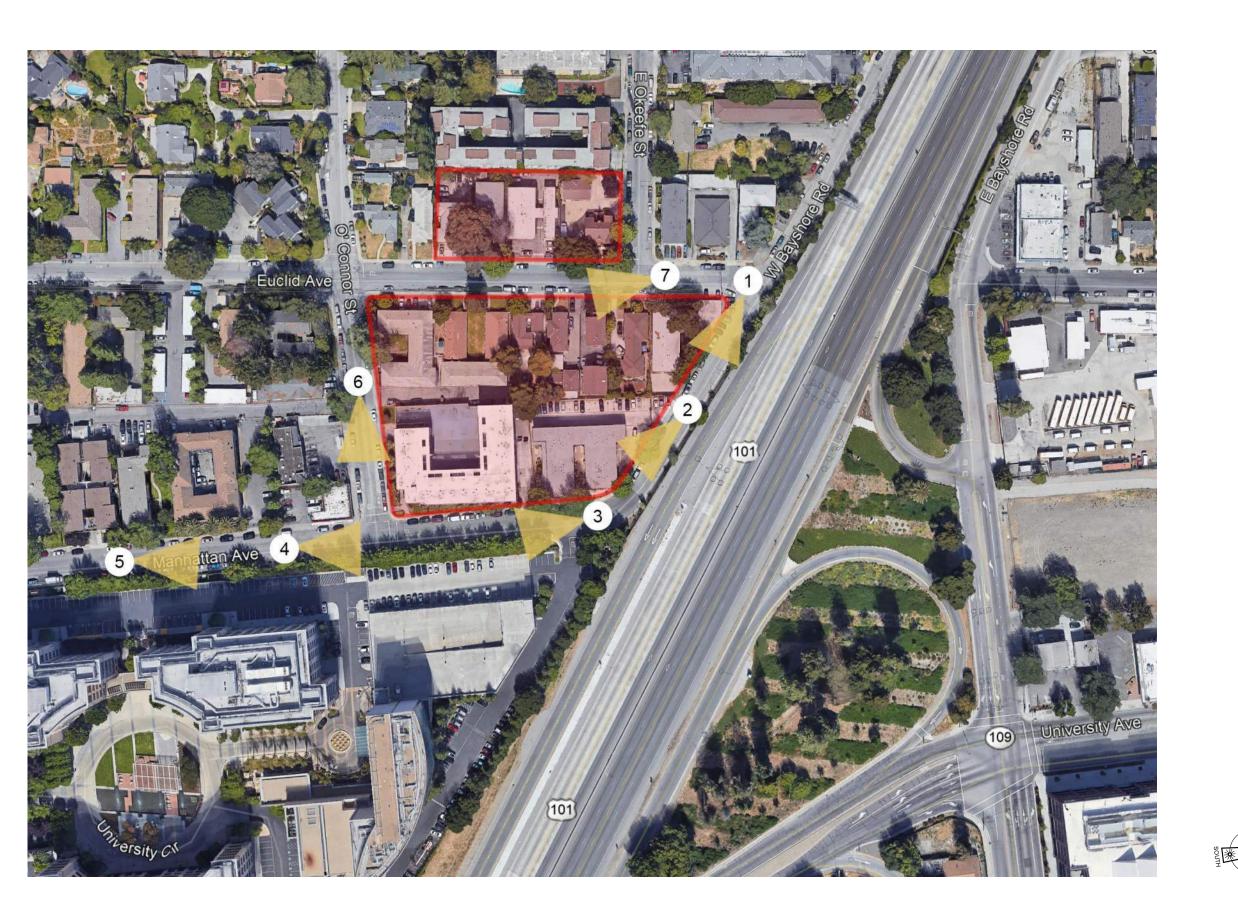

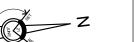



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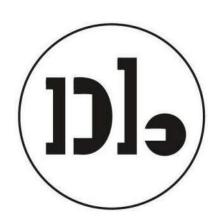
CONTEXT

Sheet No.

 Date
 08-23-2022

 Project No.
 21620





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SITE PLAN -EXISTING

Sheet No.


 Date
 08-23-2022

 Project No.
 21620

1- VIEW OF PARK FROM O'CONNOR ST.



2- VIEW OF EUCLID LOOKING TOWARDS O'KEEFE ST.

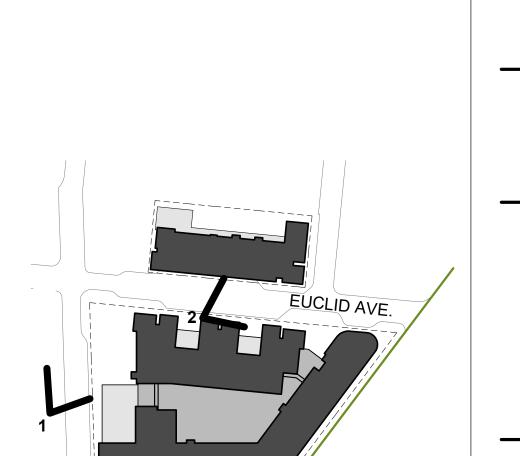

MANHATTAN AVE.

KEY PLAN

Euclid Improvements

Woodland Park



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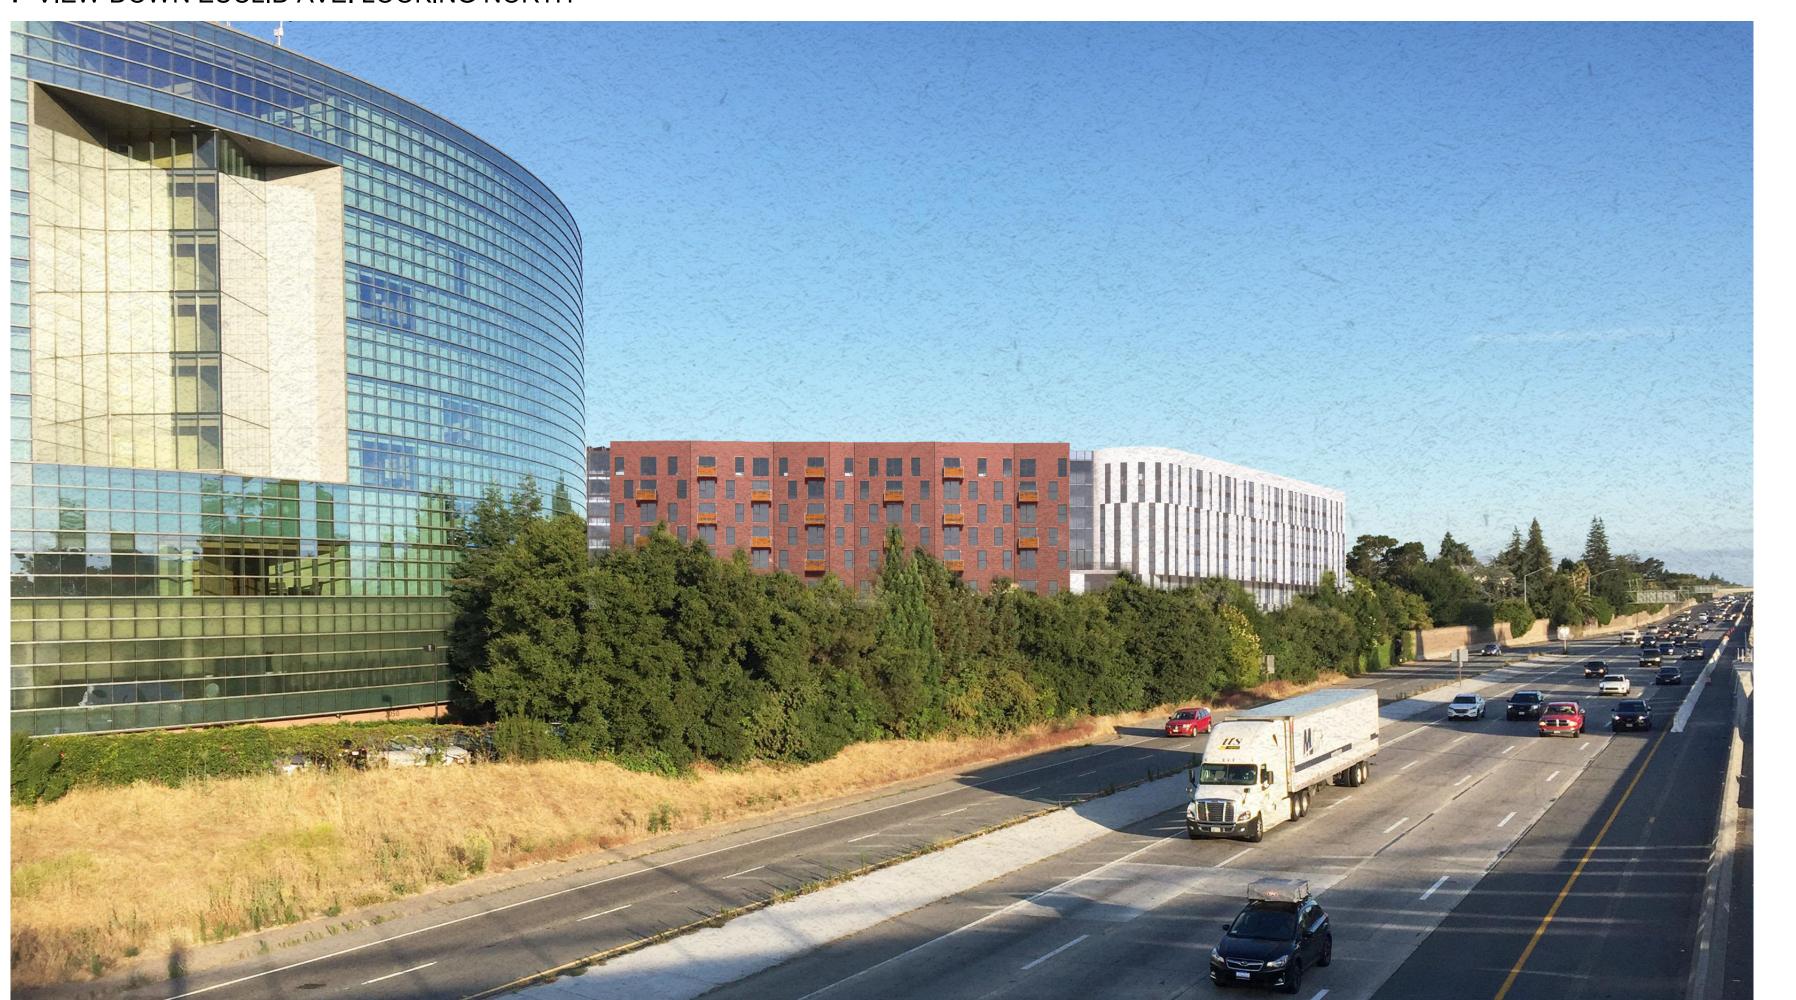
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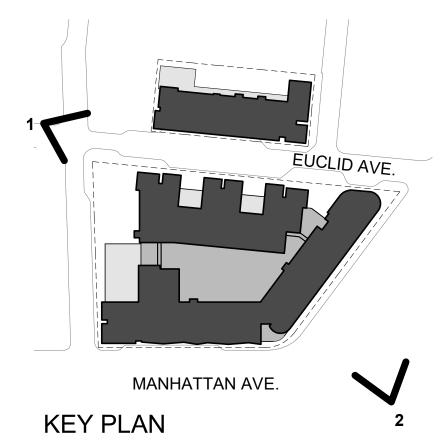
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PERSPECTIVE VIEWS


G101

1- VIEW DOWN EUCLID AVE. LOOKING NORTH





2- VIEW FROM US 101/ UNIVERSITY AVE OVERPASS (FOUR SEASONS HOTEL IN FOREGROUND)

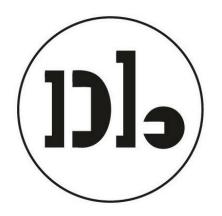

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PERSPECTIVE VIEWS

G102



PROJECT



Woodland Park Euclid Improvements



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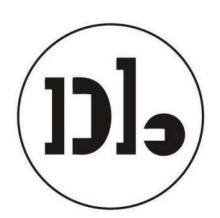
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AERIAL VIEW

G103





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SITE PLAN -**EXISTING**

> Sheet No. A100

08-23-2022 Project No. 21620

Date

LOBBY EUCLID AVENUE THINNER DASHED LINE INDICATES BUILDING OVERHANG ABOVE SETBACK - PROPERTY BOUNDARIES NEW BUS STOP CORNER PARK O'CONNOR ST. RETAIL ROOM PKG RM TRASH MPOE ROOM GARAGE ELEC COMMUNITY ROOM 1 BR 1 BR RED FILL REGIONS INDICATE CORNER VISION TRIANGLE MANHATTAN AVE. 0' 7.5' 15' 30' FOUR SEASONS / UNIVERSITY CIRCLE COMPLEX

Woodland Park Euclid Improvements



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SITE PLAN -PROPOSED

A101

Project No.

02/09/2024 21620

59' - 4" 156' - 8" 35' - 6" 6' - 6" LOADING ZONE O'KEEFE . **MAINT.** 611 SF LOBBY 2539 SF EUCLID AVENUE 89' - 8" 270' - 9" 154' - 4" NEW BUS STOP DROP-OFF / LOADING AREA CORNER PARK 9694 SF O'CONNOR ST RETAIL 1355 SF GARAGE MAINTENANCE ROOM 1722 SF PACKAGE 479 SF TRASH ROOM 637 SF COMMUNITY ROOM 2372 SF GARAGE MPOE ENTRY ELEC 607 SF MANHATTAN AVE. 188' - 2" FOUR SEASONS / UNIVERSITY CIRCLE COMPLEX

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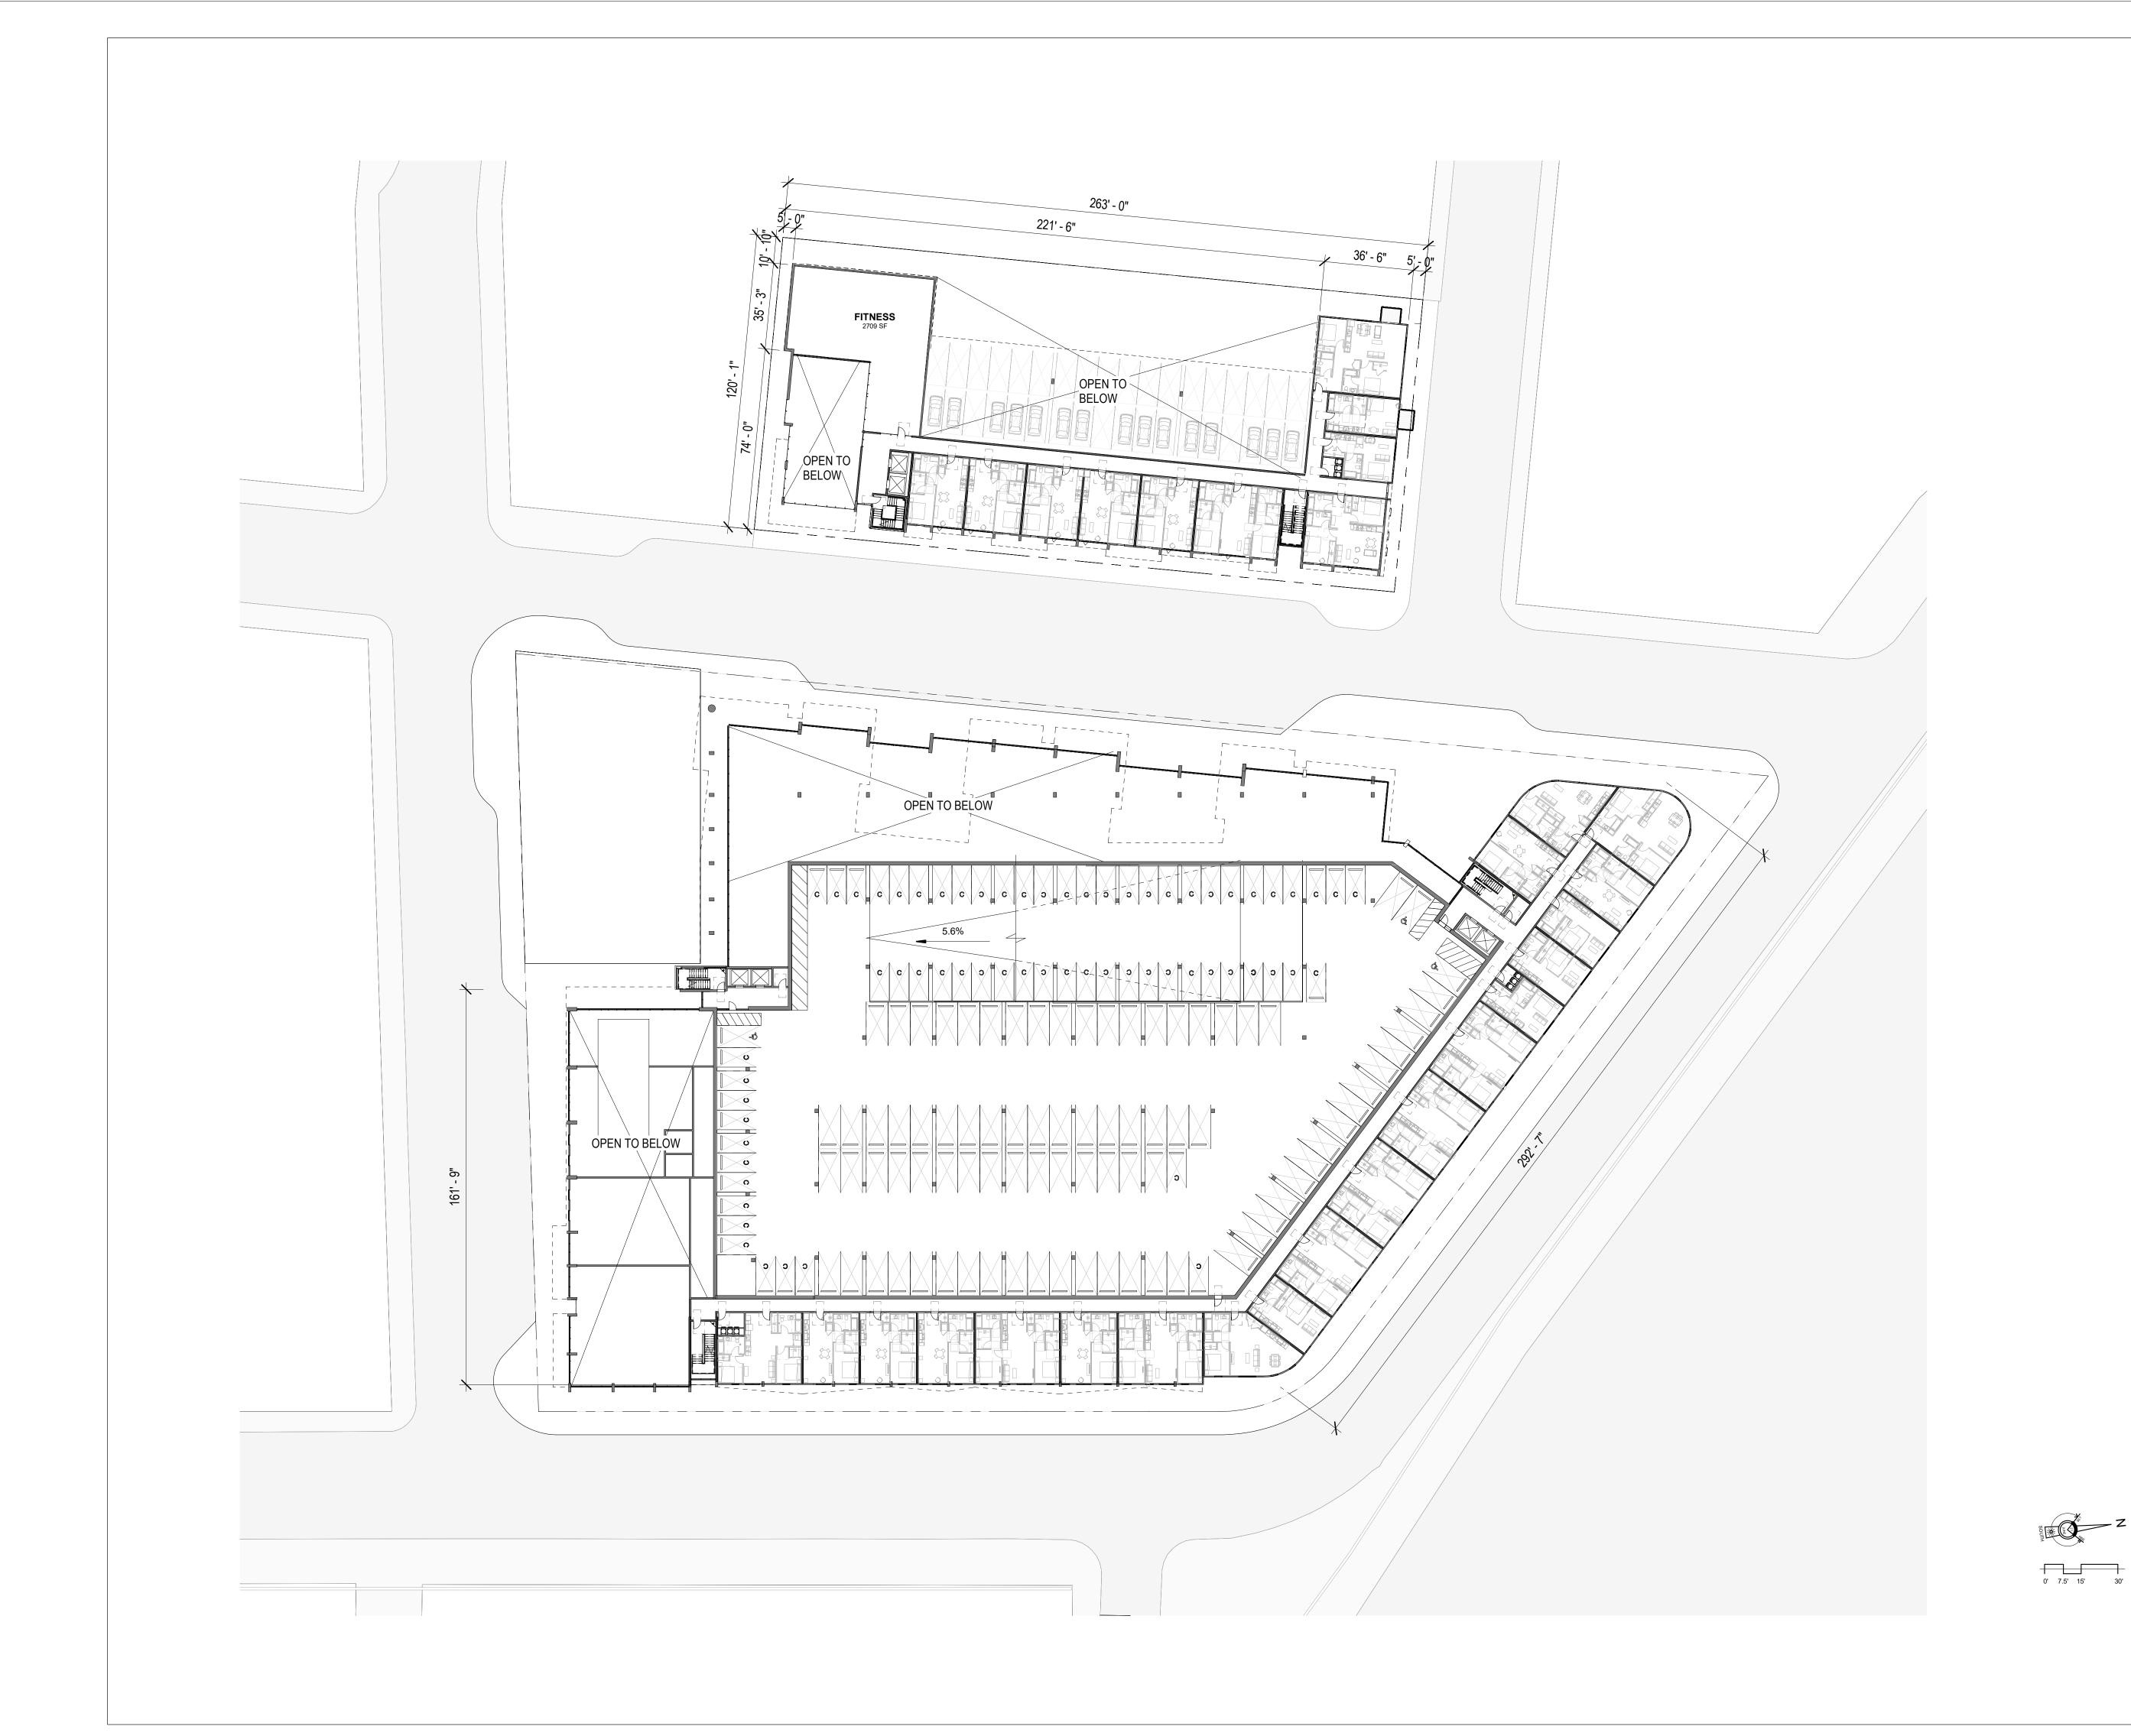
FLOOR PLAN -LEVEL 1

A201

Project No.

0' 7.5' 15' 30'

02/09/2024 21620





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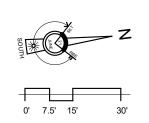
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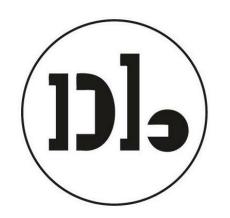
FLOOR PLAN -LEVEL 2

A202









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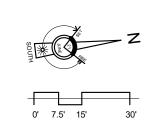
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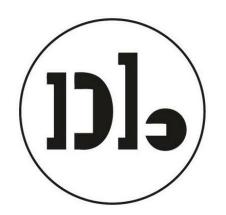
FLOOR PLAN -LEVEL 3

A203









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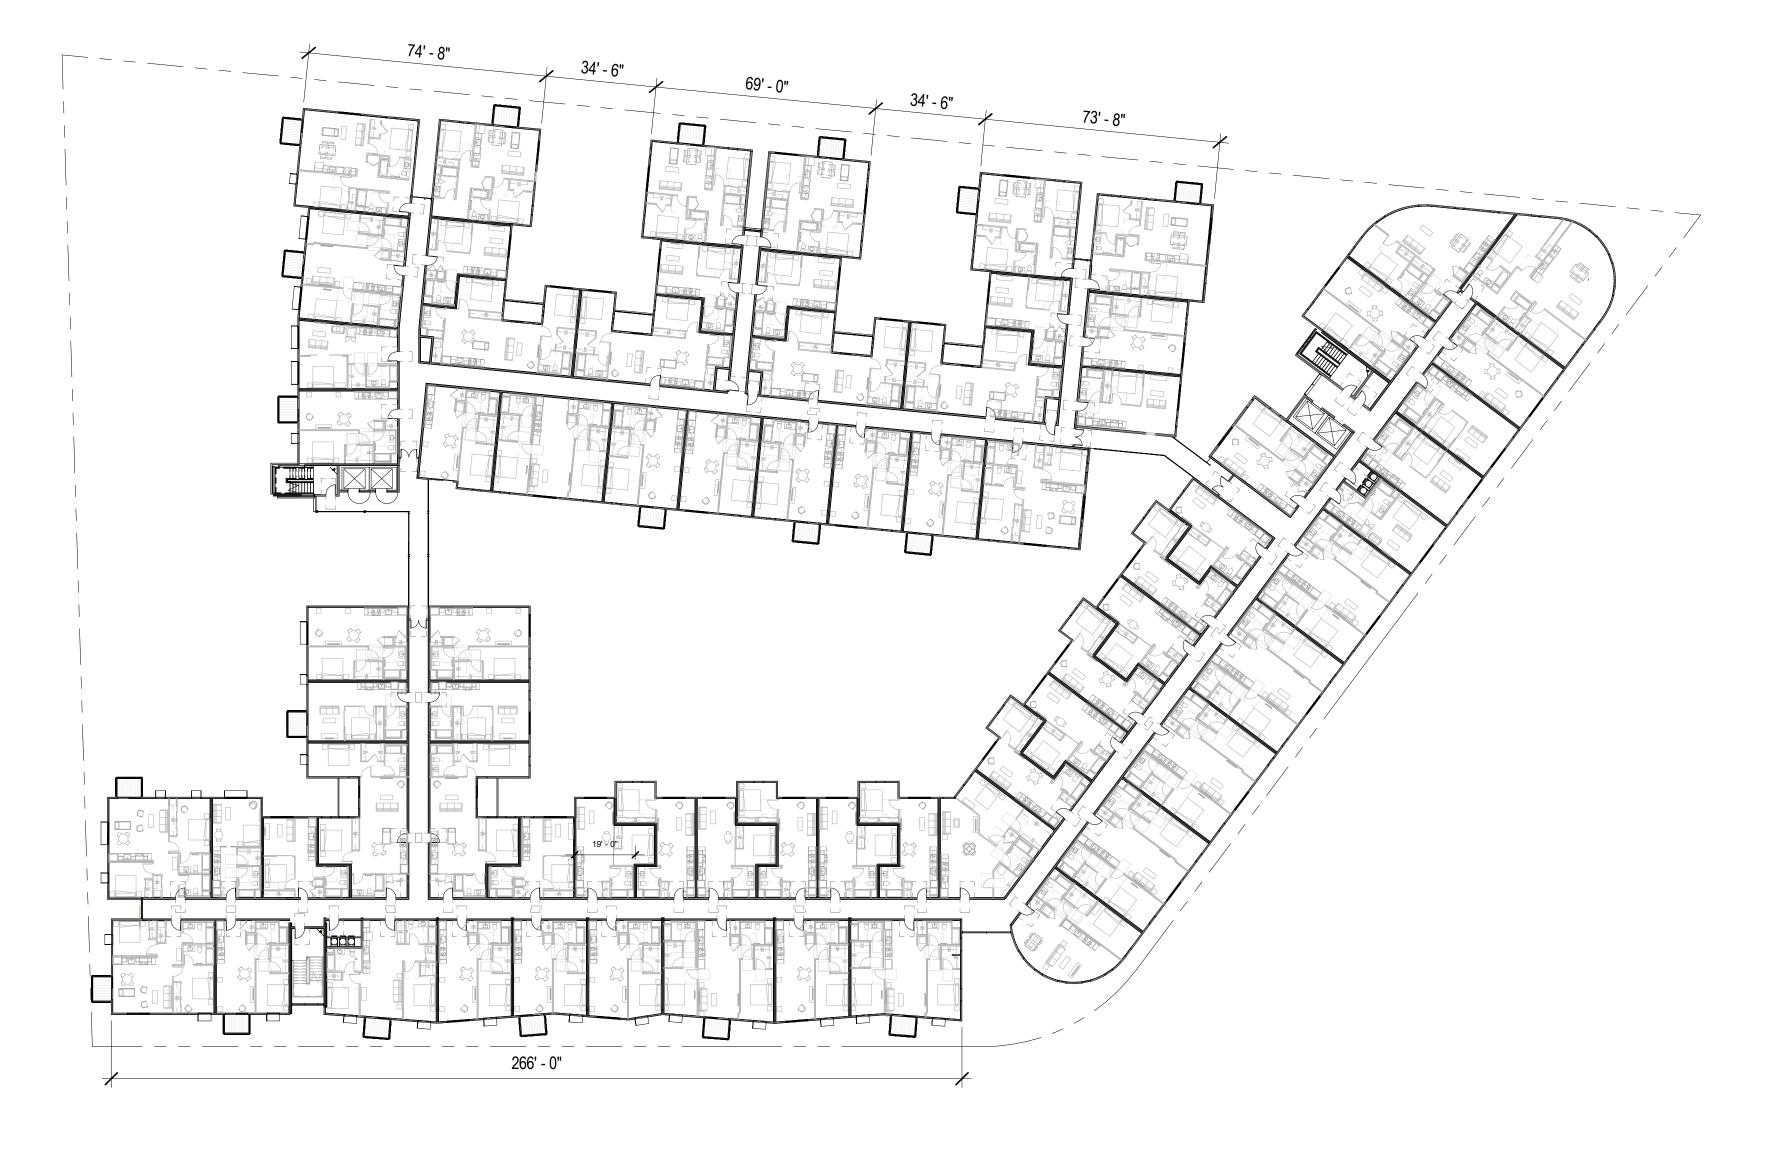
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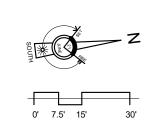
FLOOR PLAN -LEVEL 4


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A204







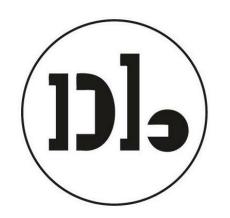

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Design Update -February 2024

Drawing Title

FLOOR PLAN -LEVELS 5-7

A205

02/09/2

02/09/2024 21620

Date Project No.







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Rev.	Description	Date

Design Update -February 2024

Drawing Title

FLOOR PLAN -LEVELS 8

Sheet No.

02/09/2024 Date Project No. 21620

A206

0' 7.5' 15' 30'

MATERIAL LEGEND

- 1 Textured Concrete with Vine Cover
- 2 Vertical Wood Siding
- 3 Storefront System4 Cement Board (Dark)
- 5 Cement Board (Light)
- 6 Perforated Metal Screen (Painted)
- 7 GFRC
- 8 Thin Brick
- 9 Aluminum Windows
- 10 Balconies with Perforated Metal Guardrails
- 11 Corten Steel Panels12 Smooth Concrete
- 13 Metal Sunshade
- 14 Standing Seam Steel



MANHATTAN AVE.

Key Plan
1" = 160'-0"

NOTE: PLEASE REFER TO LANDSCAPE PLAN FOR PLANTING LOCATIONS







Woodland Park Euclid Improvements



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Rev.	Description	Date

Design Update -February 2024

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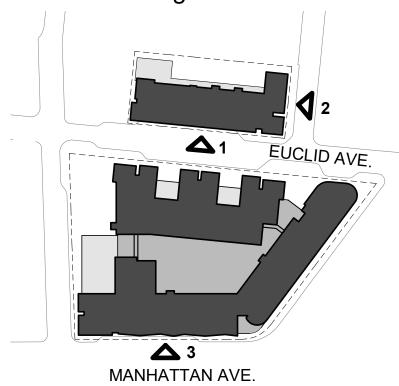
BUILDING **ELEVATIONS**

> Sheet No. A300

02/09/2024 Project No. 21620

MATERIAL LEGEND

- 1 Textured Concrete with Vine Cover
- 2 Vertical Wood Siding
- 3 Storefront System4 Cement Board (Dark)
- 5 Cement Board (Light) 6 Perforated Metal Screen (Painted)
- 7 GFRC
- 8 Thin Brick
- 9 Aluminum Windows
- 10 Balconies with Perforated Metal Guardrails
- 11 Corten Steel Panels12 Smooth Concrete
- 13 Metal Sunshade
- 14 Standing Seam Steel



Key Plan
1" = 160'-0"


NOTE: PLEASE REFER TO LANDSCAPE PLAN FOR PLANTING LOCATIONS







Woodland Park Euclid Improvements

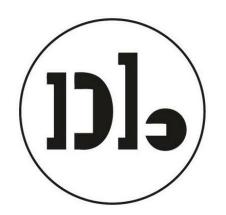

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Rev.	Description	Date


Design Update -February 2024


Drawing Title

BUILDING **ELEVATIONS**


A301

02/09/2024 Project No. 21620

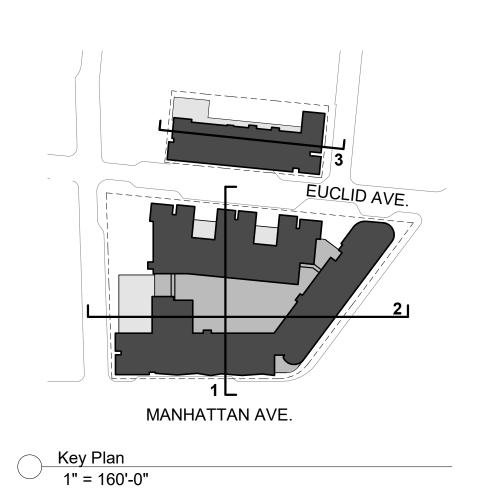


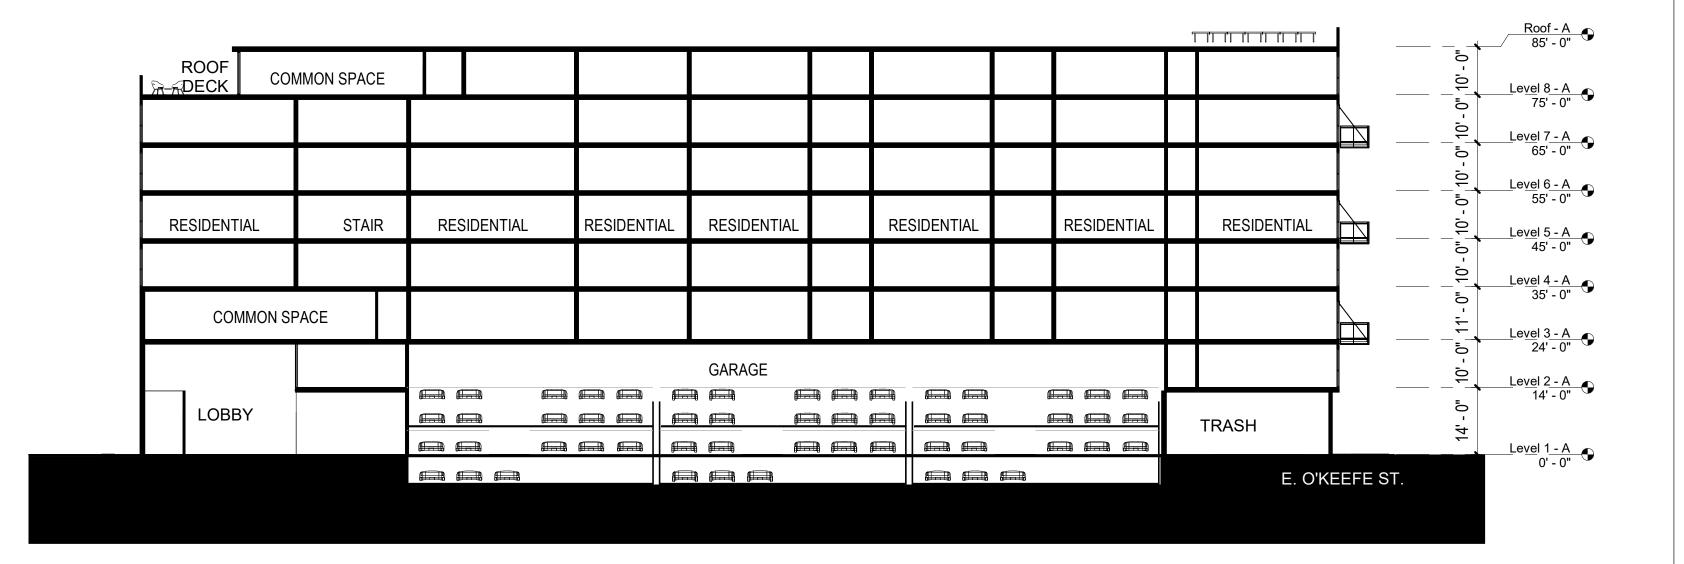


Building Section - N/S West Building
1" = 20'-0"

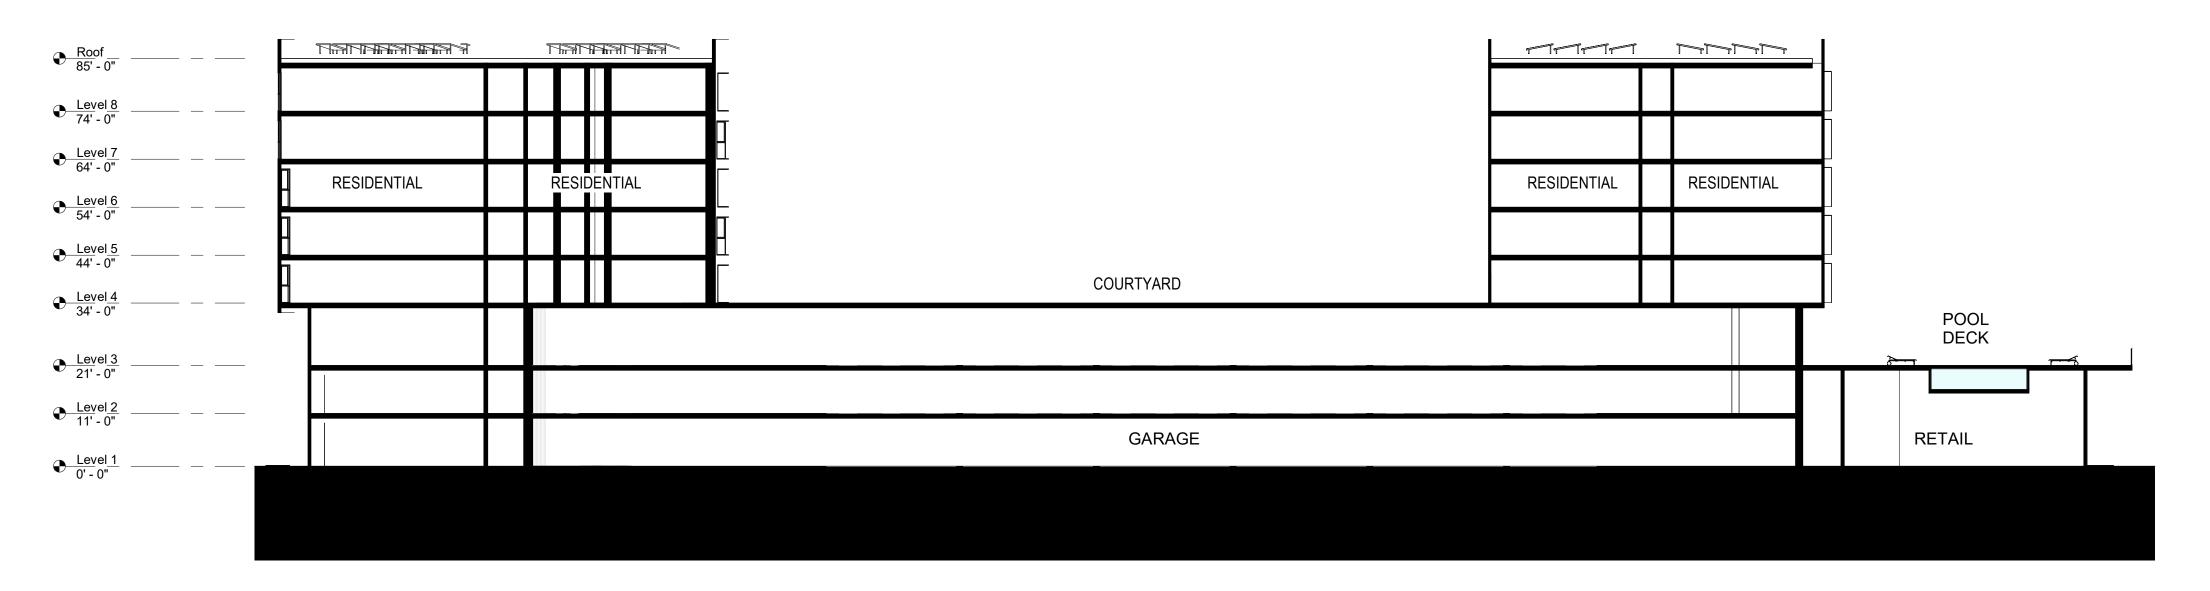

Building Section - N/S
1" = 20'-0"

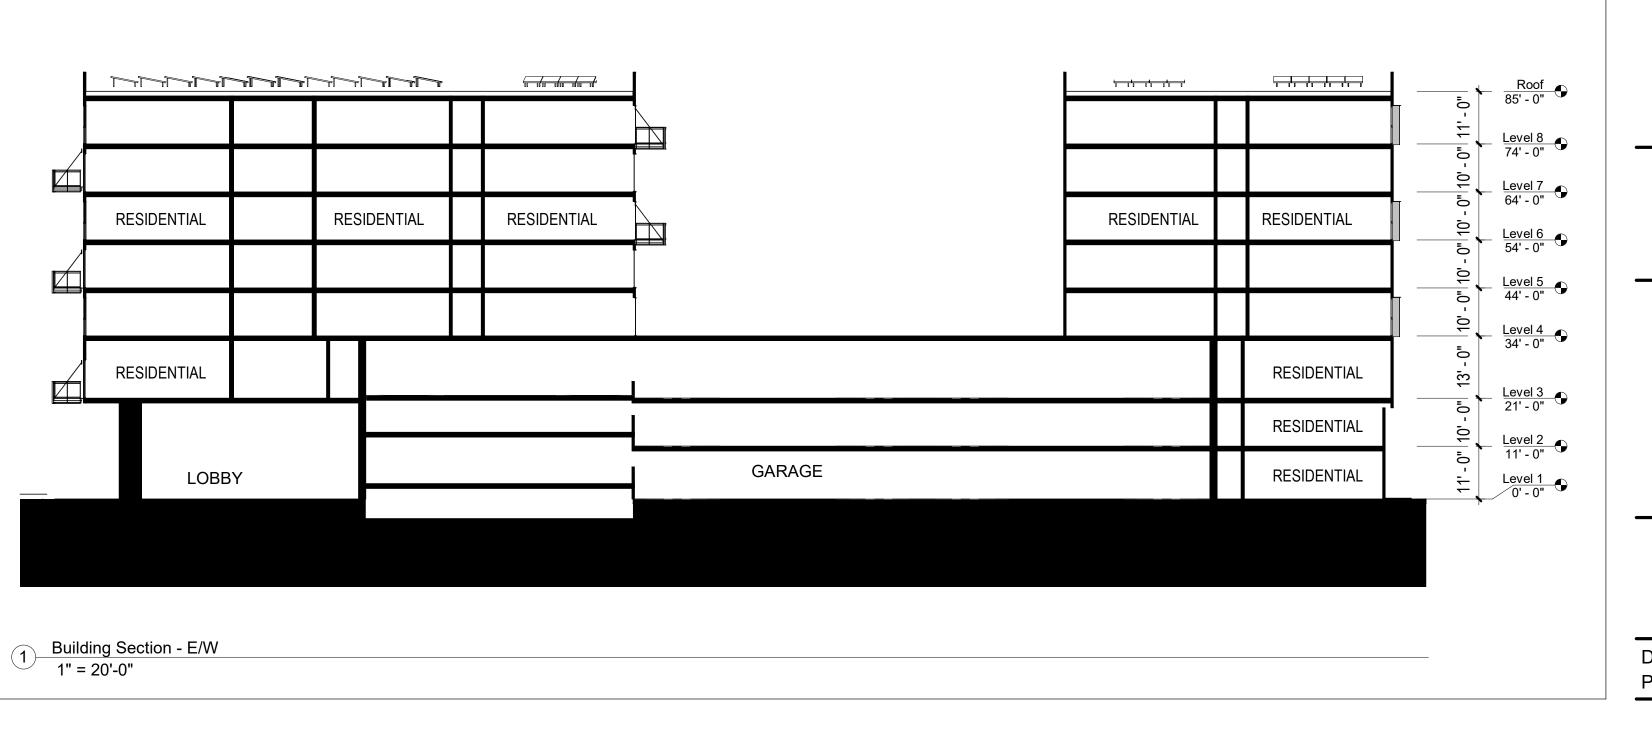

Woodland Park Euclid Improvements

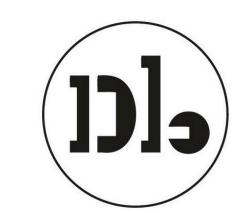

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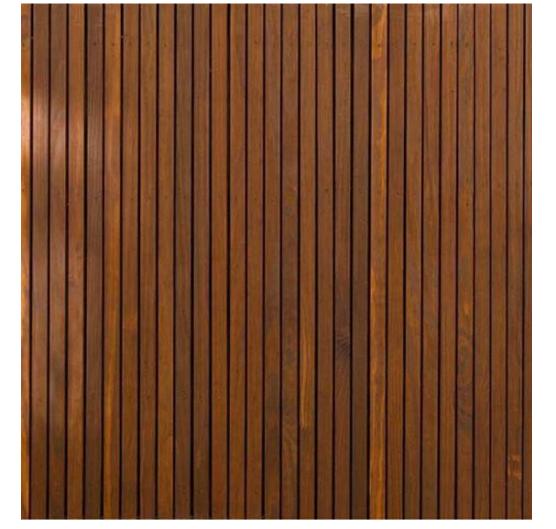
Design Update -February 2024

Drawing Title

BUILDING SECTIONS

Sheet No. A302


1 - Textured Concrete with Vine Cover




2 - Vertical Wood Siding




3 - Storefront System

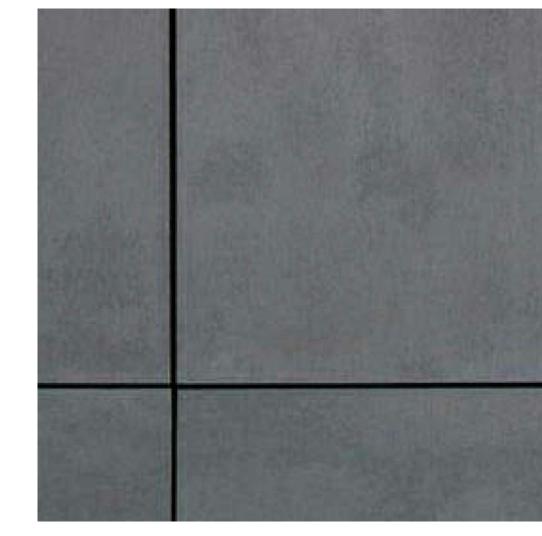

4 - Cement Board (Dark)

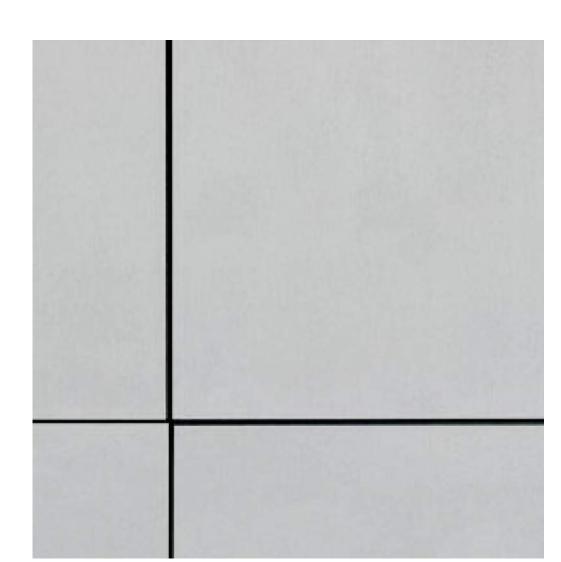


5 - Cement Board (Light)

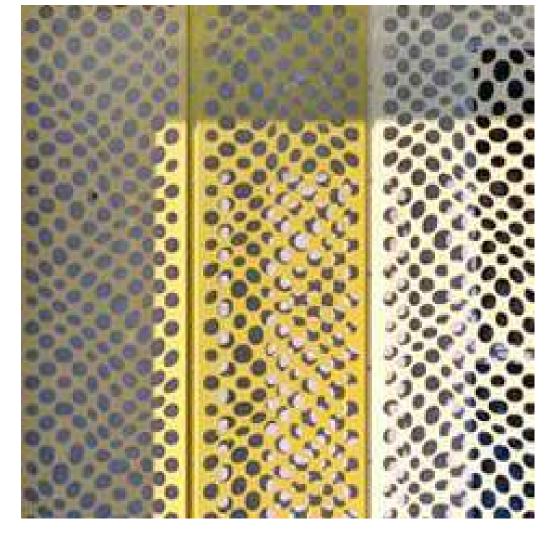

6 - Perforated Metal Screen (Painted)




7 - GFRC

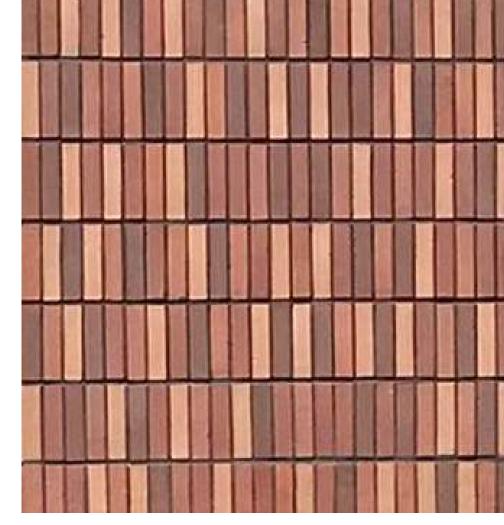

8 - Thin Brick



9 - Aluminum Windows

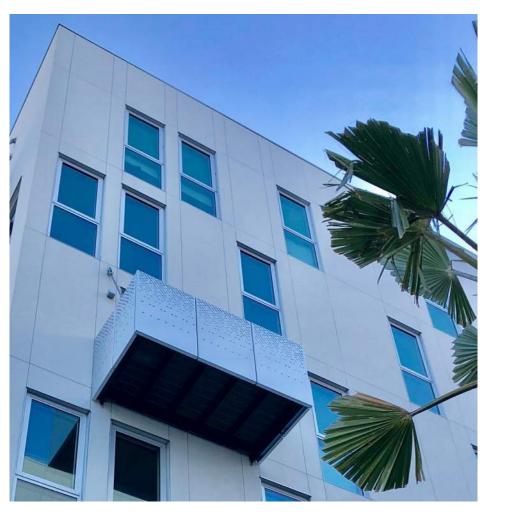

10 - Balconies with Perforated Metal Guardrails



11 - Corten Steel Panels



12 - Smooth Concrete



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EXTERIOR MATERIALS

A303

 Date
 12-08-2023

 Project No.
 21620

OPEN SPACE -PUBLIC 1220 SF OPEN SPACE OPEN SPACE **PUBLIC** CORNER PARK OPEN SPACE PUBLIC PLAZA 9139 SF OPEN SPACE -PUBLIC 988 SF OPEN SPACE -2000 SF OPEN SPACE -1 LEVEL 1 PLAN - OPEN SPACE DIAGRAM 1" = 50' 0" 1" = 50'-0"

OPEN SPACE -1370 SF OPEN SPACE -COMMON 2163 SF **OPEN SPACE -**PRIVATE OPEN SPACE PRIVATE OPEN SPACE -PRIVATE OPEN SPACE -OPEN SPACE -PRIVATE 48 SF 1741 SF OPEN SPACE - OPEN SPACE -OPEN SPACE -OPEN SPACE -PRIVATE PRIVATE 48 SF OPEN SPACE -OPEN SPACE -PRIVATE -OPEN SPACE -PRIVATE OPEN SPACE COMMON 6802 SF OPEN SPACE - OPEN SPACE - OPEN SPACE -PRIVATE 2 LEVEL 3 PLAN - OPEN SPACE DIGRAM 1" = 50' 0" 48 SF 48 SF

EAST PALO ALTO DEVELOPMENT CODE 18.08.010:

Common Open Space. The land area within a residential or nonresidential development not individually owned or dedicated for public use and designed, intended, and reserved exclusively for the shared enjoyment or use by all the residents and their guests. Does not include enclosed spaces/facilities (e.g., community center, meeting rooms, etc.)

Private Open Space. An outdoor or unenclosed area directly adjoining and accessible to a dwelling unit, reserved for the exclusive private enjoyment and use of residents of the dwelling unit and their guests (e.g., balcony, deck, porch, terrace, etc.). Boundaries are evident through the use of fences, gates, hedges, walls, or other similar methods of controlling access and maintaining privacy.

Publicly Accessible / Usable Open Space. An outdoor or unenclosed area within a residential development on the ground, or on a roof, balcony, deck, porch or terrace, designed and accessible for outdoor living, active or passive recreation, pedestrian access, or landscaping. Parking facilities, driveways,utility or service areas and submerged land do not constitute usable open space.

EAST PARCEL

PRIVATE:

(BALCONIES)

USABLE / PUBLIC:

OPEN SPACE - COMMON

OPEN SPACE - COMMON

OPEN SPACE - COMMON

OPEN SPACE - PRIVATE | 14 | OPEN SPACE - PRIVATE | 45 |

OPEN SPACE - PRIVATE | 40

OPEN SPACE - PRIVATE | 33

OPEN SPACE - PRIVATE 40

OPEN SPACE - PRIVATE | 30

East Parcel Grand Total

OPEN SPACE - PROVIDED

W	'EST	PARCEL	

COMMON:

Level 3	OPEN SPACE - COMMON	2,163 SF
Level 8	OPEN SPACE - COMMON	2,276 SF
		4,439 SF

PRIVATE:

(BALCONIES)

_evel 2	OPEN SPACE - PRIVATE	2	96 SI
_evel 3	OPEN SPACE - PRIVATE	7	1,658 SI
_evel 4	OPEN SPACE - PRIVATE	12	574 SI
_evel 5	OPEN SPACE - PRIVATE	11	528 SI
_evel 6	OPEN SPACE - PRIVATE	12	574 SI
_evel 7	OPEN SPACE - PRIVATE	11	528 SI
_evel 8	OPEN SPACE - PRIVATE	10	478 SI
		65	4,437 SI

West Parcel Grand Total

USABLE / PUBLIC:

Level 1	OPEN SPACE - PUBLIC	1,628 SF	Level 1	OPEN SPACE - PUBLIC
		1,628 SF		

10,504 SF

PROJECT TOTAL:

TOTAL OPEN SPACE PROVIDED: 10,504 SF + 60,492 SF = 70,996 SF TOTAL

- 9,335 SF OF WHICH IS PARK SPACE (COMMUNITY BENEFIT)

= 61,661 SF TOTAL OPEN SPACE (110 SF PER UNIT)

6,802 SF

17,682 SF

3,251 SF

27,734 SF

3,964 SF

2,293 SF

2,071 SF

1,734 SF

2,071 SF 1,591 SF


13,724 SF

19,034 SF 19,034 SF

60,492 SF

202

Woodland Park Euclid Improvements

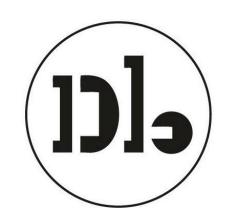

David Baker Architects

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License Stamp

	Issuances
Description	Date
Design Update	2/27/2024

		Revision
Rev.	Description	Dat

Sat Title

Design Update - February 2024


Drawing Title

OPEN SPACE DIAGRAMS

A500

OPEN SPACE -OPEN SPACE -PRIVATE 48 SF PRIVATE 48 SF OPEN SPACE -PRIVATE OPEN SPACE -PRIVATE -48 SF OPEN SPACE -PRIVATE OPEN SPACE -PRIVATE OPEN SPACE -PRIVATE -OPEN SPACE PRIVATE OPEN SPACE -PRIVATE OPEN SPACE -OPEN SPACE -OPEN SPACE -PRIVATE -PRIVATE 48 SF PRIVATE 48 SF 48 SF 48 SF OPEN SPACE - OPEN SPACE - PRIVATE PRIVATE PRIVATE OPEN SPACE -PRIVATE OPEN SPACE -— PRIVATE OPEN SPACE -OPEN SPACE - OPEN SPACE - PRIVATE PRIVATE OPEN SPACE -COMMON 17367 SF OPEN SPACE -PRIVATE 48 SF OPEN SPACE OPEN SPAC OPEN SPACE -OPEN SPACE OPEN SPACE - OPEN SPACE -OPEN SPACE -— COMMON 315 SF 1" = 50'-0"

1" = 50'-0"

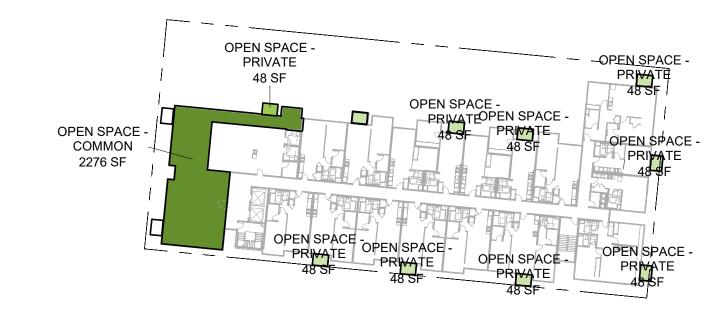



2 LEVEL 8 PLAN - OPEN SPACE DIAGRAM 1" = 50'-0"

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	Issuances
Description	Date
Design Update	2/27/2024

		Revisions
Rev.	Description	Date

Design Update -February 2024

Drawing Title

OPEN SPACE DIAGRAMS

A502

Date Project No.

02/09/2024 21620



LEGEND:

PAVING	<u>3</u>	
KEY	SYMBOL	DESCRIPTION / LOCATION
P1		DECOMPOSED GRANITE
P2	0000	GRAVEL
РЗ		CIP CONCRETE
P4		ASPHALT BLOCK PAVER
P5		CIP COLORED CONCRETE
P6		STONE PAVERS
P7		ECO GRID PAVER AT PARKING
FURNI	SHINGS	
KEY	SYMBOL	DESCRIPTION / LOCATION
F1		WOOD BENCH
F2		PICNIC TABLE
F3		BBQ GRILL
F4		CUSTOM PLAY AN SEATING STRUCTU
F5		CURVED CONCRE BENCH
F6		GARDEN BED
F7	o	BIKE RACK / BOLLARD
PLANT	LIST	
TREES		
KEY	SYMBOL	COMMON NAME
	And the state of t	PROTECTED TREE
FRAM		WHITE ASH
ARMA	\odot	MARINA STRAWBER TREE
QUDO	+	BLUE OAK
PIXR		RED PUSH PISTACI

PA PLANTING AREA

IRONWOOD

PAPE

Woodland Park Euclid Improvements



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HOOD DESIGN STUDIO, I 3016 FILBERT street studio 2 GAKLAND, CA 94608 510 . 595 9688 www.hooddesignstudio.com

Description Issuances

Rev. Description Date

Set Title


Design Update -February 2024

Drawing Title


Landscape Site Plan

Sheet No.


Date 27 February, 2024 Project No. 21620

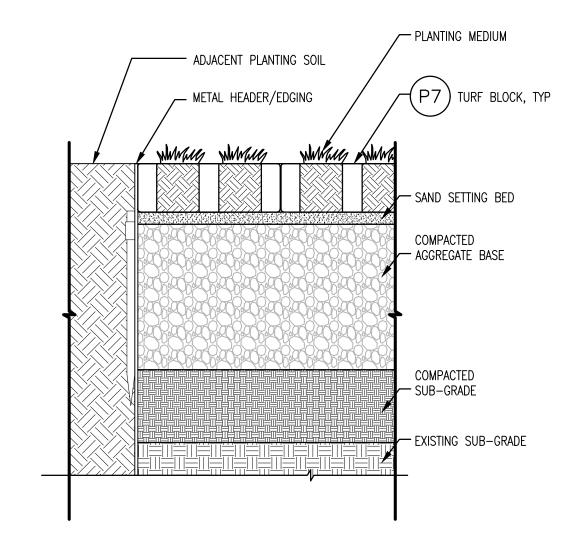

5 P7 - ECO-GRID PAVER AT PLANTING SCALE: 1-1/2" = 1' - 0"

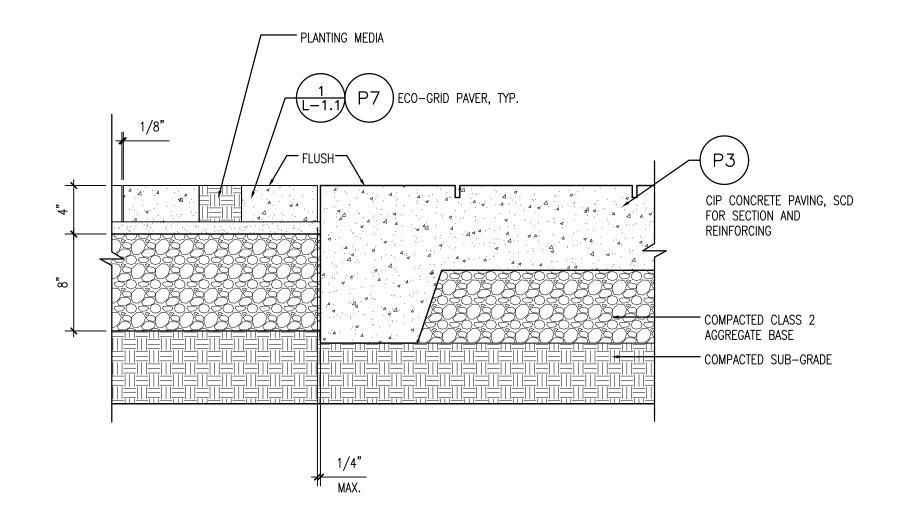

4 P7 - ECO-GRID PAVER AT CONCRETE PAVING SCALE: 1-1/2" = 1' - 0"

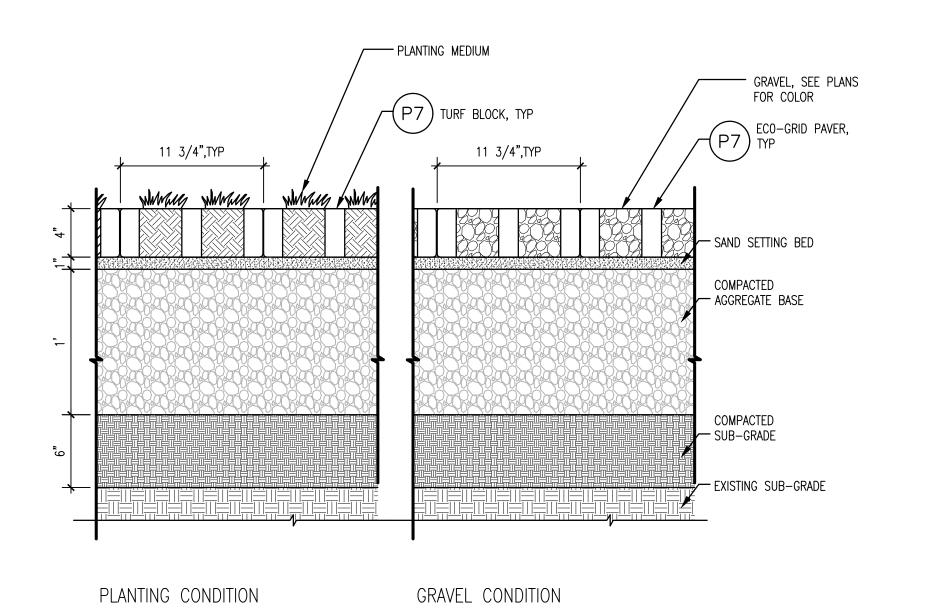


3 P7 - ECO-GRID PAVER, TYPICAL SCALE: 1-1/2" = 1' - 0"










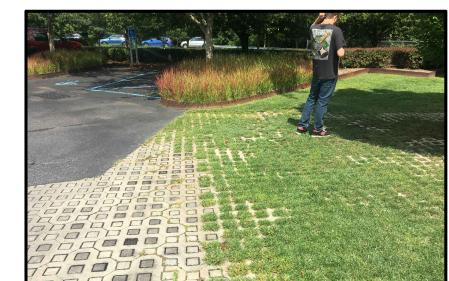






2 P7 - ECO-GRID PAVER (REFERENCES)
scale: N/A

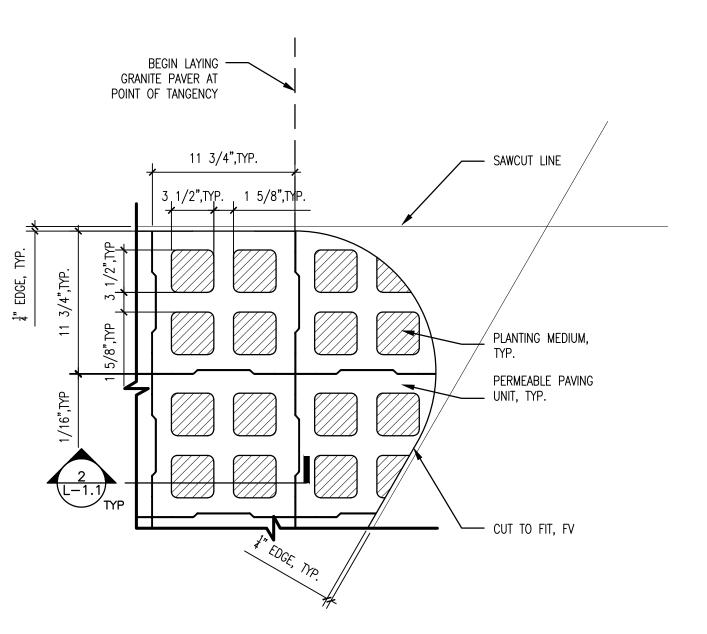

1 P7 - ECO-GRID PAVERS FOR FLEX PARKING AREA SCALE: 1-1/2" = 1' - 0"

Woodland Park Euclid Improvements

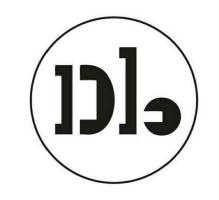

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Description Issuances

Revisions

Rev. Description Date

Set Title

Design Update -February 2024

Drawing Title

Landscape Details

Sheet No.

Date 27 February, 2024 Project No. 21620

GENERAL NOTES

- 1. ALL TREE REMOVAL WORK SHALL BE PERFORMED IN CONFORMANCE WITH APPLICABLE LOCAL CODES AND
- 2. ALL ADDITIONAL REQUIREMENTS FOR TREE PROTECTION AND MITIGATION AS REQUIRED BY THE CITY ARBORIST AND THE PROJECT ARBORIST SHALL BE FOLLOWED. REFERENCE CITY OF SANTA CLARA ARBORIST NOTES AND PROJECT ARBORIST NOTES.
- 3. CONTRACTOR SHALL VISIT THE SITE WITH OWNER'S REPRESENTATIVES PRIOR TO BEGINNING ANY WORK. VERIFY ALL TREES, SHRUBS & VEGETATION WITHIN THE LIMITS OF WORK TO BE REMOVED AND ALL TREES & PLANTS TO REMAIN AND TO BE PROTECTED.
- 4. ALL TREES AND PLANTS DESIGNATED TO REMAIN SHALL BE PROTECTED FROM PHYSICAL DAMAGE AND MAINTAINED THROUGHOUT THE DURATION OF THE CONTRACT. THOSE TREES AND PLANTS INDICATED TO BE REMOVED SHALL BE COMPLETELY REMOVED, INCLUDING THE ROOTS, AND DISPOSED OF OFF-SITE. BACKFILL EXCAVATED AREAS TO RESTORE TO EXISTING GRADE.
- 5. PROTECTIVE FENCING: TEMPORARY FENCES OR BARRICADES SHALL BE INSTALLED AS SHOWN ON THE DRAWINGS OR AS DIRECTED IN THE FIELD BY THE PROJECT ARBORIST OR THE OWNER'S REPRESENTATIVE. FENCING SHALL BE A MINIMUM OF SIX (6) FOOT HEIGHT, CHAIN LINK. MAINTAIN FENCING IN CONTINUOUS, STABLE AND UPRIGHT CONDITION AT ALL TIMES.
- 6. CONTRACTOR SHALL REMOVE FROM THE SITE ALL DEBRIS AND UNSUITABLE MATERIAL GENERATED FROM CONSTRUCTION AND DISPOSE OF IN A LAWFUL MANNER.

PROJECT ARBORIST NOTES

1. THE TREE PRESERVATION GUIDELINES ARE SUPERSEDED BY THE CITY OF SANTA CLARA ARBORIST NOTES INCLUDED IN THE DOCUMENTS PROVIDED. THIS INCLUDES CITY TREE DAMAGE PENALTIES IN THE CASE THAT TREES DIE OR ARE DAMAGED DUE TO FAILURE TO PROVIDE ADEQUATE PROTECTIONS. CITY REQUIRES THAT ARBORIST SUPERVISION OF PROJECT TREE PROTECTION BE CONDUCTED BY CITY ARBORIST OR ARBORIST EMPLOYED BY CITY.

2. THESE GUIDELINES PROVIDE FOR THE CARE AND MAINTENANCE OF THE TREE(S) BEFORE, DURING AND AFTER CONSTRUCTION ACTIVITIES. THE GOAL OF TREE PROTECTION AND PRESERVATION IS TO PROVIDE FOR A SUCCESSFUL TRANSITION TO A MODIFIED SITE.

3. TO BE MOST EFFECTIVE, TREE PRESERVATION AND HEALTH MITIGATION MEASURES MUST COMMENCE WELL BEFORE THE TIME OF DISTURBANCE AS HEALTHY TREES ARE MORE LIKELY TO SURVIVE ADVERSE IMPACTS.

4. TO BE EFFECTIVE, PROJECT ARBORIST MUST HAVE THE ABILITY TO ASSURE THE GUIDELINES ARE OBSERVED AND HAVE THE ABILITY TO HALT ALL CONSTRUCTION ACTIVITIES IF TRANSGRESSIONS OCCUR.

5. PROJECT CONSTRUCTION DOCUMENTS MUST ACCURATELY SHOW TREE PROTECTION AREAS AND SPECIFY PROTOCOL AND PROCEDURES TO BE USED FOR ALL ACTIVITIES WITHIN THE DESIGNATED TREE PROTECTION AREA.

SITE ANALYSIS AND EARLY TREE HEALTH MITIGATION

6. THE INFORMATION GAINED FROM SITE ANALYSIS IS UTILIZED FOR ROOT AND SOIL PROTECTION AND TO ASSURE THAT ADEQUATE MITIGATION TREATMENTS ARE

7. SOIL PROFILE EXAMINATION – THE SOIL PROFILE EXAMINATION DETERMINES SOIL TEXTURE AND MOISTURE LEVELS. SOIL COMPACTION IS ALSO ASSESSED. THIS INFORMATION IS VITAL TO THE UNDERSTANDING OF THE LEVEL OF SOIL PROTECTION AND MITIGATION THAT WILL BE NECESSARY.

8. LABORATORY ANALYSIS - ANALYSIS OF SOIL AND PLANT TISSUE SAMPLES CAN HELP GUIDE THE USE OF SOIL AMENDMENTS AND FERTILIZATION.

9. ROOT INVESTIGATION - UNDERSTANDING THE DEPTH, SIZE AND AMOUNT OF ROOTS PRESENT IS REQUIRED TO HELP GUIDE PROJECT DESIGN AND ANTICIPATE WHEN A TREE IS UNLIKELY TO SURVIVE.

10. MITIGATION OF LIMITATIONS IDENTIFIED - LIMITATIONS IDENTIFIED DURING SITE ANALYSIS ACTIVITIES ARE BEST MITIGATED PRIOR TO THE BEGINNING OF CONSTRUCTION ACTIVITIES. POSSIBLE LIMITATIONS TO BE MITIGATED INCLUDE SOIL COMPACTION, NUTRITIONAL DEFICIENCIES AND INSUFFICIENT OR EXCESS SOIL MOISTURE. MOST BASIC MITIGATION ENTAILS: IRRIGATION, MULCHING, WATER JET AND AIR SPADE PROCEDURES. SOIL AMENDMENTS OTHER THAN GOOD QUALITY MULCH MUST BE BASED UPON LABORATORY SOIL AND/OR TISSUE ANALYSIS.

PRE-CONSTRUCTION ACTIVITIES

11. THESE ACTIVITIES SHOULD BE UNDERTAKEN PRIOR TO INITIATION OF CONSTRUCTION ACTIVITY.

12. MULCHING – USE OF GOOD QUALITY ORGANIC MULCH (WOOD CHIPS ARE BEST) ON SOIL SURFACE HELPS TO REDUCE SOIL COMPACTION AND RETAIN SOIL MOISTURE. RECOMMENDED MATERIAL IS WOOD CHIPS GENERATED FROM TREE TRIMMING. FRESH REDWOOD, INCENSE CEDAR AND WALNUT CHIPS ARE NOT ACCEPTABLE, NOR IS PALM GENERATED MULCH.

13. CROWN PRUNING -PRUNING MUST COMPLY WITH ANSI A300 PRUNING STANDARDS. PRUNING PRIOR TO CONSTRUCTION SHOULD INCLUDE: NECESSARY CLEARANCE PRUNING, DEADWOOD REMOVAL AND SAFETY PRUNING.

14. CONSTRUCTION DOCUMENTS TO SHOW PROTECTED TREES AND TREE PROTECTION REQUIREMENTS - PROJECT PLANS TO SHOW ALL TREE PROTECTION FENCING LAYOUT, AREAS OF ENCROACHMENT AND LIST PROCEDURES FOR WORKING AROUND PROTECTED TREES.

15. DESIGNATION OF TREE ROOT PROTECTION ZONE (RPZ) - CITY OF SANTA ROSA ARBORIST NOTES DESIGNATES THE "TREE PROTECTION ZONE AS 1.5 TIMES THE RADIUS OF THE DRIP LINE". THE TREE ROOT PROTECTION ZONE DESIGNATES AN AREA SURROUNDING A TREE OR GROUPING OF TREES THAT IS TO BE FENCED OFF FROM ALL ACCESS. NO MATTER THE RADIUS OF THE DRIP ZONE, THE RPZ IS NOT TO BE LESS THAN ONE (1) FOOT RADIAL DISTANCE FROM THE BASE OF THE TREE FOR EVERY ONE (1) INCH IN TREE DIAMETER. A TREE WITH A 10 INCH DIAMETER WOULD HAVE A MINIMUM RPZ EQUAL TO 10 FEET OUT FROM THE TREE. PROJECT ARBORIST CAN MODIFY THE RPZ DISTANCE BASED UPON PHYSICAL EVIDENCE OF ROOT PRESENCE OR ABSENCE.

16. TREE ROOT PROTECTION ZONE FENCING - FENCING IS TO BE CHAIN-LINK TYPE METAL FENCING WITH METAL POSTS DRIVEN TWO-FEET INTO THE SOIL. SIGNS SHALL BE ATTACHED TO TREE PROTECTION FENCING EVERY 20' WHICH READ "TREE PROTECTION ZONE DO NOT ENTER".

17. PROCEDURES AND TREATMENTS FOR WORK ACTIVITIES THAT MUST OCCUR INSIDE OF THE RPZ - ALL SUCH ACTIVITIES AND RELOCATION OF FENCING MUST BE OVERSEEN BY PROJECT ARBORIST. SPECIAL TRUNK, SCAFFOLD AND SOIL PROTECTION MEASURES ARE REQUIRED. WHEN ENCROACHMENT IS ANTICIPATED PRIOR TO THE BEGINNING OF CONSTRUCTION ACTIVITIES, THE PROTECTIONS MUST BE IN PLACE PRIOR TO BEGINNING WORK ACTIVITIES.

18. ARBORIST REVIEW AND APPROVAL OF TREE PROTECTION MEASURES - PROJECT ARBORIST EMPLOYED BY THE CITY OF SANTA CLARA TO REVIEW TREE PROTECTION GUIDELINES AND MODIFY AS DEEMED NECESSARY.

19. TREE PROTECTIONS INSTALLATION AND INSPECTED - PROJECT ARBORIST MUST CERTIFY THAT ALL TREE PROTECTION MEASURES HAVE BEEN PROPERLY

20. PRE-CONSTRUCTION MEETING - CITY EMPLOYED PROJECT ARBORIST TO MEET WITH CONSTRUCTION SUPERVISOR AND WORK CREW TO REVIEW REQUIREMENTS OF THE TREE PROTECTION. ALL PERSONNEL WORKING ON SITE MUST BE PROVIDED AN ORIENTATION TO THE TREE PRESERVATION REQUIREMENTS. NO CONSTRUCTION ACTIVITIES MAY BEGIN UNTIL THIS MEETING HAS BEEN CONDUCTED.

21. PROJECT ARBORIST CAN DIRECT THAT ALL WORK ACTIVITIES STOP IF TREE PROTECTION GUIDELINES ARE NOT BEING FOLLOWED. ALL WORK ACTIVITIES CEASE UNTIL SUCH TIME AS THE PROBLEM HAS BEEN CORRECTED.

22. WORK ACTIVITIES THAT ENCROACH INTO THE DESIGNATED RPZ ARBORIST SUPERVISION – ALL ACTIVITIES OCCURRING WITHIN THE DESIGNATED RPZ MUST BE UNDER DIRECT SUPERVISION OF PROJECT ARBORIST.

ENCROACHMENT IS NOT PERMITTED UNTIL ALL ADDITIONAL PROTECTIONS ARE IN PLACE AND HAVE BEEN APPROVED.

23. SOIL AND ROOT PROTECTION -THE EFFECTS OF FOOT TRAFFIC CAN BE MITIGATED THROUGH THE USE OF SIX (6) INCHES OF WOOD CHIP MULCH AND ¾ INCH PLYWOOD PLACED ON TOP. PROTECTIONS FOR EQUIPMENT OPERATING WITHIN THE DESIGNATED RPZ REQUIRES 12 INCHES OF MULCH WITH EITHER METAL TRENCHING PLATES OR 1 1/8 INCH PLYWOOD PLACED ON TOP.

24. TRUNK AND SCAFFOLD PROTECTION – WHENEVER CONSTRUCTION ACTIVITY MUST OCCUR INSIDE THE TREE PROTECTION ZONE. THE BASE OF THE TREE AND THE FIRST EIGHT-FEET AND EXPOSED SCAFFOLD LIMBS MUST BE ARMORED. PROTECTION IS GENERALLY PROVIDED BY WRAPPING THE TRUNK WITH STRAW WADDLES COVERED WITH ORANGE PLASTIC CONSTRUCTION FENCING. EXPOSED SCAFFOLD LIMBS ARE BEST PROTECTED BY STRAPPING 2X4 BOARDS TO THE PART EXPOSED TO POTENTIAL INJURY AND WRAPPING WITH ORANGE PLASTIC FENCING MATERIAL.

25. REQUIRED METHOD OF EXCAVATION WITHIN CRITICAL ROOT ZONE - WHEREVER POSSIBLE, ROUTE UTILITIES OUTSIDE OF THE DESIGNATED RPZ. TUNNELING IS THE PREFERRED METHOD FOR UTILITIES PASSING THROUGH THE RPZ. WHEN TRENCHING IS REQUIRED, CAREFULLY HAND EXCAVATION OR THE USE OF THE AIR SPADE OR DITCH WITCH IS REQUIRED. PROJECT ARBORIST MUST APPROVE AND SUPERVISE ALL SUCH ACTIVITY.

26. NECESSARY ROOT PRUNING – LATE FALL SEASON IS THE BEST TIME FOR ROOT PRUNING. SPRING CAN BE THE MOST HARMFUL AT THIS IS THE TIME OF GREATEST MOISTURE NEEDS. ALL NECESSARY ROOT PRUNING IS CONDUCTED BY PROJECT ARBORIST AFTER THE ROOTS HAVE BEEN EXPOSED WITHOUT DAMAGE.

27. POST CONSTRUCTION MITIGATION ARBORIST DESIGNATION OF HEALTH MITIGATION ACTIVITIES – PROJECT ARBORIST WILL DESIGNATE TREE HEALTH MITIGATION ACTIVITIES BASED UPON THE LEVEL OF ROOT LOSS AND ADVERSE IMPACTS THAT HAVE OCCURRED.

28. MONITORING TREE HEALTH - TREES THAT HAVE BEEN ADVERSELY IMPACTED BY CONSTRUCTION ACTIVITIES ARE NOTED FOR REGULAR VISUAL INSPECTION. PROJECT ARBORIST WILL DIRECT FURTHER MITIGATION. INSECTS AND FUNGAL PATHOGENS ARE A SIGN OF POOR TREE HEALTH (LOW ENERGY RESERVES) AND INDICATE THE NEED FOR HEALTH MITIGATION.

29. MONITORING OF SOIL MOISTURE - MOISTURE SHOULD BE MONITORED BY VISUAL INSPECTION USING A SOIL PROBE OR THROUGH THE USE OF TENSIOMETERS PLACED AT KEY LOCATIONS AND DEPTHS. SUPPLEMENTAL IRRIGATION IS MOST NEEDED DURING SPRING. IN CASES WHERE TREES HAVE SUFFERED ROOT LOSS, SUPPLEMENTAL IRRIGATION MAY BE REQUIRED FOR A NUMBER OF YEARS.

30. MITIGATION OF SOIL COMPACTION - THE LEVEL AND DEPTH OF SOIL COMPACTION MUST BE ASSESSED AND MITIGATED AS NECESSARY. TOOLS THAT ARE MOST SUITABLE FOR MITIGATION OF COMPACTED SOIL ARE THE WATER JET OR AIR SPADE.

31. LANDSCAPING – ALL LANDSCAPING PLANNING MUST TAKE PRECAUTIONS WHEN PLANTING WITHIN THE DESIGNATED RPZ. ALL PLANT MATERIALS SHOULD BE SELECTED FOR COMPATIBILITY WITH THE FAVORED MOISTURE REGIME (HYDROZONE) OF THE TREE SPECIES AND SOIL TEXTURE.

32. CONTINUED MULCHING - MULCH IS EXTREMELY BENEFICIAL IN CREATING A HEALTHY ROOT ENVIRONMENT. A REGULAR PROGRAM OF MULCH APPLICATION IS RECOMMENDED TO HELP RETAIN SOIL MOISTURE, PROVIDE A SOURCE OF NUTRIENTS, AND HELP CONTROL WEEDS.

33. FERTILIZATION -TREES SHOULD BE FERTILIZED ONLY WHEN THE NUTRITIONAL LIMITATIONS HAVE BEEN IDENTIFIED THROUGH LABORATORY ANALYSIS OF SOIL OR PLANT TISSUE. EXCESSIVE NITROGEN FERTILIZATION IS KNOWN TO DRAW SUCKING INSECTS (APHID, SCALE, ETC.) TO THE PLANTS AND PROVIDE NUTRITION TO FUNGAL PATHOGENS IN THE SOIL. PEST MANAGEMENT PROGRAM – HEALTHY TREES DO NOT GENERALLY HAVE SERIOUS PEST PROBLEMS. STRESSED TREES BECOME ATTRACTIVE HOSTS TO PATHOGENS WHICH CAN CONTRIBUTE TO FURTHER DECLINE. PEST MANAGEMENT IS PRESCRIBED WHEN MONITORING INDICATES A


34. ENFORCEMENT OF TREE PROTECTION - CITY OF SANTA CLARA ARBORIST NOTES LIST PENALTIES FOR FAILURE TO COMPLY WITH PROTECTION AND MAINTENANCE OF TREES DESIGNATED TO BE RETAINED.

1. ALL PLANTS DESIGNATED TO BE SAVED SHALL BE PROTECTED BY FENCING, AS


2. INSTALL TREE PROTECTION FENCE AT TREE DRIP LINE OR AT EDGE OF DISTURBED AREA PRIOR TO COMMENCEMENT OF CONSTRUCTION.

3. SPACE TREE PROTECTION ZONE SIGNS A MINIMUM OF ONE EVERY 300 FEET. THE SIZE OF EACH SIGN MUST BE A MINIMUM OF 2' x 2' AND BE VISIBLE FROM BOTH SIDES OF THE SIGN MUST CONTAIN THE FOLLOWING LANGUAGE IN BOTH ENGLISH & SPANISH: "TREE PROTECTION ZONE, KEEP OUT".

3. THERE SHALL BE NO STORAGE OF MATERIAL WITHIN THE BOUNDARIES OF THE TREE

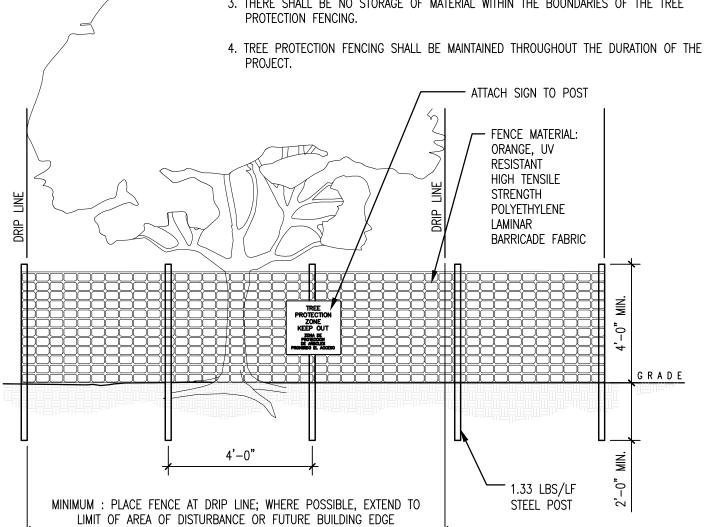

	PROTECTE	D TREES				REPLACEMENT TRI	EES	
NAME	SPECIES	TRUNK DIAMETER (IN)	PRESERVED (Y/N)	PROTECTED TREE TO BE REMOVED		NEW SPECIES	SIZE	QT
860	OLEANDER	9	N	→ 860		KINDRED SPIRIT OAK	24" BOX	2
861	OLEANDER	8	N	861		KINDRED SPIRIT OAK	24" BOX	2
863	OLEANDER	7	N	863		BLUE OAK	24" BOX	2
870	CALIFORNIA BLACK WALNUT	14	N	870		KINDRED SPIRIT OAK	24" BOX	2
871	DEODAR CEDAR	36	Y					
872	ENGLISH WALNUT	8	Y					
873	BOXELDER	8	Υ					
874	DEODAR CEDAR	40	Υ		-			
875	AVOCADO	14	Υ		-			
876	JAPANESE MAPLE	9, 6, 5	Y		-			
877	JAPANESE MAPLE	7, 4, 4, 4, 4,						
878	COAST REDWOOD	4, 4 35	Y					
879	SAUCER MAGNOLIA	15, 10	Υ					
880	ORANGE	14	N	880		KINDRED SPIRIT OAK	24" BOX	2
881	AVOCADO	26	N	881		BLUE OAK	24" BOX	2
882	BLACKWOOD ACACIA	21	N	882	-	BLUE OAK	24" BOX	2
-	BLACKWOOD ACACIA BLACKWOOD ACACIA			′ 	-			
883		16	N N	883		BLUE OAK	24" BOX	2
885	GLOSSY PRIVET	15	N	→ 885		BLUE OAK	24" BOX	2
886	AUSTRALIAN BUSH CHERRY	7, 6, 5, 5	N	886		BLUE OAK	24" BOX	2
887	AUSTRALIAN BUSH CHERRY	14	N	887		BLUE OAK	24" BOX	2
888	AUSTRALIAN BUSH CHERRY	14	N	888		BLUE OAK	24" BOX	2
890	AUSTRALIAN BUSH CHERRY	7	N	890		BLUE OAK	24" BOX	2
891	WEEPING BOTTLE BRUSH	14, 6	N	891		BLUE OAK	24" BOX	2
896	ENGLISH WALNUT	17	N	896		BLUE OAK	24" BOX	2
897	ORANGE	7	Y		_			
899	CHERRY	13	N	899		KINDRED SPIRIT OAK	24" BOX	2
900	ENGLISH WALNUT	17	N	→ <u>900</u>		KINDRED SPIRIT OAK	24" BOX	2
901	ORANGE	7	N	901		KINDRED SPIRIT OAK	24" BOX	2
902	CHINESE ELM	24	Y					
903	CHINESE ELM	26	Υ		•			
904	MONTERREY PINE	34	N	904		BLUE OAK	24" BOX	2
905	RAYWOOD ASH	7	N	905	-	BLUE OAK	24" BOX	2
907	RAYWOOD ASH	10, 12	N	907		BLUE OAK	24" BOX	2
	_				-			
300	RAYWOOD ASH	11	N	908		BLUE OAK	24" BOX	2
910	RAYWOOD ASH	9	N	→ <u>910</u>		BLUE OAK	24" BOX	2
911	RAYWOOD ASH	10	Y					
912	PLUM	30	Y					
913	BOXELDER	20	Y					
914	BOXELDER	20	Υ					
915	BOXELDER	31	Y					
916	TULIP TREE	24	Y]			
917	COAST LIVE OAK	17	N	917	1	BLUE OAK	24" BOX	2
920	ITALIAN CYPRESS	14	Υ					
921	ITALIAN CYPRESS	11	Y		1			
922	ITALIAN CYPRESS	12	Y		†			
923	PLUM	12, 8	Y		1			
				004	-	VINDED COIDIT OAK	04" DOV	0
924	APPLE	15	N	924	•	KINDRED SPIRIT OAK	24" BOX	2
920	PLUM	13	N	926		KINDRED SPIRIT OAK	24" BOX	2
928	CABBAGE PALM	11, 9	N	928		BLUE OAK	24" BOX	2
1 000	RIVER RED GUM	32	N	929		BLUE OAK	24" BOX	2
929	SILVER DOLLAR GUM	21	N	931		BLUE OAK	24" BOX	2
931		36	N	932		BLUE OAK	24" BOX	2
	RIVER RED GUM		N.	937		BLUE OAK	24" BOX	2
931		24	N	0.70	1	BLUE OAK	24" BOX	2
931 932	RIVER RED GUM		N N	→ 938			Z T DU/\ '	_
931 932 937 938	RIVER RED GUM RIVER RED GUM CABBAGE PALM	24 50	N	′ 	•			2
931 932 937 938 939	RIVER RED GUM RIVER RED GUM CABBAGE PALM SOUTHERN MAGNOLIA	24 50 30	N N	939		BLUE OAK	24" BOX	
931 932 937 938 939 940	RIVER RED GUM RIVER RED GUM CABBAGE PALM SOUTHERN MAGNOLIA COAST LIVE OAK	24 50 30 27	N N N	′ 				
931 932 937 938 939 940 941	RIVER RED GUM RIVER RED GUM CABBAGE PALM SOUTHERN MAGNOLIA COAST LIVE OAK COAST LIVE OAK	24 50 30 27 26	N N N Y	939		BLUE OAK	24" BOX	
931 932 937 938 939 940 941 942	RIVER RED GUM RIVER RED GUM CABBAGE PALM SOUTHERN MAGNOLIA COAST LIVE OAK COAST LIVE OAK SOUTHERN MAGNOLIA	24 50 30 27 26 26	N N N Y Y	939	-	BLUE OAK	24" BOX	
931 932 937 938 939 940 941 942 943	RIVER RED GUM RIVER RED GUM CABBAGE PALM SOUTHERN MAGNOLIA COAST LIVE OAK COAST LIVE OAK SOUTHERN MAGNOLIA SOUTHERN MAGNOLIA	24 50 30 27 26 26 23	N N N Y Y	939		BLUE OAK	24" BOX	2 2
931 932 937 938 939 940 941 942 943	RIVER RED GUM RIVER RED GUM CABBAGE PALM SOUTHERN MAGNOLIA COAST LIVE OAK COAST LIVE OAK SOUTHERN MAGNOLIA SOUTHERN MAGNOLIA COAST REDWOOD	24 50 30 27 26 26 23 30	N N N Y Y	939 940		BLUE OAK BLUE OAK	24" BOX 24" BOX	2
931 932 937 938 939 940 941 942 943 944	RIVER RED GUM RIVER RED GUM CABBAGE PALM SOUTHERN MAGNOLIA COAST LIVE OAK COAST LIVE OAK SOUTHERN MAGNOLIA SOUTHERN MAGNOLIA COAST REDWOOD VICTORIAN BOX	24 50 30 27 26 26 23 30 17, 15	N N N Y Y Y	939 940 947		BLUE OAK BLUE OAK KINDRED SPIRIT OAK	24" BOX 24" BOX 24" BOX	2
931 932 937 938 939 940 941 942 943	RIVER RED GUM RIVER RED GUM CABBAGE PALM SOUTHERN MAGNOLIA COAST LIVE OAK COAST LIVE OAK SOUTHERN MAGNOLIA SOUTHERN MAGNOLIA COAST REDWOOD	24 50 30 27 26 26 23 30	N N N Y Y	939 940		BLUE OAK BLUE OAK	24" BOX 24" BOX	2

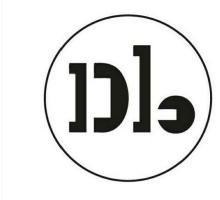

David Baker Architects

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3016 FILBERT street DAKLAND, CA 94608

Issuances Date Description

Revisions Rev. Description Date


Design Update -February 2024

Drawing Title

Tree Protection and Removals List and Notes


27 February, 2024 Date 21620 Project No.



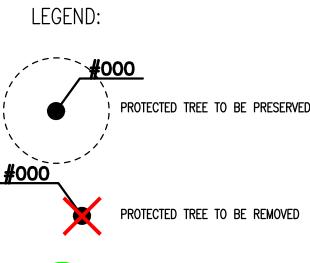



NEW REPLACEMENT TREE

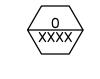

TREE QUANTITY IN AREA TREE SPECIES KEY, REFER TO PLANT LIST FOR TREE SPECIES

NOTES:


- 1. FOR LANDSCAPE MATERIALS, REFER TO SITE
- PLAN.

 2. FOR FULL PLANT LIST, REFER TO LANDSCAPE SCHEDULES.

 3. FOR TREE PRESERVATION LIST, REFER TO TREE PROTECTION AND REMOVALS LIST.

PLANT	LIST	
TREES		
KEY	SYMBOL	COMMON NAME
	and the state of t	PROTECTED TREE
FRAM		WHITE ASH
ARMA	\odot	MARINA STRAWBERRY TREE
QUDO	+	BLUE OAK
PIXR	\bigcirc	RED PUSH PISTACHE
QUKI	\odot	KINDRED SPIRIT OAK
PAPE	The second secon	IRONWOOD

Woodland Park Euclid Improvements

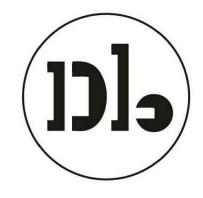

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Revisions Date Rev. Description

Set Title

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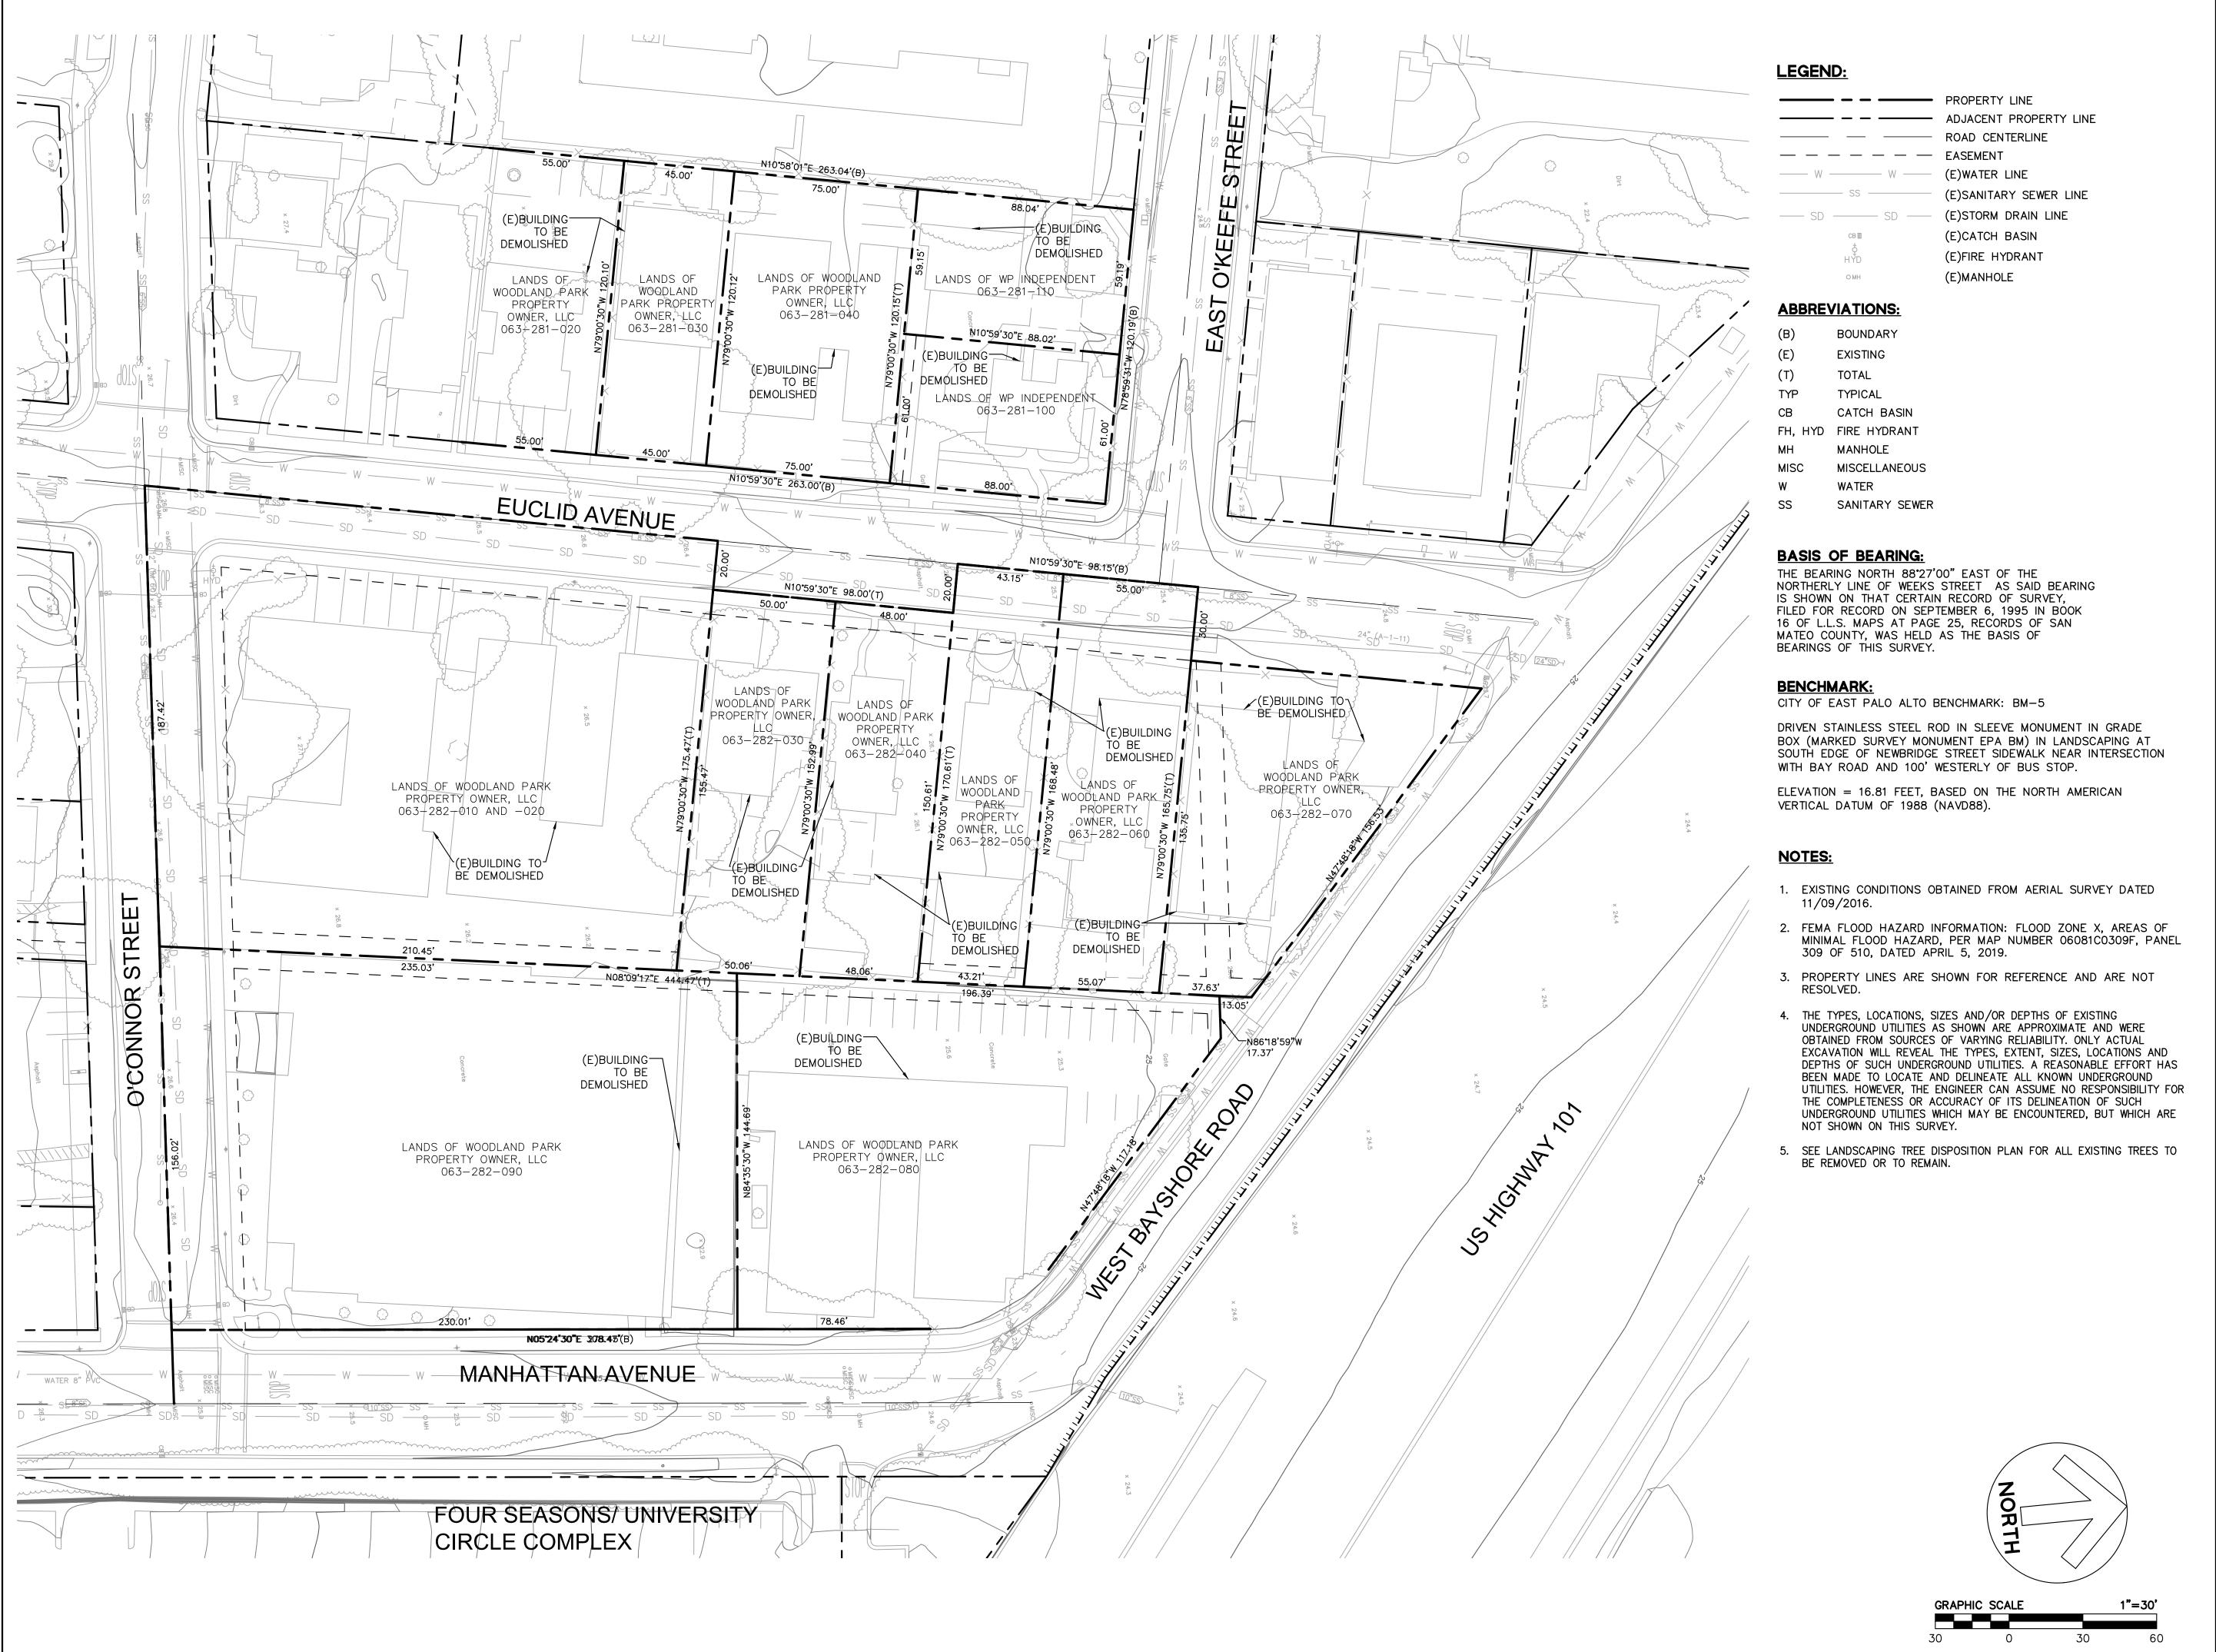
Drawing Title

Tree Protection & Removal Plan

T-1.1

27 February, 2024 21620 Project No.

TREE PROTECTION AND REMOVALS (TPR) PLAN SCALE: 1" = 30'



Euclid Improvements



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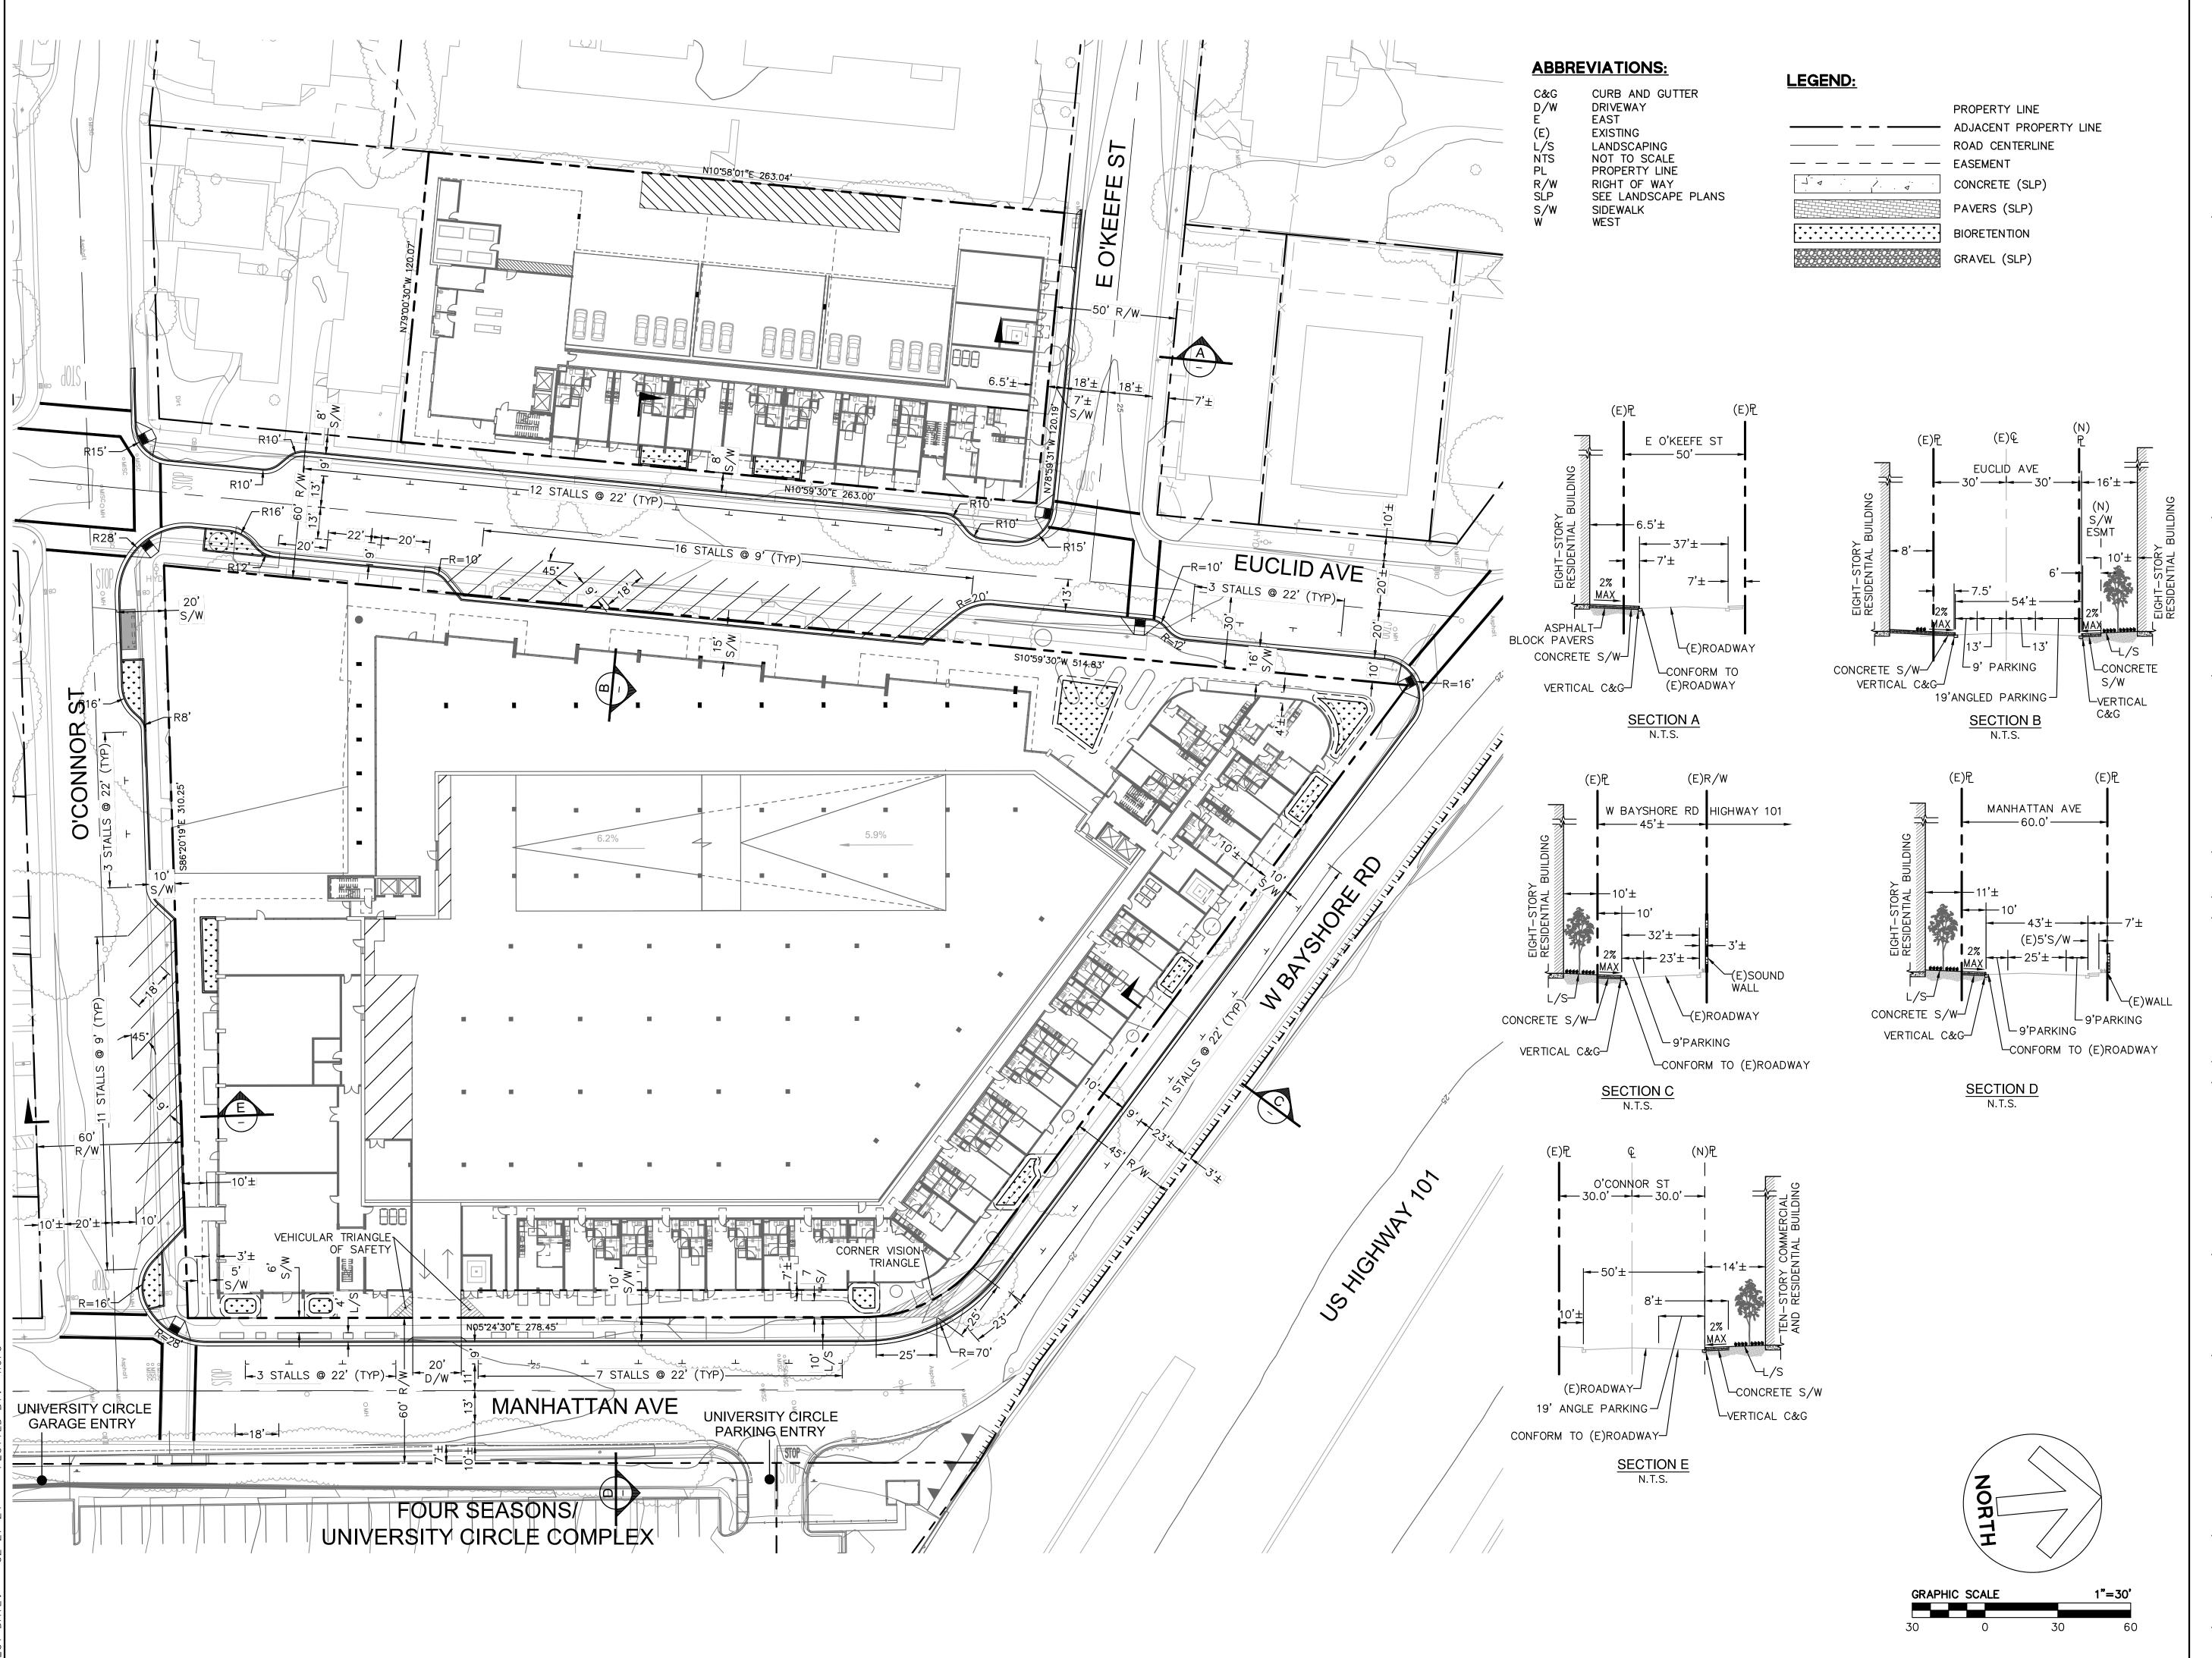
		Revisions
Rev.	Description	Date

Design Update -February 2024

Drawing Title

EXISTING CONDITIONS AND DEMOLITION PLAN

Sheet No.



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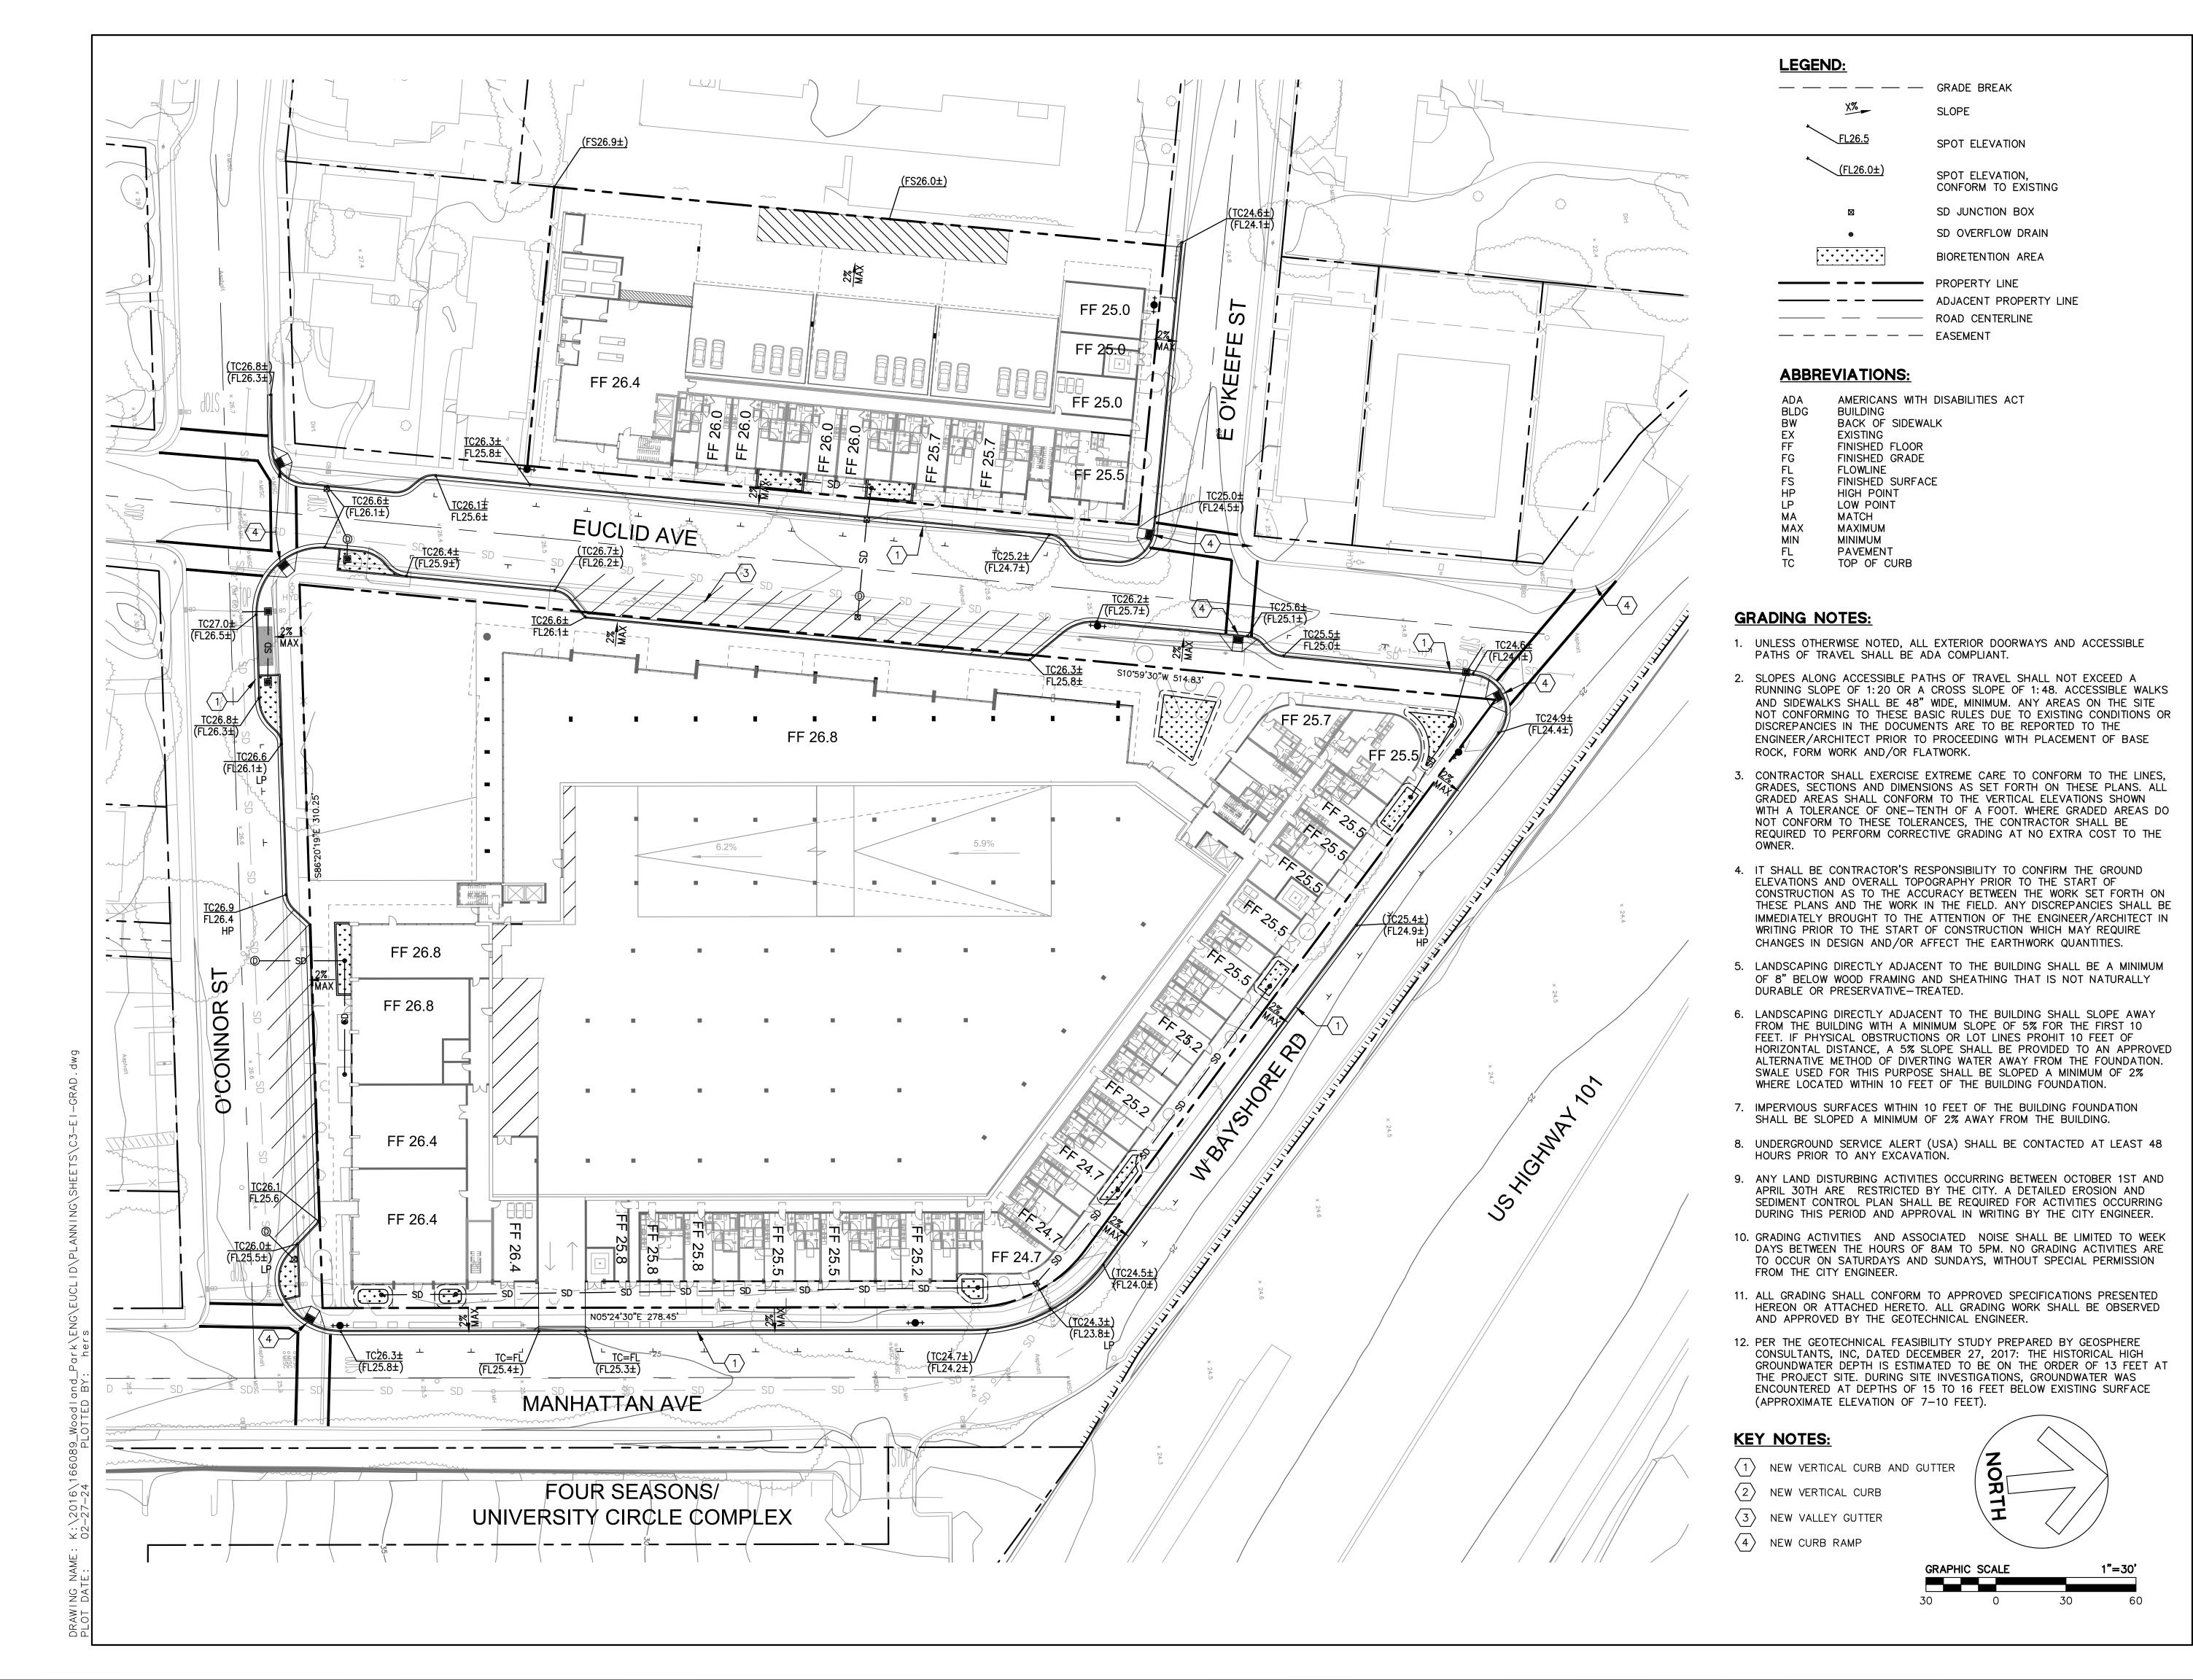
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Rev.	Description	Date

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Drawing Title

PRELIMINARY SITE PLAN

C2.0



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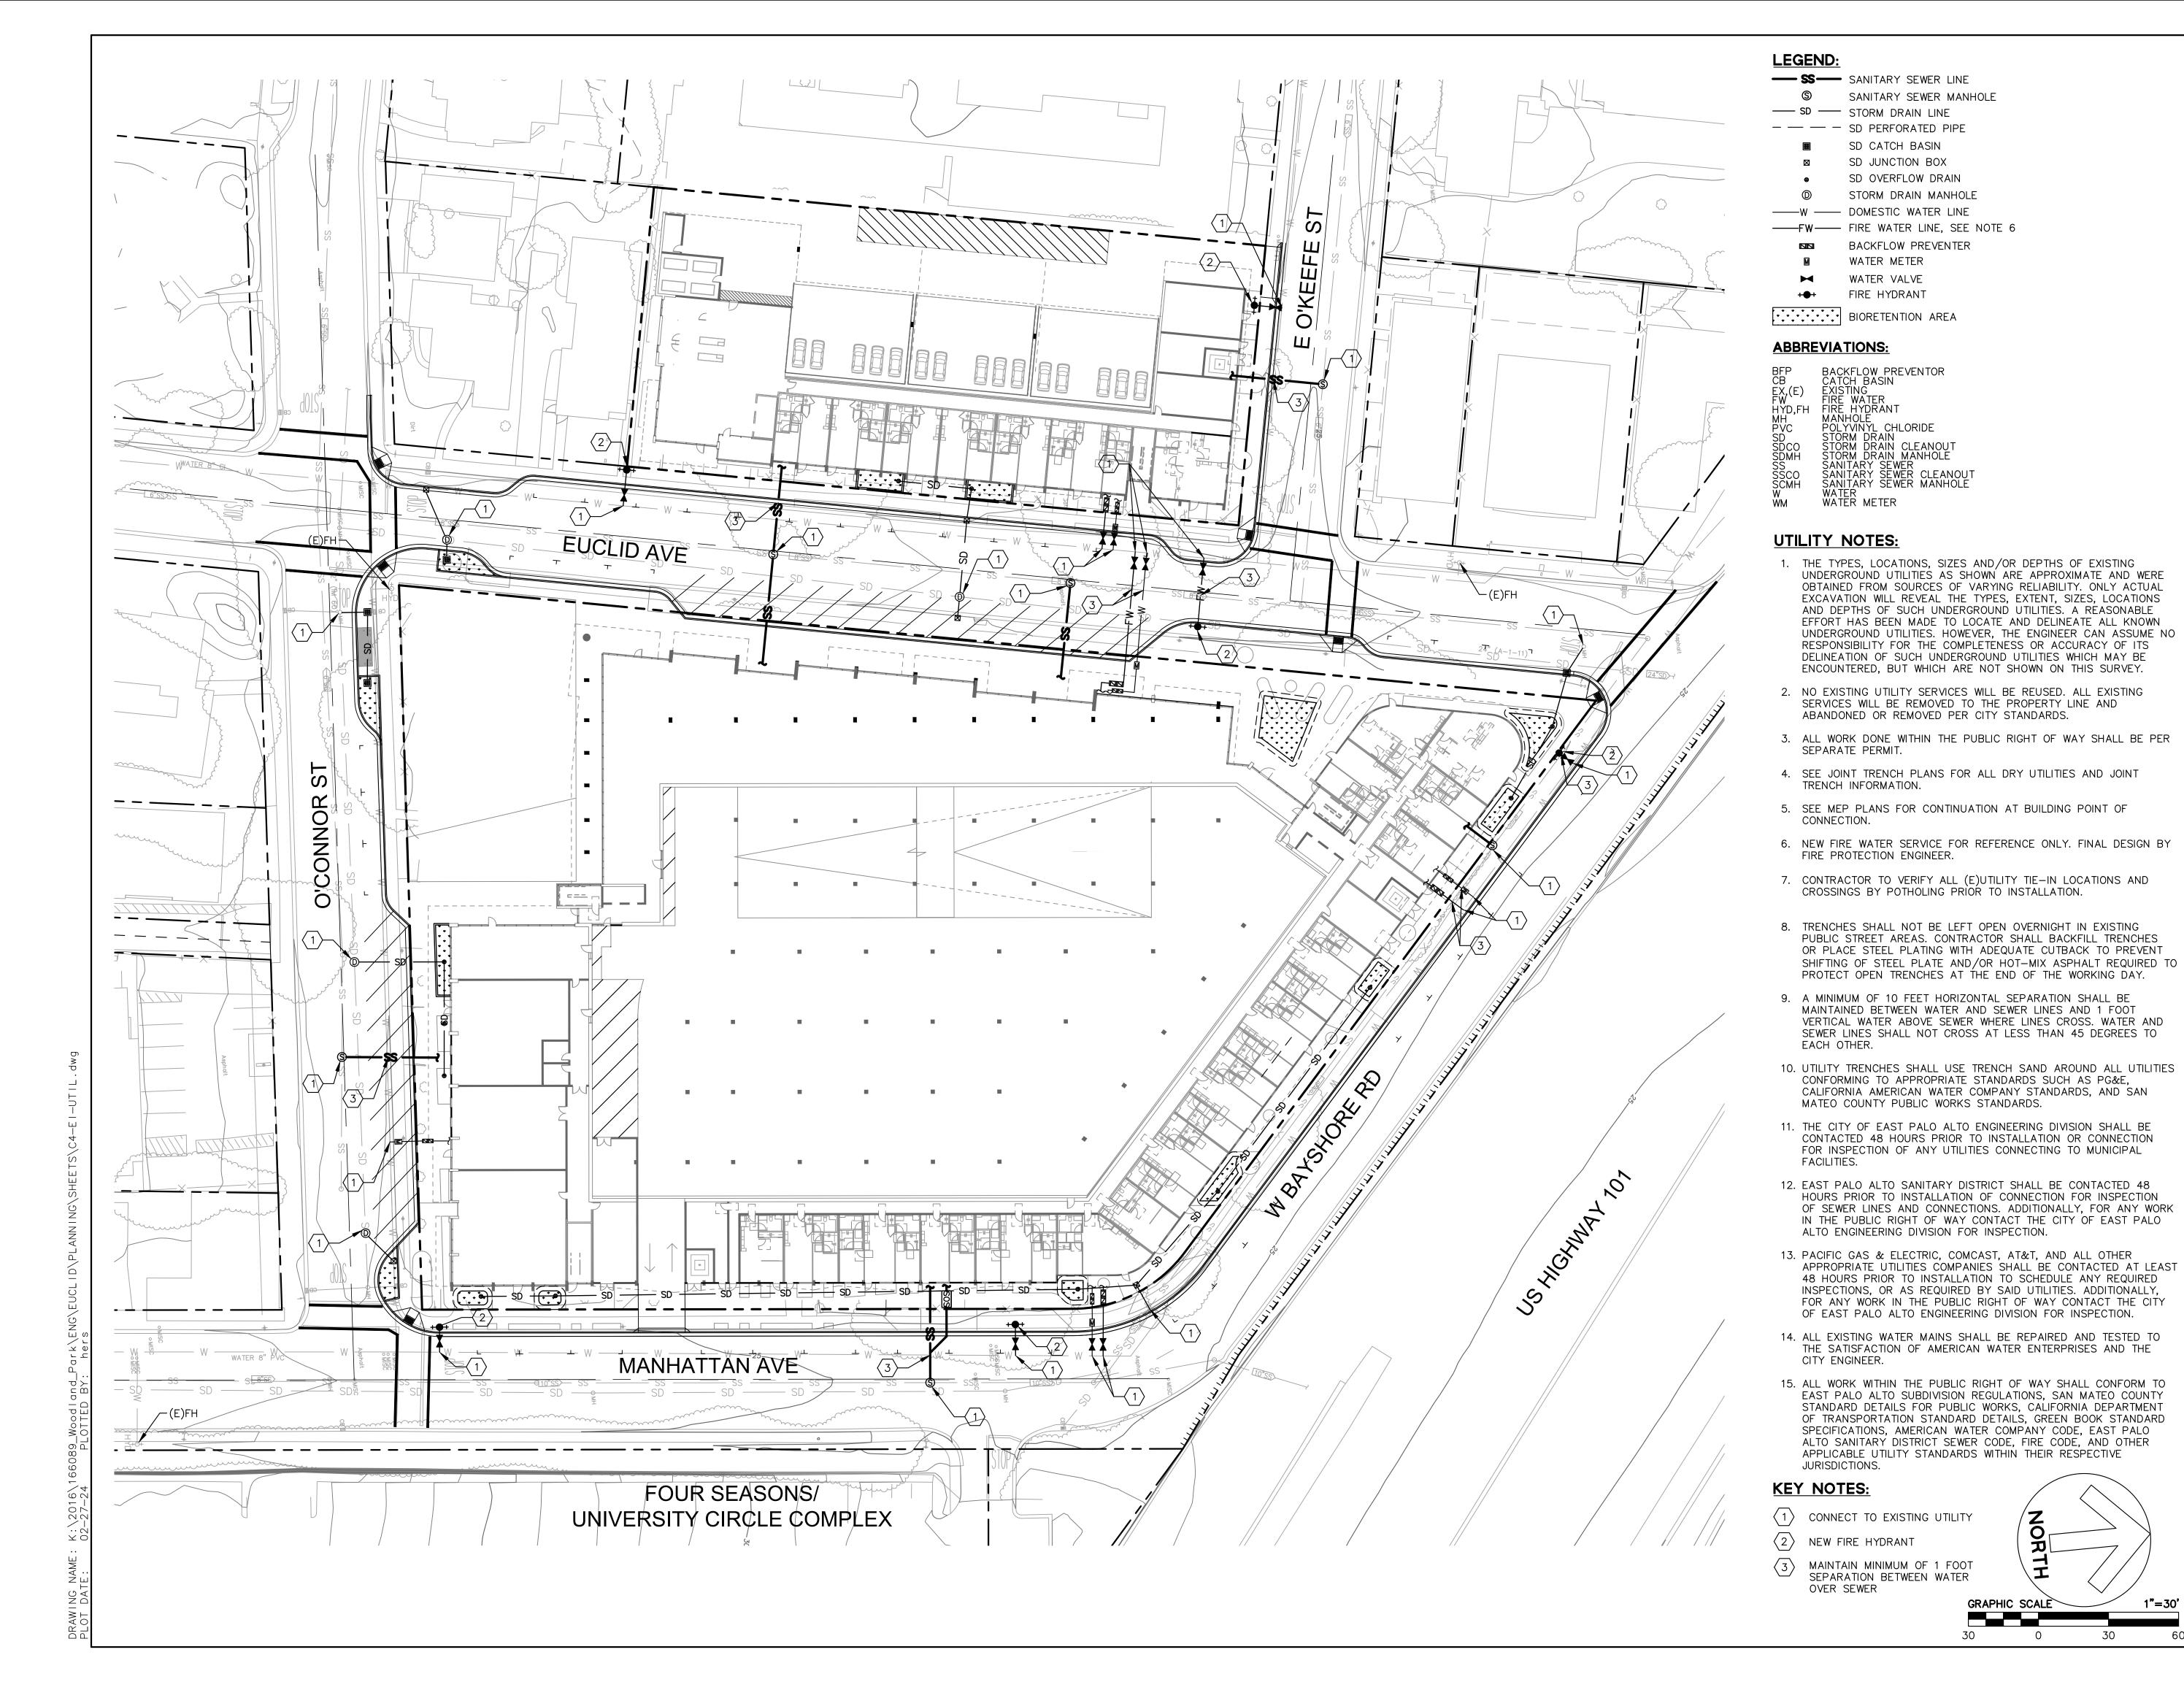
Design Update -February 2024

Drawing Title


PRELIMINARY GRADING AND DRAINAGE PLAN

Sheet No.

Date 2024-02-27
Project No. 20166089-20



Euclid

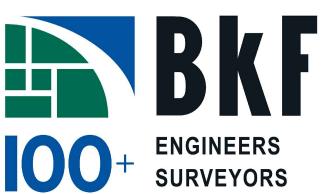

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		Revisions
٠V.	Description	Date

Design Update -

PRELIMINARY UTILITY PLAN

C4.0

Date 20166089-20 Project No.

1"=30'

Woodland Park

Improvements

PLANNERS YEARS

Set Title February 2024

Drawing Title

2024-02-27



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Drawing Title

PRELIMINARY STORMWATER MANAGEMENT PLAN

C5.0

TREATMENT CONTROL MEASURE SUMMARY						
DRAINAGE	DRAINAGE AREA	PROPOSED			MEASURE SIZE	TREATMENT MEASURE TYPE
AREAS	SIZE (SF)	PERVIOUS SURFACE (SF)	IMPERVIOUS SURFACE (SF)	REQUIRED (SF)	PROVIDED (SF)	TREATMENT MEASURE TIPE
DMA-1	6,039	LANDSCAPE 244	ROOF/SIDEWALK 5,795	232	244	STRUCTURAL BIORETENTION AREA
DMA-2	3,107	LANDSCAPE 93	ROOF/SIDEWALK 3,014	121	136	STRUCTURAL BIORETENTION AREA
DMA-3	3,107	LANDSCAPE 102	ROOF/SIDEWALK 3,005	120	137	STRUCTURAL BIORETENTION AREA
DMA-4	6,752	LANDSCAPE 229	ROOF/SIDEWALK 6,523	196*	229	STRUCTURAL BIORETENTION AREA
DMA-5	4,316	LANDSCAPE 129	ROOF/SIDEWALK 4,187	126*	129	STRUCTURAL BIORETENTION AREA
DMA-6	8,275	LANDSCAPE 640	ROOF/SIDEWALK 7,635	N/A	N/A	PERMEABLE PAVERS
DMA-7	8,920	LANDSCAPE 8,920	ROOF/SIDEWALK O	N/A	N/A	PARK: SELF—TREATING AREA
DMA-8	4,473	LANDSCAPE 210	ROOF/SIDEWALK 4,263	171	173	STRUCTURAL BIORETENTION AREA
DMA-9	10,416	LANDSCAPE 510	ROOF/SIDEWALK O	396	396	STRUCTURAL BIORETENTION AREA
DMA-10	1,819	LANDSCAPE 230	ROOF/SIDEWALK 1,589	64	73	NON-STRUCTURAL BIORETENTION AREA
DMA-11	1,433	LANDSCAPE 134	ROOF/SIDEWALK 1,299	52	53	NON-STRUCTURAL BIORETENTION AREA
DMA-12	5,479	LANDSCAPE 240	ROOF/SIDEWALK 5,239	210	231	STRUCTURAL BIORETENTION AREA
DMA-13	5,174	LANDSCAPE 204	ROOF/SIDEWALK 4,970	199	204	STRUCTURAL BIORETENTION AREA
DMA-14	6,482	LANDSCAPE 247	ROOF/SIDEWALK 6,233	249	249	STRUCTURAL BIORETENTION AREA
DMA-15	2,038	LANDSCAPE 390	ROOF/SIDEWALK 1,648	66	70	NON-STRUCTURAL BIORETENTION AREA
DMA-16	3,295	LANDSCAPE 70	ROOF/SIDEWALK 3,225	129	129	STRUCTURAL BIORETENTION AREA
DMA-17	4,865	LANDSCAPE 168	ROOF/SIDEWALK 4,697	142*	168	STRUCTURAL BIORETENTION AREA
DMA-18	2,035	LANDSCAPE 110	ROOF/SIDEWALK 1,925	77	86	NON-STRUCTURAL BIORETENTION AREA
DMA-19	2,800	LANDSCAPE 115	ROOF/SIDEWALK 2,685	107	115	NON-STRUCTURAL BIORETENTION AREA
DMA-20	4,078	LANDSCAPE 90	ROOF/SIDEWALK 3,988	160	180	NON-STRUCTURAL BIORETENTION AREA
DMA-21	10,930	LANDSCAPE 510	ROOF/SIDEWALK 10,420	417	434	NON-STRUCTURAL BIORETENTION AREA
DMA-22	7,464	LANDSCAPE 300	ROOF/SIDEWALK 7,164	287	300	STRUCTURAL BIORETENTION AREA
DMA-23	7,403	LANDSCAPE 285	ROOF/SIDEWALK 7,118	284	285	STRUCTURAL BIORETENTION AREA
DMA-24	7,782	LANDSCAPE 298	ROOF/SIDEWALK 7,484	299	299	STRUCTURAL BIORETENTION AREA
DMA-25	8,382	LANDSCAPE 324	ROOF/SIDEWALK 8,058	322	324	STRUCTURAL BIORETENTION AREA
DMA-26	13,907	LANDSCAPE 4,170	ROOF/SIDEWALK 9,737	390	390	STRUCTURAL BIORETENTION AREA
TOTAL	148,771	18,962	129,809	4,816	5,034	

NOTES

1) TREATMENT AREAS WERE SIZED USING THE "4 PERCENT METHOD" FLOW—BASED SIZING CRITERIA IN THE 2014 SAN MATEO COUNTY C.3 STORMWATER TECHNICAL GUIDANCE HANDBOOK, UNLESS THE REQUIRED SF IS FOLLOWED BY AN ASTERISK "*". IF REQUIRED SF HAS AN ASTERISK, TREATMENT IS SIZED USING THE COMBINED FLOW METHOD AND AT A MIN. PROVIDES AN EQUIVALENT OF 6—INCHES OF STORED RUNOFF IN SURFACE PONDING AREA.

Woodland Park

Euclid Improvements



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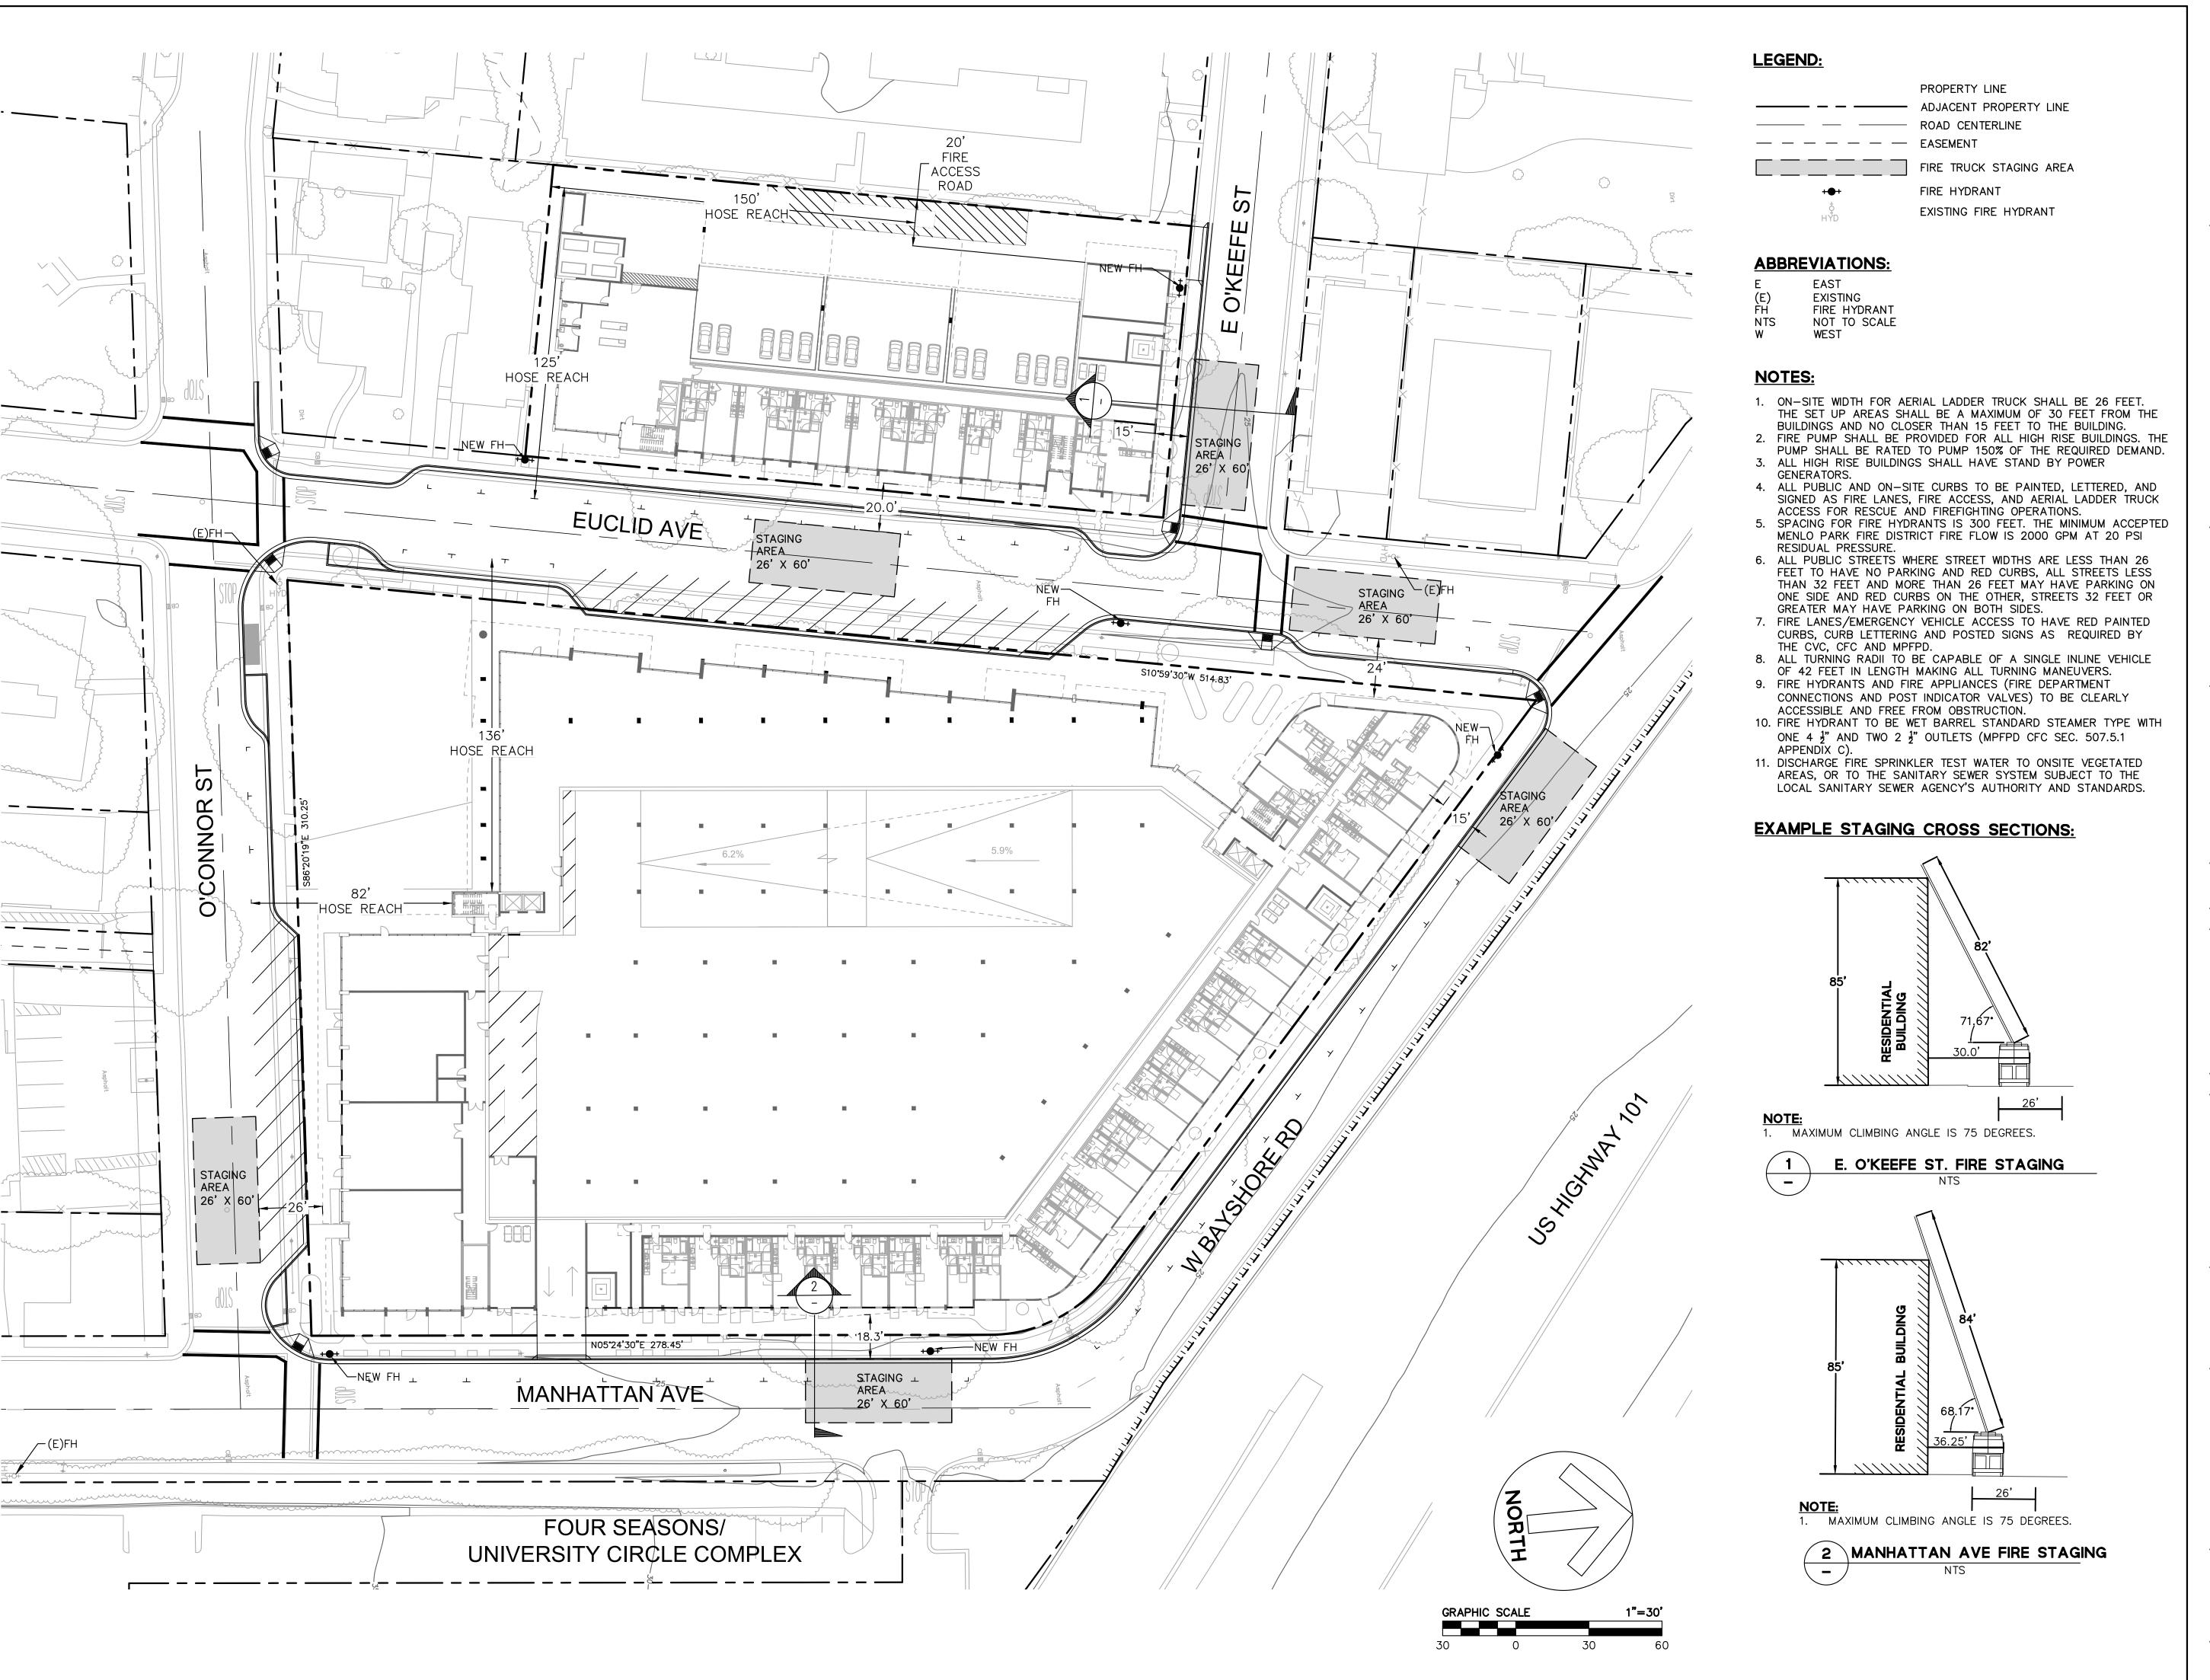
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PRELIMINARY STORMWATER MANAGEMENT PLAN

Sheet No.

C5.1



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		Revisions
Rev.	Description	Date

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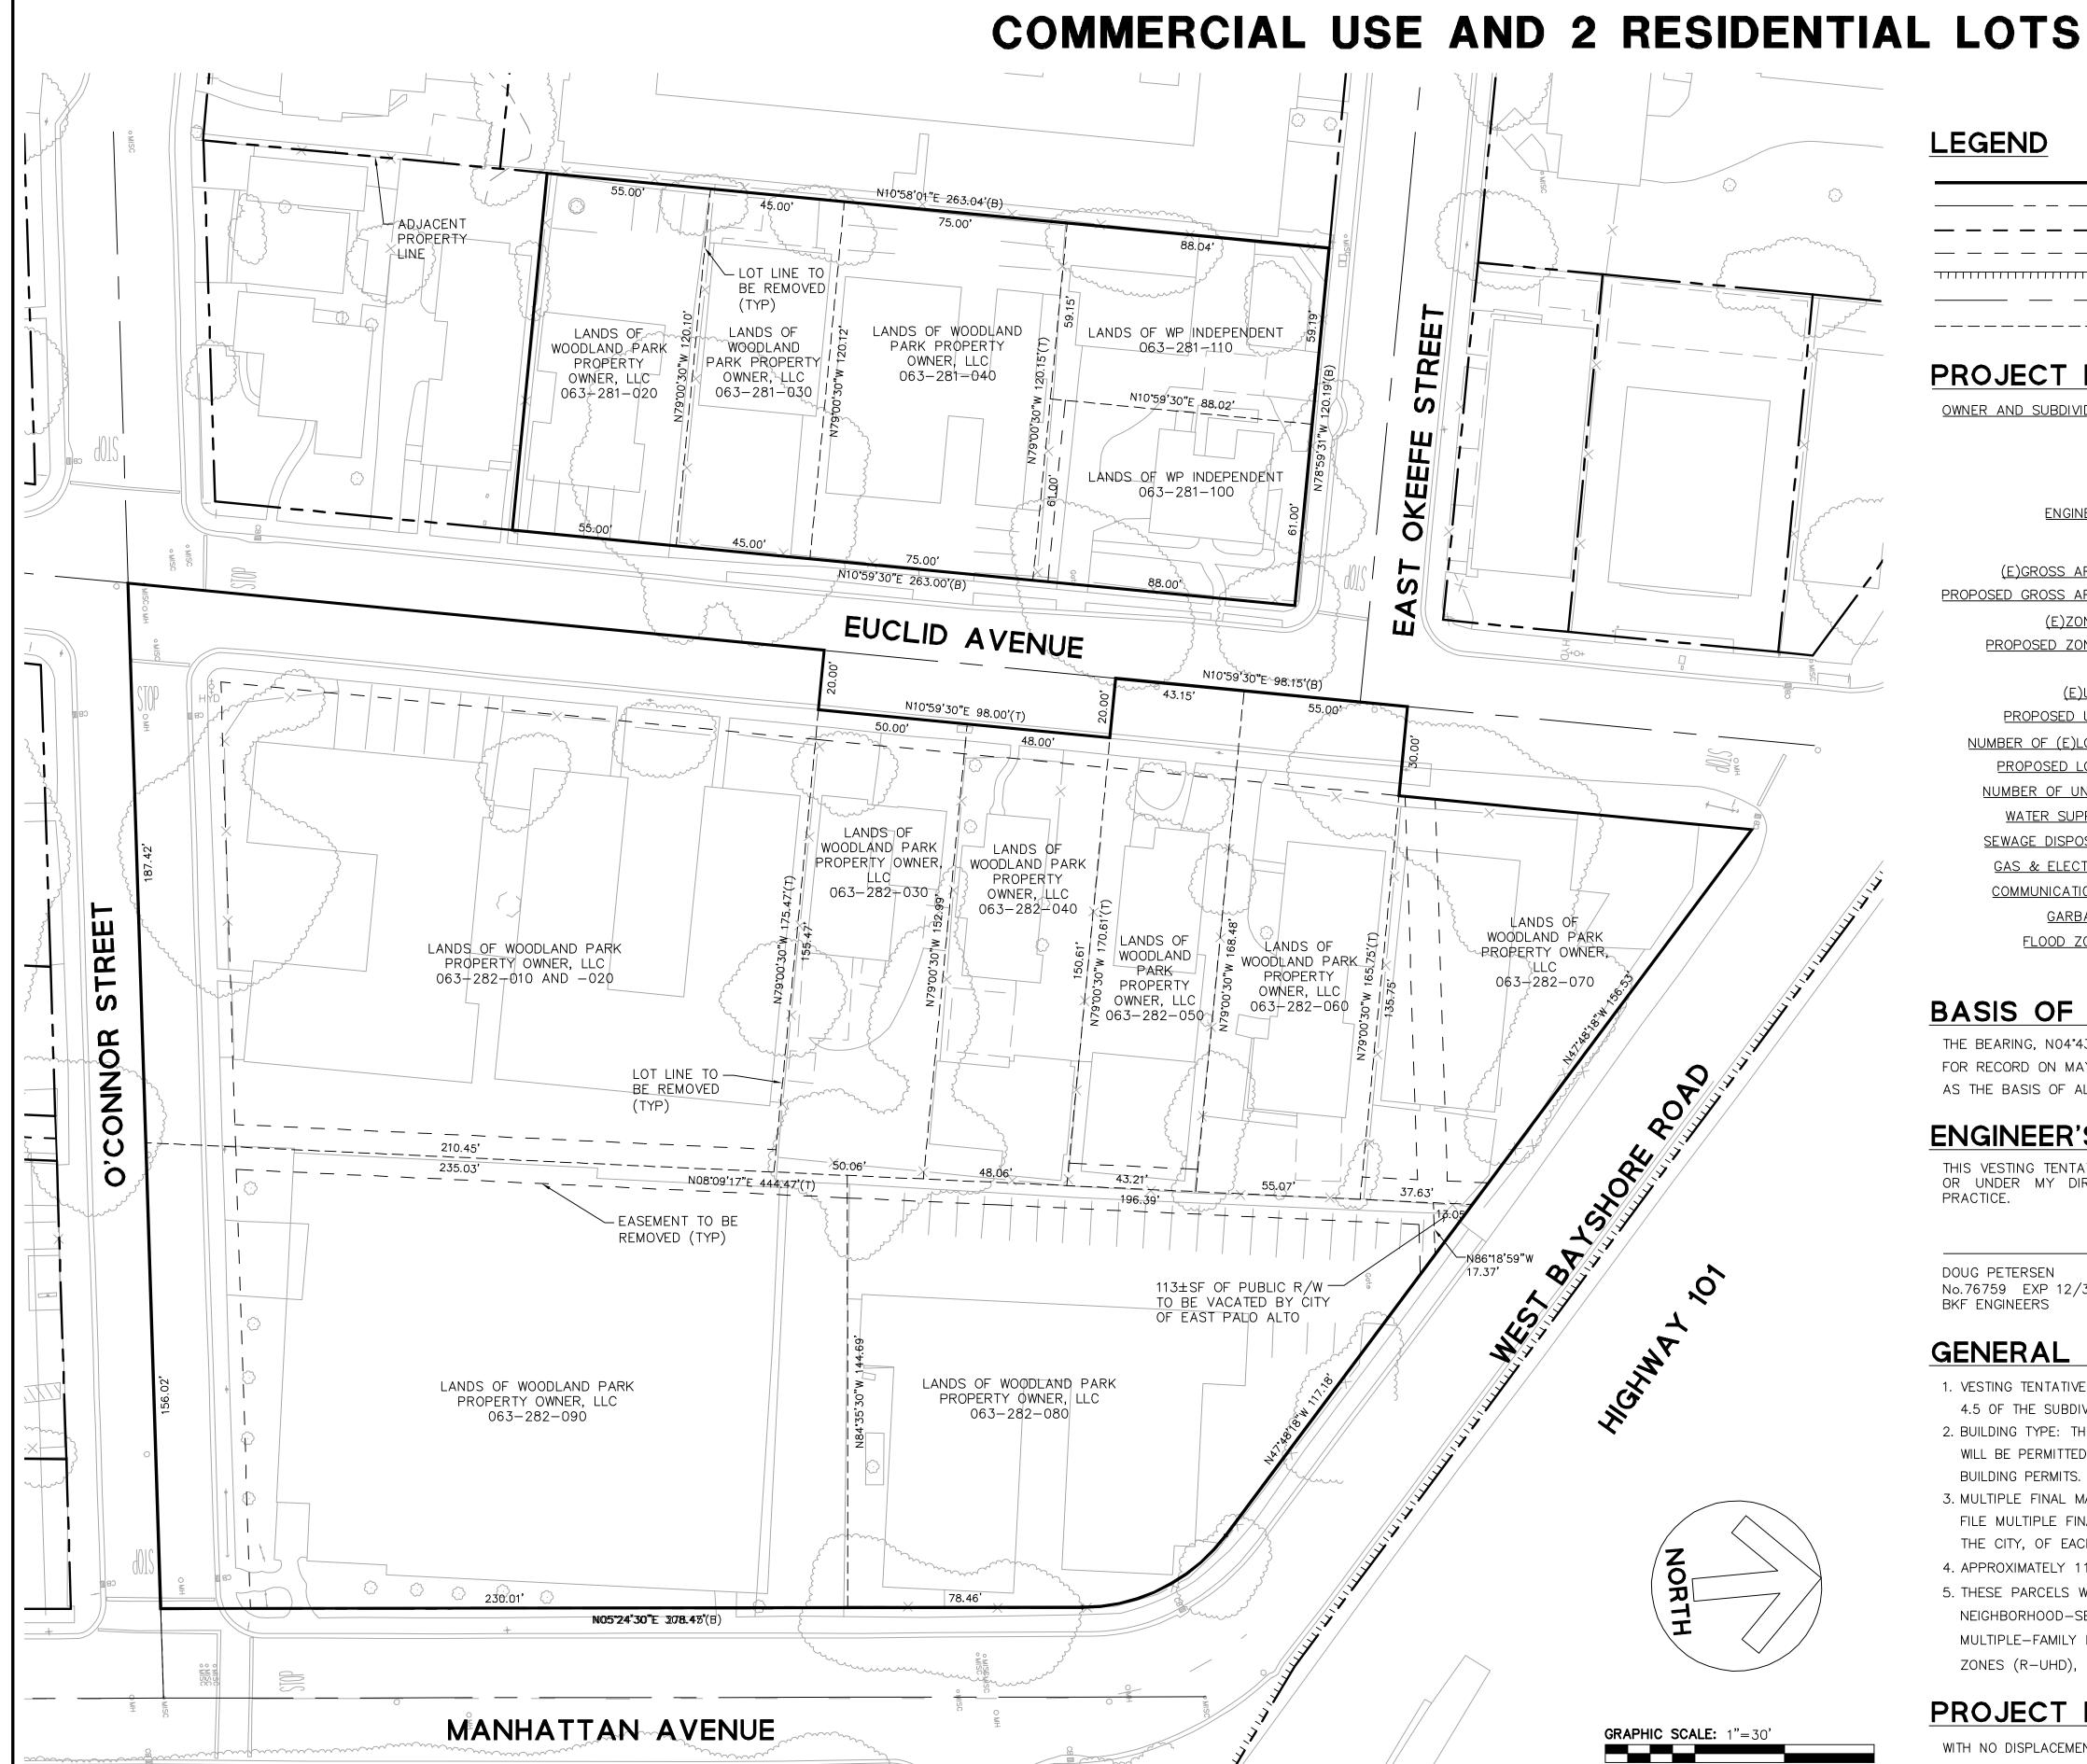
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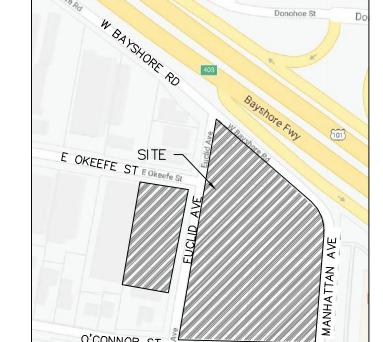
PRELIMINARY FIRE ACCESS PLAN

Sheet No.

C6.0

EAST PALO ALTO, SAN MATEO COUNTY, CA CONSISTING OF 1 VERTICAL AIRSPACE LOT FOR





NTS



ABBREVIATIONS

EXISTING NOT TO SCALE RIGHT OF WAY SQUARE FEET

INDEX

TITLE SHEET MAPPING SHEET

TYPICAL

BASIS OF BEARING

GARBAGE:

FLOOD ZONE:

LEGEND

PROJECT DATA

(E)GROSS AREA:

PROPOSED ZONES:

PROPOSED USE:

PROPOSED LOTS:

<u>NUMBER OF UNITS:</u>

GAS & ELECTRIC:

COMMUNICATIONS:

NUMBER OF (E)LOTS:

(E)USE:

PROPOSED GROSS AREA

THE BEARING, NO4°43'36"E, TAKEN ON THE CENTERLINE OF MANHATTAN AVENUE AS SHOWN ON THAT CERTAIN PARCEL MAP FILED FOR RECORD ON MAY 17TH, 2000 IN BOOK 72 OF PARCEL MAPS AT PAGES 70-75, SAN MATEO COUNTY RECORDS, WAS TAKEN AS THE BASIS OF ALL BEARINGS SHOWN HEREON

ENGINEER'S STATEMENT

THIS VESTING TENTATIVE PARCEL MAP SUBMITTAL HAS BEEN PREPARED BY ME OR UNDER MY DIRECTION IN ACCORDANCE WITH STANDARD ENGINEERING

PROJECT BOUNDARY LINE ADJACENT PROPERTY LINE

(E)EASEMENT TO BE QUITCLAIMED

(E)LOT LINE TO BE REMOVED

WOODLAND PARK PROPERTY OWNER, LLC

RELINQUISHMENT OF ABUTTERS RIGHTS

(E)EASEMENT

CENTERLINE

AND WP INDEPENDENT, LLC

CONTACT: MICHAEL KRAMER

1730 N. FIRST STREET, SUIT 600

R-HD-5 AND R-UHD WITH OVERLAY

965 PAGE MILL ROAD PALO ALTO, CA, 94304

SAN JOSE, CA 95112

R-HD-5 AND R-UHD

(SEE GENERAL NOTE 5)

RESIDENTIAL/COMMERCIAL

AMERICAN WATER SERVICES

PACIFIC GAS AND ELECTRIC

AT&T, COMCAST

RECOLOGY

EAST PALO ALTO SANITARY SEWER DISTRICT

06081C0309F EFFECTIVE 4/5/2019.

ZONE X, AREA OF MINIMAL FLOOD HAZARD PER MAP

BKF ENGINEERS

± 3.92 ACRES

± 3.93 ACRES

RESIDENTIAL

DOUG PETERSEN No.76759 EXP 12/31/24 BKF ENGINEERS

GENERAL NOTES


- 1. VESTING TENTATIVE MAP: THIS VESTING TENTATIVE MAP IS BEING FILED IN ACCORDANCE WITH ARTICLE 2, SECTION 86452 AND CHAPTER 4.5 OF THE SUBDIVISION ACT MAP.
- 2. BUILDING TYPE: THE BUILDING FOOTPRINTS SHOWN ARE FOR CONCEPTUAL PURPOSES ONLY. THE BUILDING TYPE, LOCATION AND STYLES WILL BE PERMITTED AS CONSTRUCTED IN CONFORMANCE WITH PROJECT PLANNING REQUIREMENTS PRIOR TO THE APPLICATION FOR BUILDING PERMITS.
- 3. MULTIPLE FINAL MAPS: PURSUANT TO SECTION 66456.1 OF THE SUBDIVISION MAP ACT, THE DEVELOPER RESERVES THE RIGHT TO FILE MULTIPLE FINAL MAPS. ONLY THE IMPROVEMENTS REQUIRED TO SUPPORT THE LEVEL OF DEVELOPMENT, AS DETERMINED BY THE CITY, OF EACH PARTICULAR FINAL MAP NEEDS TO BE COMPLETED OR BOUNDED.
- 4. APPROXIMATELY 113 SF OF PUBLIC R/W ON WEST BAYSHORE ROAD TO BE VACATED BY THE CITY OF EAST PALO ALTO.
- 5. THESE PARCELS WILL BE PART OF A NEW NEIGHBORHOOD CENTER RESIDENTIAL OVERLAY (NCO) TO AUTHORIZE GROUND-FLOOR NEIGHBORHOOD-SERVING COMMERCIAL AND COMMUNITY USES AND ADDITONAL HOUSING UNITS IN SELECT PORTIONS OF THE MULTIPLE-FAMILY HIGH DENSITY RESIDENTIAL ZONE (R-HD-5) AND THE MULTIPLE-FAMILY URBAN HIGH DENSITY RESIDENTIALZONES (R-UHD),

PROJECT DESCRIPTION

WITH NO DISPLACEMENT, THIS PROJECT PROPOSES THE REPLACEMENT OF SEVERAL AGING, OUTDATED STRUCTURES CONTAINING 160 RENT-STABILIZED HOUSING UNITS AND ONE SINGLE FAMILY RENTAL (NON-RSO) WITH NEW MIXED-INCOME BUILDINGS CONTAINING 605 APARTMENTS, 26% OF WHICH WILL BE DEED-RESTRICTED RENT-CONTROLLED, REPLACING THE EXISTING APARTMENTS ONE-FOR-ONE.


PARCEL MENTS

Drawing Number:

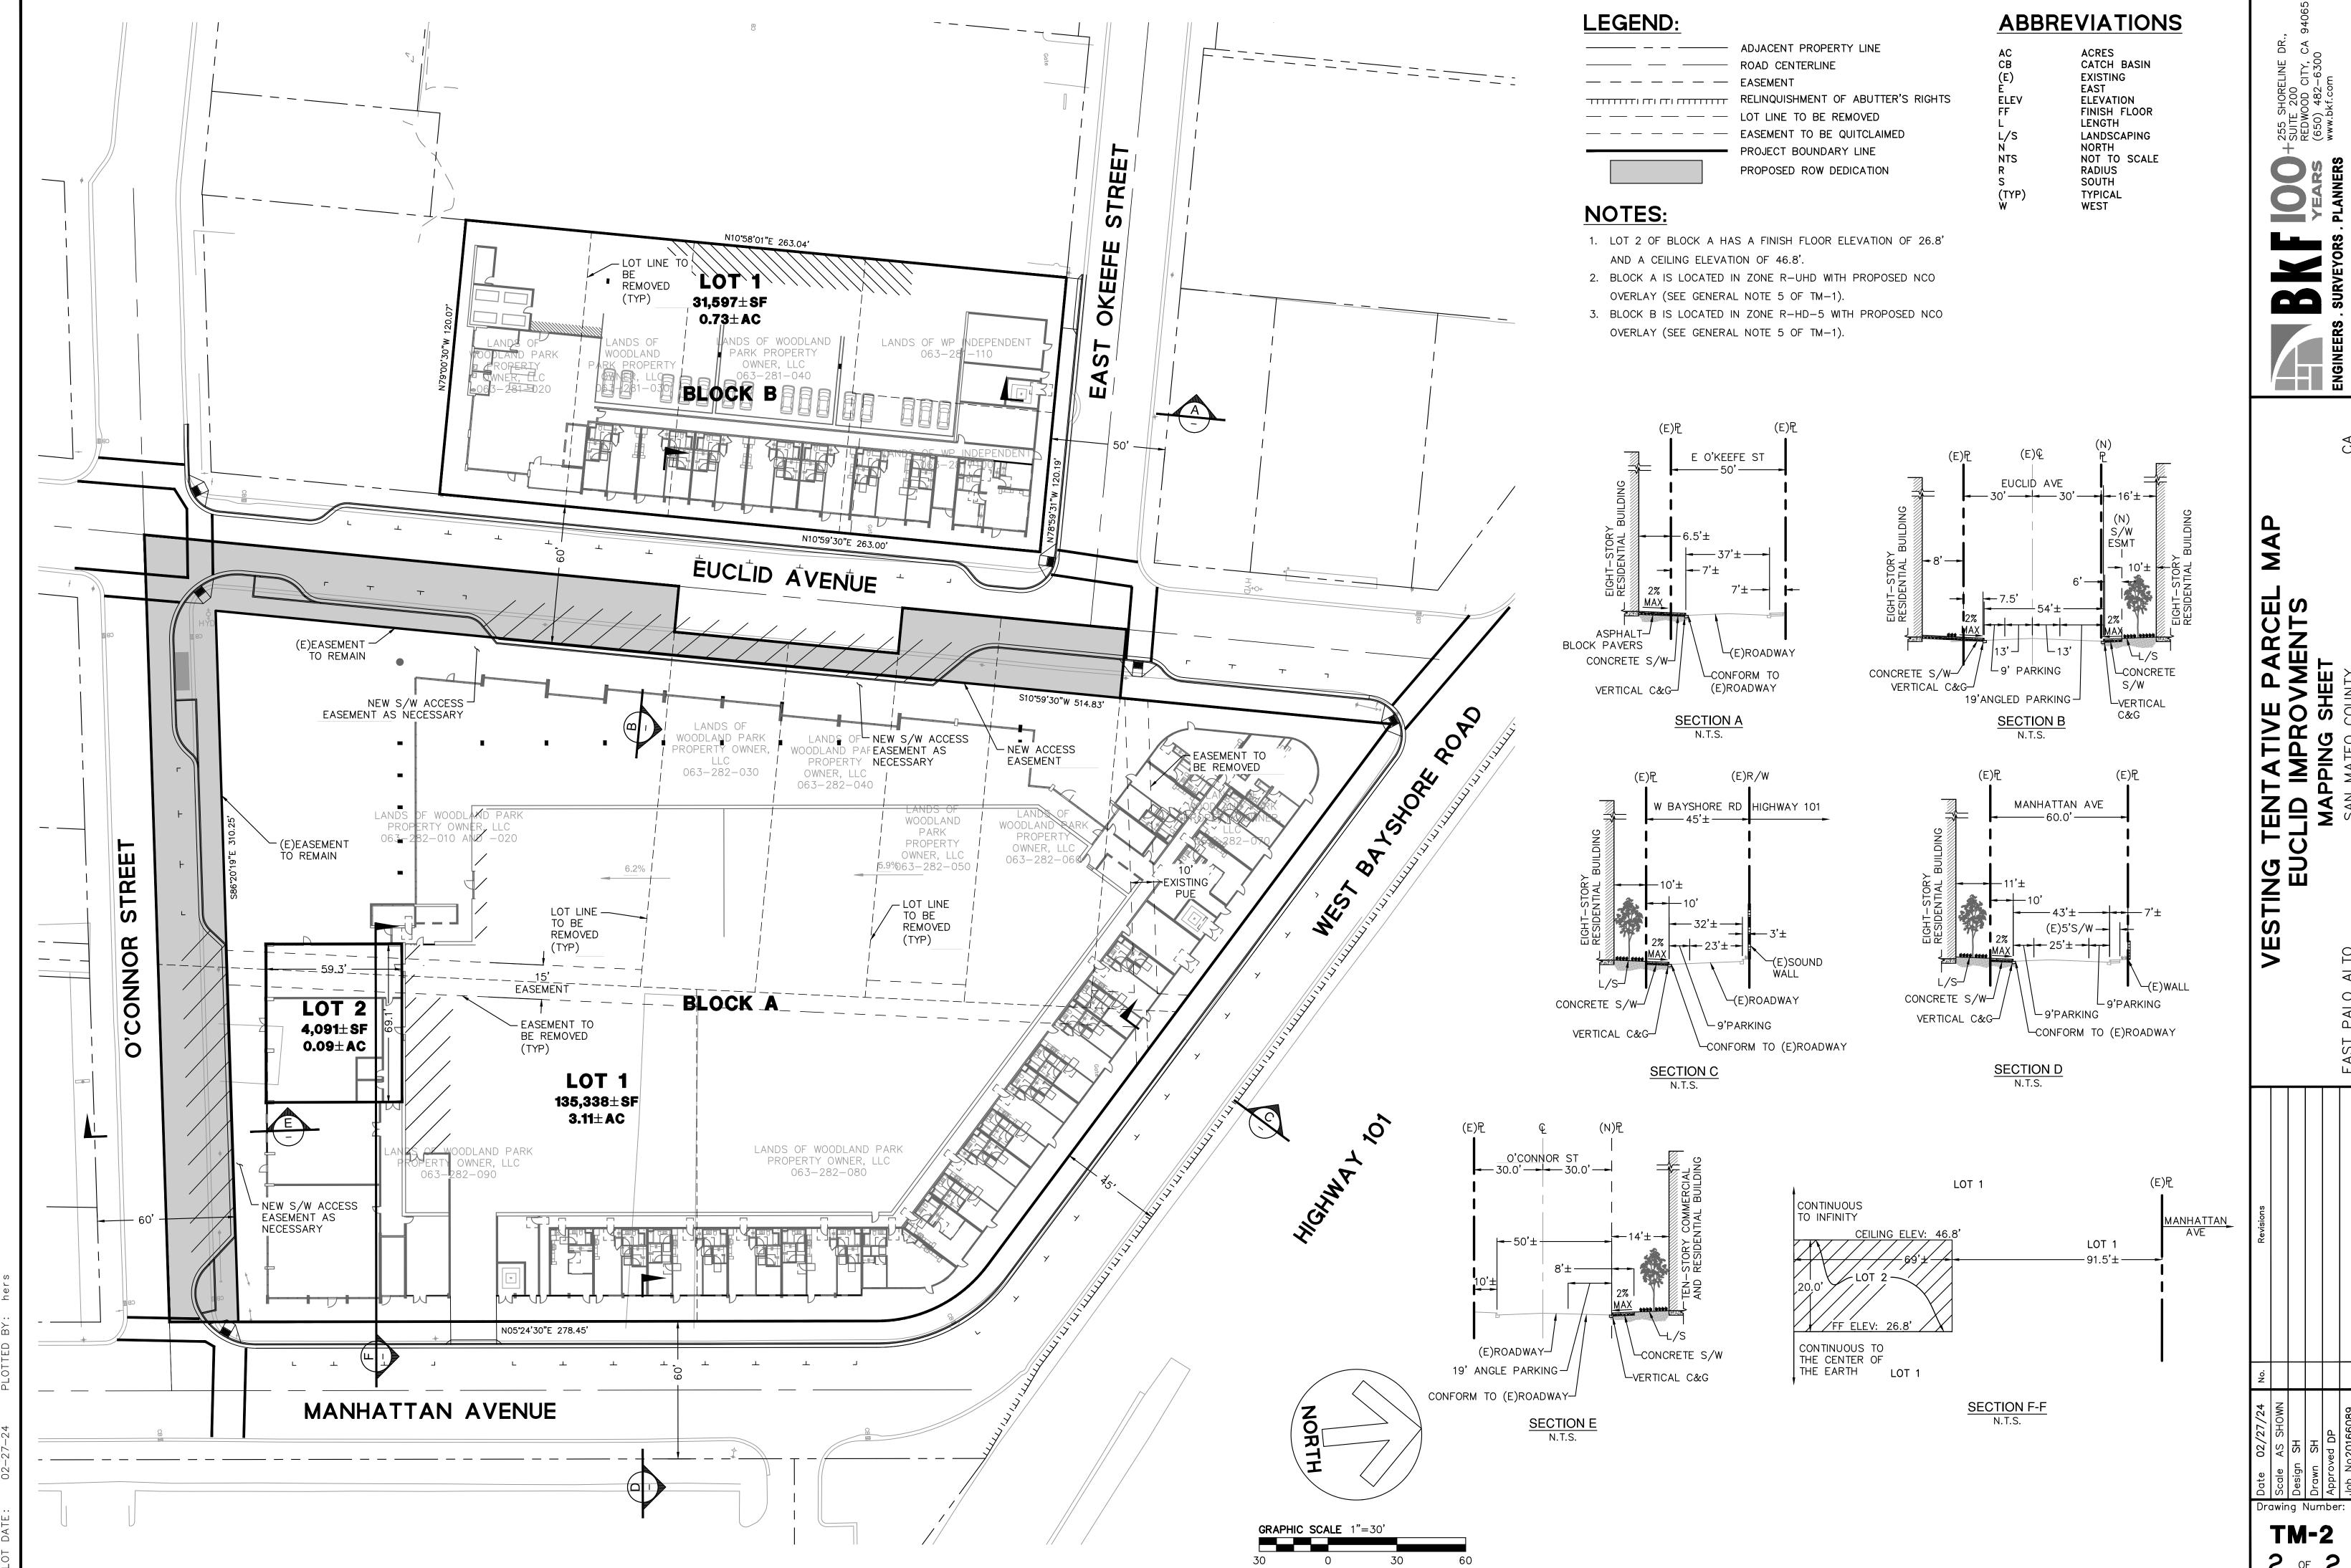




2 DONOHOE ST. ELEVATION 1/16" = 1'-0"

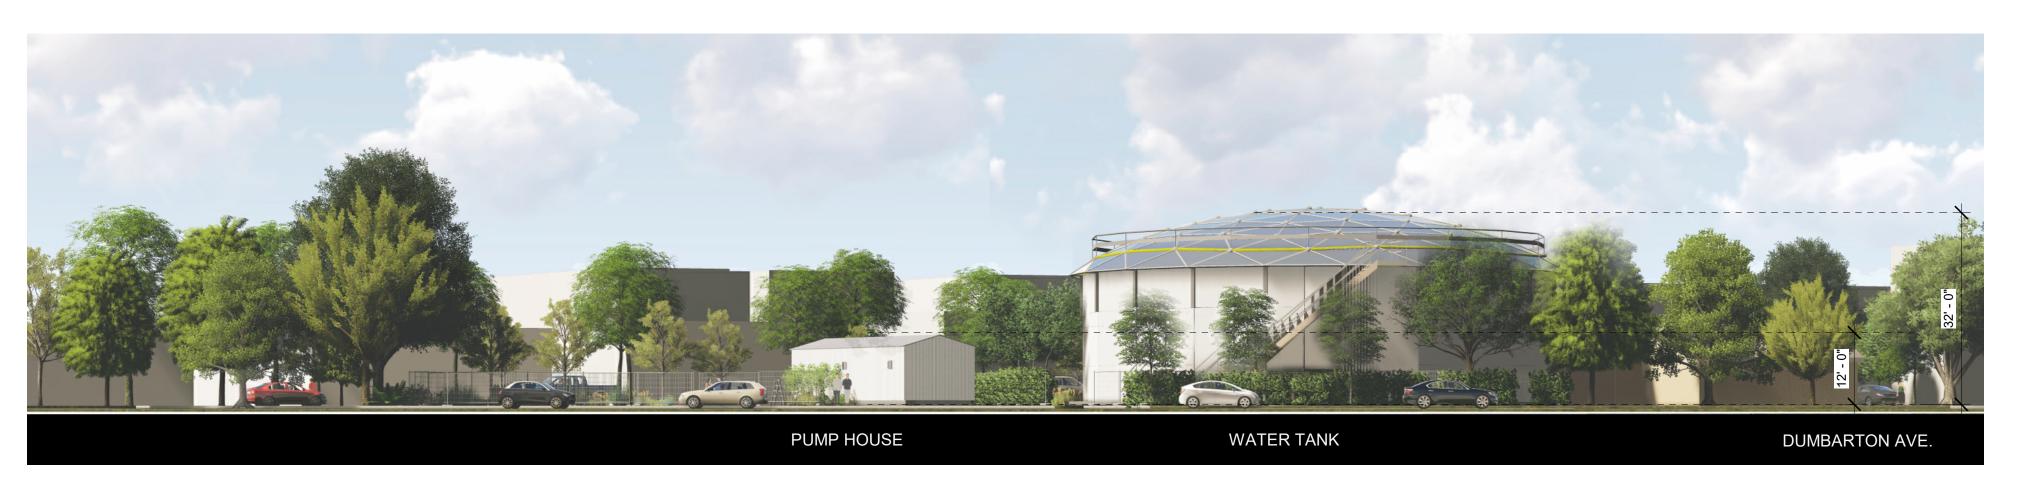

3 W.BAYSHORE ELEVATION 1/16" = 1'-0"

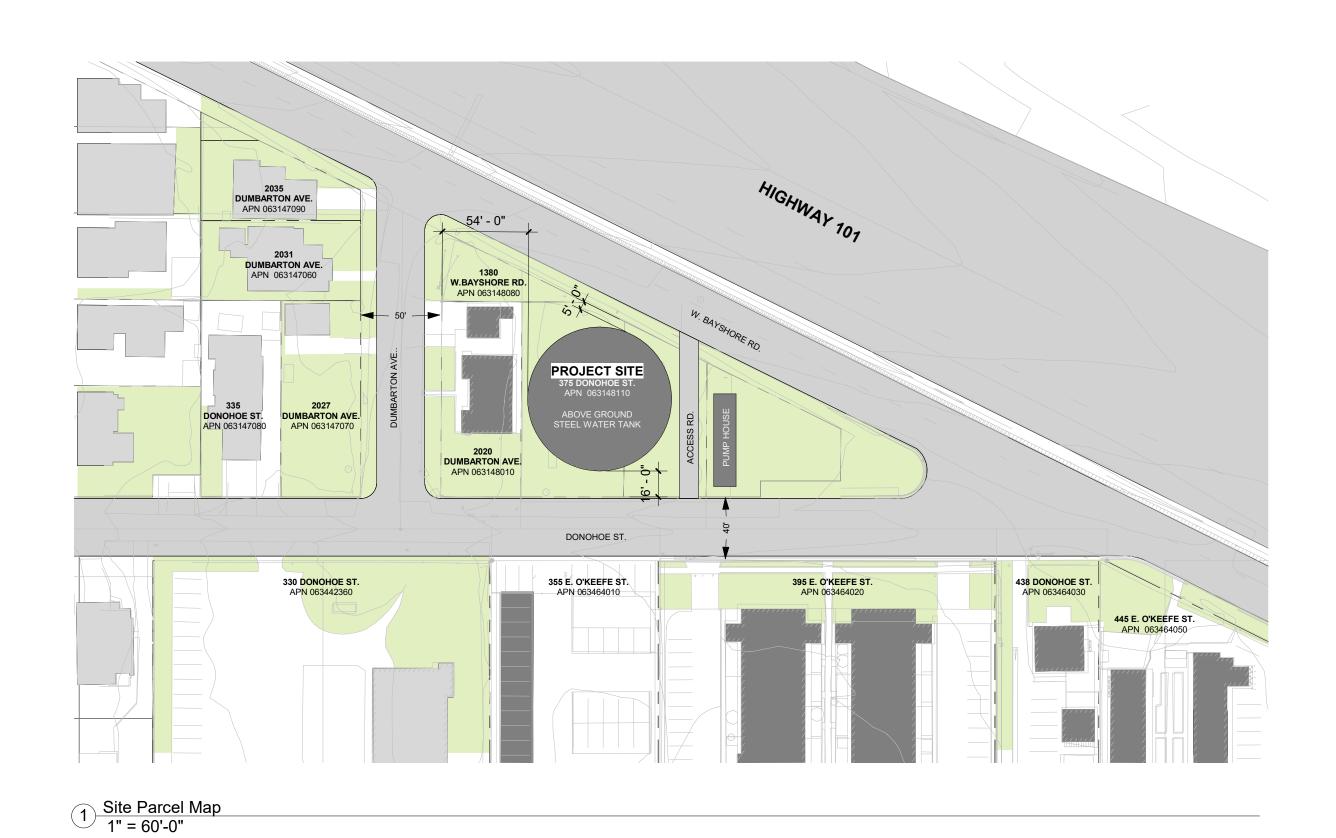



3D View - Donohoe St.



David Baker Architects

dbarchitect.com 461 Second St, Loft c127 San Francisco, CA 94107 415.896.6700

PREVIOUSLY SUBMITTED SHEET NO CHANGE

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Entitlements Submission	09/25/2019

		Revision
Rev.	Description	Dat

Set Title

Application - September 2019

Drawing Title

WATER TANK EXHIBIT

WT-001