
# WOODLAND PARK - EUCLID IMPROVEMENTS

#### **VICINITY MAP**

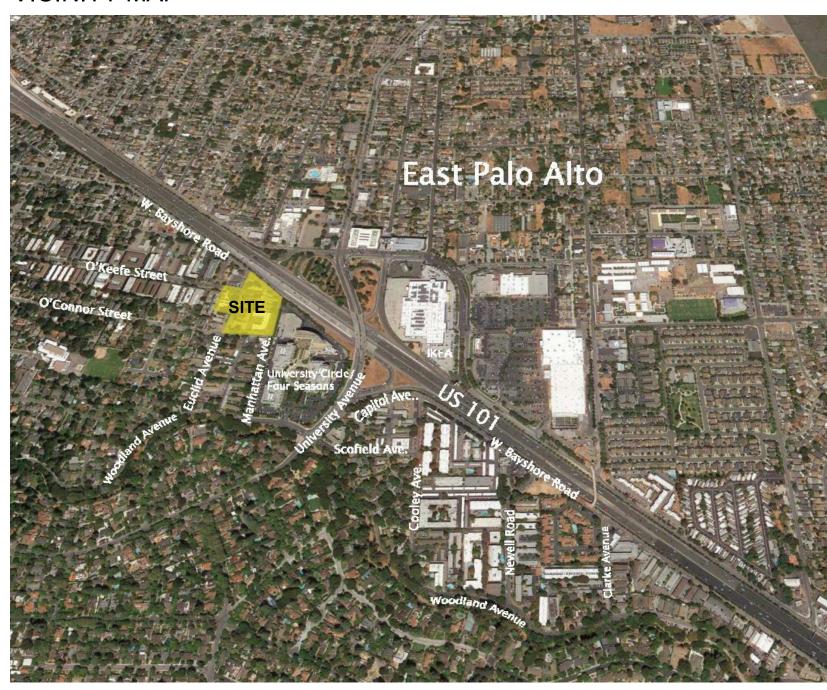

#### PROJECT DIRECTORY

#### APPLICANT:

Woodland Park Communities
5 Newell Court
East Palo Alto, CA 94303
ATTN: Michael Kramer
mkramer@wlpcommunities.com

#### ARCHITECT:

David Baker Architects
461 2nd Street, Loft C-127
San Francisco, CA 94107
ATTN: Daniel Simons
danielsimons@dbarchitect.com

#### LANDSCAPE ARCHITECT:

Hood Design Studio 3016 Filbert Street #2 Oakland, CA 94608 ATTN: Alma du Solier alma@hooddesignstudio.com

#### CIVIL ENGINEER:

BKF Engineers 1730 N. First Street. Suite 600 San Francisco, CA 94112 ATTN: Jacbon Nguyen jnguyen@bkf.com

#### PROJECT DESCRIPTION

With <u>no displacement</u>, this project proposes the replacement of several aging, outdated structures containing 160 rent-stabilized housing units and one single family rental (non-RSO) with new mixed-income buildings containing 550 apartments, 29% of which will be deed-restricted rent-controlled, replacing the existing apartments one-for-one.

Note: No portion of the property is located in a Flood Zone as designated by the Federal Emergency Managment Agency (FEMA).

#### PROJECT SITE

#### ZONING:

R-HD-5, R-UHD, Neighborhood Center Overlay (NCO)

#### **GENERAL PLAN DESIGNATION:**

HIGH DENSITY RESIDENTIAL / URBAN RESIDENTIAL, NEIGHBORHOOD CENTER OVERLAY

#### TOTAL SITE AREA:

170,941 SF = 3.92 ACRES

#### **EXISTING LOTS:**

APNS: 063282010 ADDRESSES: 501 O'Connor St. 2012 Euclid Ave. 2032 Euclid Ave. 2036 Euclid Ave. 2040 & 2042 Euclid Ave. 2044 Euclid Ave. 2054 Euclid Ave. 2033 Manhattan Ave. 2001 Manhattan Ave. 2021 Euclid Ave. 2025 Euclid Ave. 2031 Euclid Ave. 063281040 2043 Euclid Ave. 2041 Euclid Ave./420 E O'Keefe St.

#### SHEET INDEX

#### **GENERAL**

G-000 TITLE SHEET
G-100 CONTEXT
G-101 PERSPECTIVE VIEWS
G-102 PERSPECTIVE VIEWS
G-103 AERIAL VIEW
G-200 FIRE DIAGRAMS
G-201 CODE ANALYSIS - GENERAL

PLANNING DIAGRAMS

#### ARCHITECTURE

A-100 SITE PLAN - EXISTING SITE PLAN - PROPOSED FLOOR PLAN - LEVEL 1 FLOOR PLAN - LEVEL 2 FLOOR PLAN - LEVEL 3 FLOOR PLAN - LEVEL 4 FLOOR PLAN - LEVELS 5-7 A-206 FLOOR PLAN - LEVELS 8 FLOOR PLAN - ROOF A-300 BUILDING ELEVATIONS **BUILDING ELEVATIONS** A-302 BUILDING SECTIONS **EXTERIOR MATERIALS** OPEN SPACE DIAGRAMS OPEN SPACE DIAGRAMS CONCEPTUAL LIGHTING PLAN

#### LANDSCAPE

L-1.0	LANDSCAPE SITE PLAN	Maximum Density
L-1.1	LANDSCAPE DETAILS	Height
L-2.1	PLANTING PLAN	Open Space
T-0.1	TREE PROTECTION AND REMOVALS LIST AND	Setbacks* Front
	NOTES	Side/Street Side
T-1.1	TREE PROTECTION & REMOVAL PLAN	Rear

#### CIVIL

**OTHER** 

1.0	EXISTING CONDITIONS AND DEMOLITION PLAN
2.0	PRELIMINARY SITE PLAN
3.0	PRELIMINARY GRADING AND DRAINAGE PLAN
4.0	PRELIMINARY UTILITY PLAN

C-5.0 PRELIMINARY STORMWATER MANAGEMENT PLAN
C-5.1 PRELIMINARY STORMWTER MANAGEMENT PLAN
C-6.0 PRELIMINARY FIRE ACCESS PLAN

TM-1 VESTING TENTATIVE PARCEL MAP - TITLE SHEET
 TM-2 VESTING TENTATIVE PARCEL MAP - MAPPING

#### HEET

WT-001 WATER TANK EXHIBIT

#### PROJECT DATA

#### **GROSS AREAS**

CIRCULATION	52448 SF
COMMON	31837 SF
COMMUNITY SPACE	2500 SF
GARAGE / BIKE ROOM	139931 SF
RESIDENTIAL	418642 SF
RETAIL	2619 SF
SERVICE / TRASH	9455 SF
STAIRS / ELEVATORS	12831 SF
	670262 SF

#### **UNIT MIX**

TYPE	EXISTING*	MIX	APPROVED	MIX	REVISED	MIX	AVG. AREA
STUDIO	53	33%	228	38%	21**	4%	495 sf
1 BR	102	64%	197	33%	343	62%	688 sf
2 BR	4	2%	178	29%	184	33%	977 sf
3 - 4 BR	2	<1%	2	<1%	2	<1%	1,298 sf
TOTAL	161		605		550		

**BIKE PARKING** 

**PROVIDED** 

**OPEN SPACE** 

COMMON OPEN SPACE

PRIVATE OPEN SPACE

(excluding Public Open Space)

Open space per unit

PUBLIC PARK

PUBLIC OPEN SPACE

CLASS I:

**REQ PER EPAMC:** 

1 CLASS I SPACE FOR EVERY 3 UNITS = 183 CLASS I

1 CLASS II SPACE FOR EVERY 15 UNITS = 36 CLASS II

AREA

32,115 SF

25,318 SF

57,433 SF

10,675 SF

9,355 SF

104 SF/UNIT

BUILDING A: 72 STALLS (ONE BIKE ROOM)

CLASS II: 45 STALLS PROVIDED ON SITE

Total

**TOTAL: 324 STALLS PROVIDED** 

BUILDING B: 252 STALLS (TWO BIKE ROOMS)

#### **PARKING**

STALLS	EXISTING	APPROVED	REVISED	
			BUILDING A	BUILDING B
OFF-STREET	155	625	136	434
ON-STREET	52	52	7	2

#### (14 of the proposed parking stalls are ADA, including 4 ADA van spaces)

# Approved Parking Ratio = 1.03 spaces/unit Revised Parking Ratio = 1.03 spaces/unit Building A Parking Ratio = 1.03 spaces/unit Building B Parking Ratio = 1.03 spaces/unit

#### LOT COVERAGE CALCULATIONS

BUILDING A LOT COVERAGE LOT AREA = 31,596 SF 18,853 SF / 31,596 SF = **59%** BUILDING B LOT COVERAGE TOTAL LOT AREA = 139,345 SF 89,544 SF / 139,345 SF = **64%** 

#### TOTAL LOT COVERAGE 108,397 / 170,941 SF = 63%

#### F.A.R. REQUIRED: N/A


(PER DEVELOPMENT CODE SECTION 18.10 TABLE 2-2)

#### ZONING COMPARISON

Development Standard	NCO Zone / GP Designation Requirement	Approved Project (Nov 2022)	Revised Project (Apr 2024)
Maximum Density	175 du/acre	155 du/acre	141 du/acre
Height	13 stories / 140 feet	13 stories / 135 feet	8 stories / 85 feet
Open Space	100 sf/unit	100 sf/unit	105 sf/unit or greater
Setbacks*			
Front	5 feet	9-12 feet	5-10 feet
Side/Street Side	5 feet	10-85 feet	5-69 feet
Rear	10 feet	10-20 feet	10-60 feet
Corner vision triangle	12 feet	12 feet	12 feet

<sup>\*</sup>Front Setback areas: Building B - W. Bayshore Rd. Building A - E. O'Keefe St.

# Woodland Park Euclid Improvements

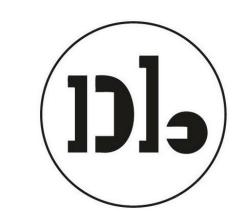

#### **David Baker Architects**

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License Stamp

	Issuances
Description	Date
Entitlements Update	2/27/2024

		Revision
Rev.	Description	Dat

<sup>1</sup> Response to Comments 4/19/2024

Set Ti

Design Update -April 2024

Drawing Title


TITLE SHEET

Sheet No.

Date 04/18/2024 Project No. 21620

<sup>\*</sup> There are 160 current rent-stabilized units and one 2 BR single-family rental (non-RSO)

<sup>\*\* 32</sup> existing studios will be replace by 1 BR units

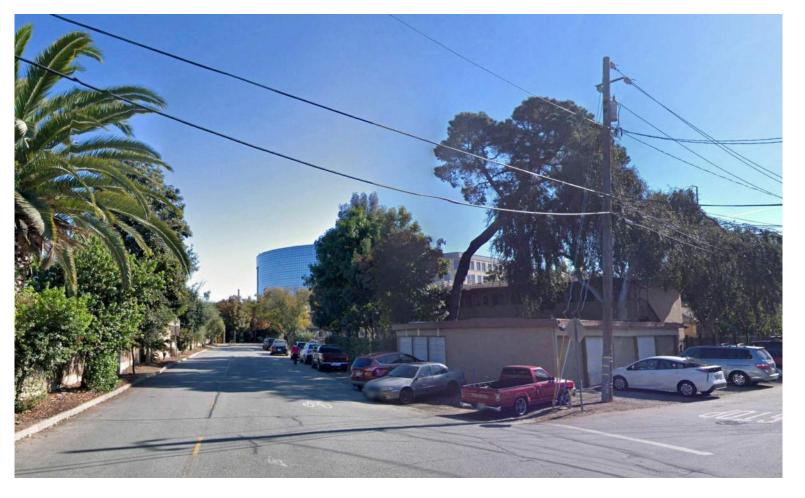

1 - Intersection of West Bayshore Road and Euclid Avenue, Looking East



2 - West Bayshore Road, Looking East




3 - Intersection of West Bayshore Road and Manhattan Avenue, Looking South




4 - Intersection of Manhattan Avenue and O'Connor Street, Looking North




5 - Manhattan Avenue, Looking North

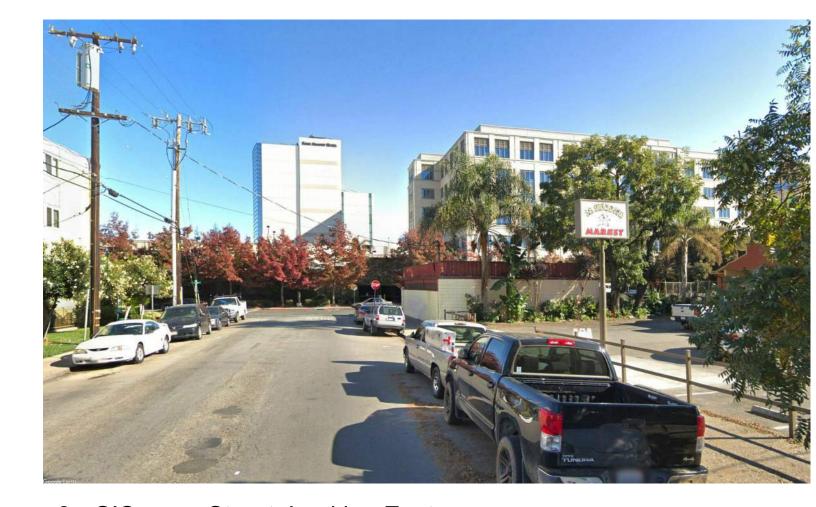


6 - O'Connor Street, Looking East

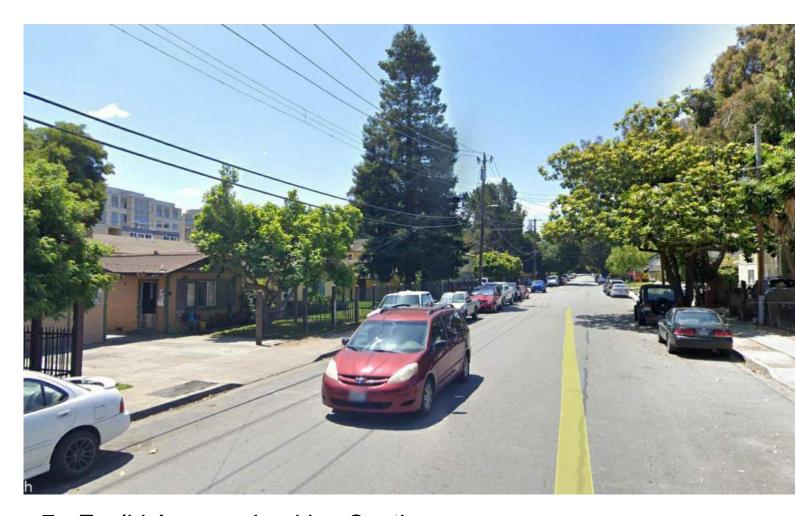

7 - Euclid Avenue, Looking South

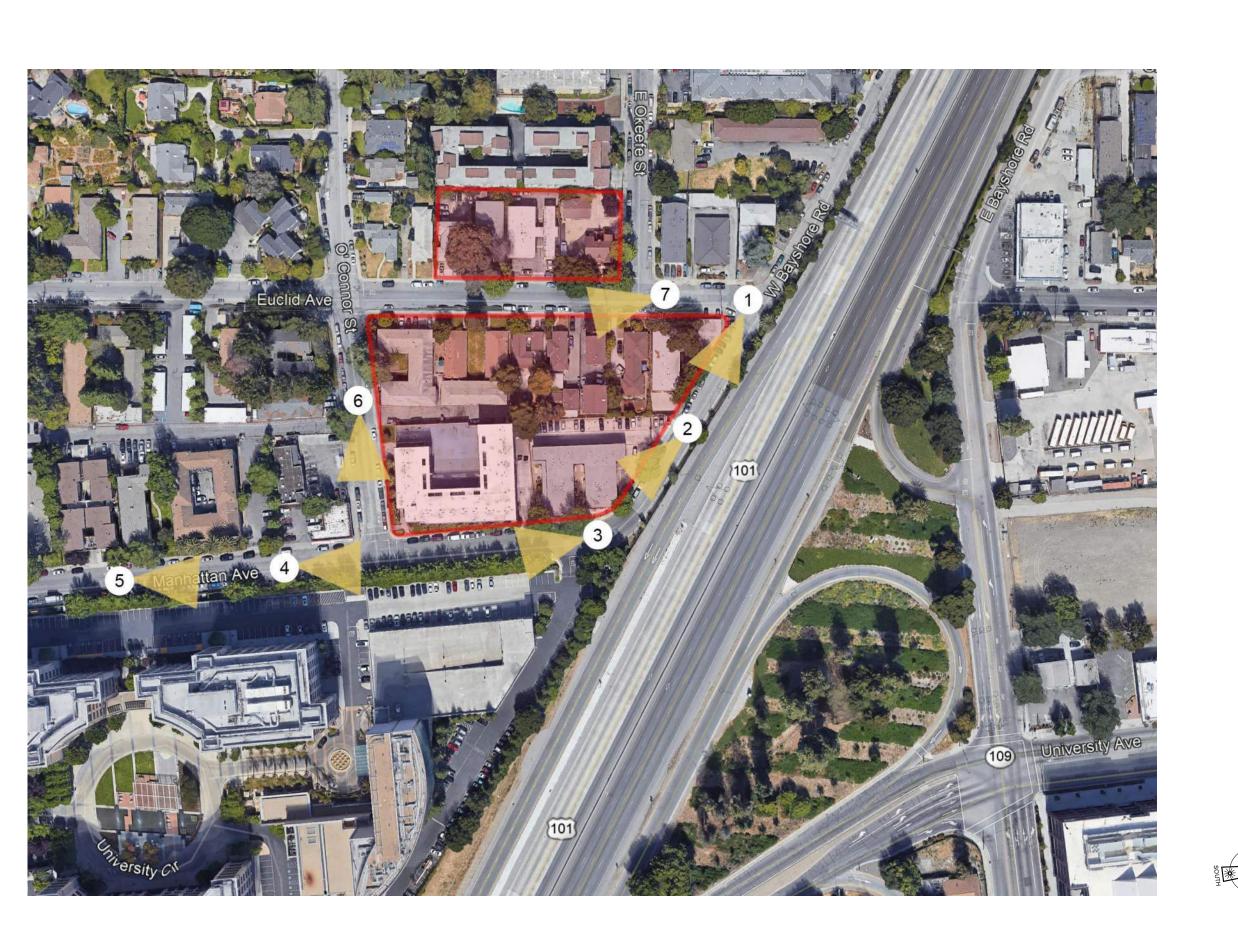

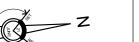



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#### PREVIOUSLY SUBMITTED SHEET NO CHANGE

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Description	Date
Entitlements Submission	09/25/2019

_			Revisions
	Rev.	Description	Date

Set Title

Application - September 2019

Drawing Title

CONTEXT

Sheet No.

 Date
 08-23-2022

 Project No.
 21620

1- VIEW OF PARK FROM O'CONNOR ST.



2- VIEW OF EUCLID LOOKING TOWARDS O'KEEFE ST.



MANHATTAN AVE. KEY PLAN



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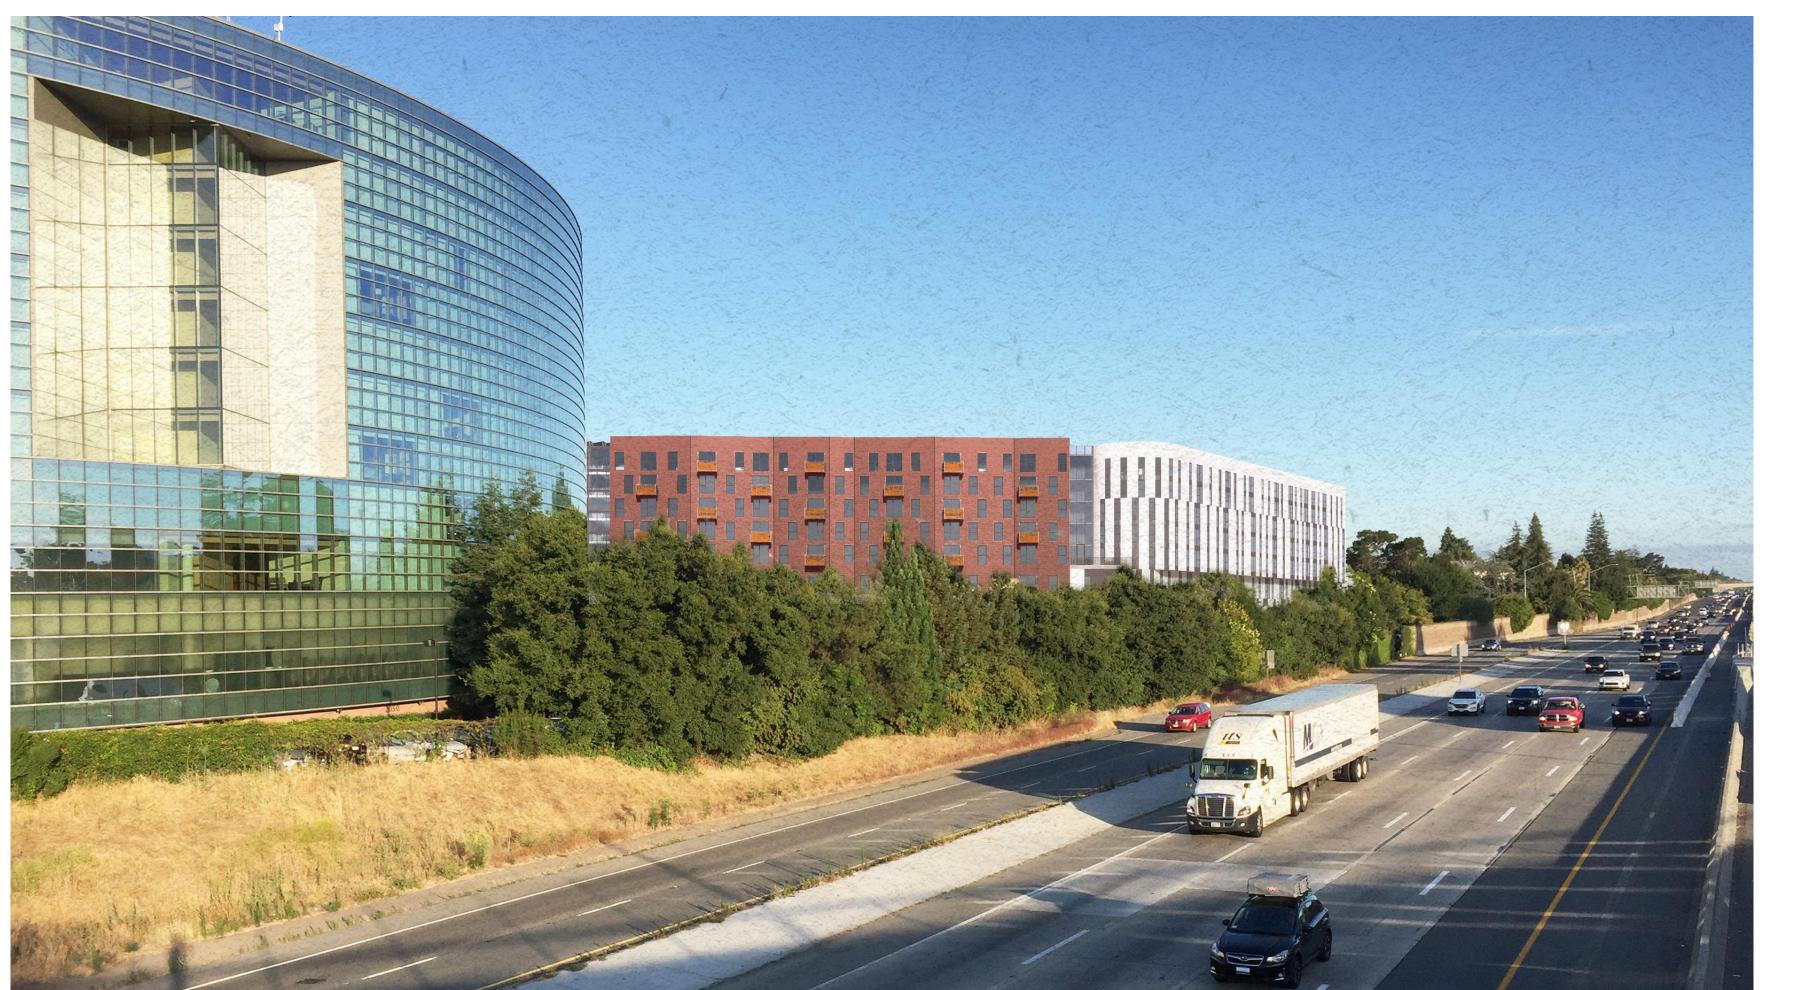
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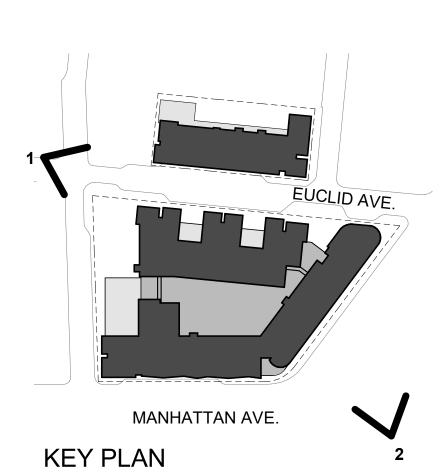
PERSPECTIVE **VIEWS** 

G-101


04/18/2024 Date Project No. 21620

1- VIEW DOWN EUCLID AVE. LOOKING NORTH





2- VIEW FROM US 101/ UNIVERSITY AVE OVERPASS (FOUR SEASONS HOTEL IN FOREGROUND)

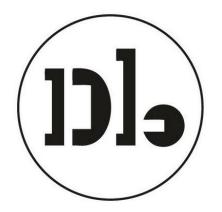

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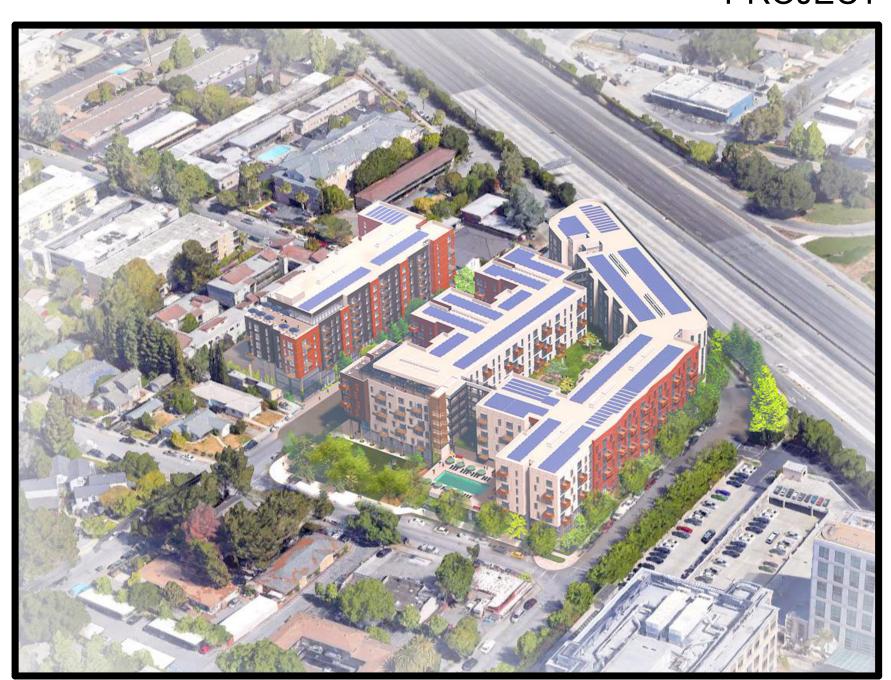
Drawing Title

PERSPECTIVE VIEWS

Sheet No. **G-102** 



### PROJECT



# Woodland Park Euclid Improvements



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Entitlements Update	2/27/2024

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Rev.	Description	Date

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Design Update -April 2024

Drawing Title

**AERIAL VIEW** 

Sheet No.

#### Level 7 - A 65' - 0" Level 6 - A 55' - 0" FIRE APPARATUS ROAD <150' THEREFORE DOES NOT REQUIRE A TURNAROUND RED DASH: 150' ACCESS PROPOSED FIRE HYDRANT -Level 5 - A 45' - 0" Level 4 - A 35' - 0" Level 3 - A 24' - 6" — LEVEL 3 PODIUM DECK Level 2 - A 14' - 6" BUILDING A : AERIAL ACCESS LANE REQUIRED 15'-30' FROM FIRE APPARATUS ROAD UNOBSTRUCTED AREA REQUIRED: 20' WIDE BY 13'-6" HIGH Level 1 - A 0' - 0" BUILDING PER CFC 20' - 0" SECTION D105 PER CFC 503.2.1 1/16" = 1'-0" **BUILDING A** SECTION - FIRE LANE - BUILDING A **EXISTING FIRE** HYDRANT PROPOSED FIRE HYDRANT **EXISTING FIRE** FIRE APPARATUS ACCESS LANE HYDRANT Level 8 - A 75' - 0" EUCLID AVENUE Level 7 - A 65' - 0" PROPOSED FIRE HYDRANTS <u>Level 6 - A</u> 55' - 0" RED DASH: 150' ACCESS Level 5 - A 45' - 0" LEVEL 3 Level 4 - A 35' - 0" PODIUM LEVEL 3 PODIUM DECK\_ RED DASH: Level 3 - A 24' - 6" 150' ACCESS Level 2 - A 14' - 6" <u>Level 1 - A</u> Entitlements Update LEVEL 4 COURTYARD 1/16" = 1'-0" ACCESS LANE SECTION - FIRE DIAGRAM @ E. O'KEEFE 30' - 0" LEVEL 3 PODIUM DECK 15' - 0" **BUILDING B** 2' MAX SETBACK VARIATION Roof 85' - 0" Level 8 74' - 0" × 20, Level 7 64' - 0" Level 6 54' - 0" Level 5 44' - 0" PROPOSED FIRE HYDRANT Level 4 34' - 0" AERIAL APPARATUS ACCESS LANE MANHATTAN AVE. Level 3 21' - 0" BUILDING B: GREATER THAN 200 UNITS, 2 FIRE APPARATUS ACCESS LANES REQUIRED PER CFC SECTION D106 (MANHATTAN & EUCLID AVE) Level 2 11' - 0" PROPOSED FIRE HYDRANT - FOUR SEASONS / UNIVERSITY CIRCLE COMPLEX SIDEWALK ACCESS LANE 1" = 30'-0" 1/16" = 1'-0" Date SECTION - FIRE DIAGRAM @ MANHATTAN FIRE DIAGRAM 3

# Woodland Park Euclid Improvements



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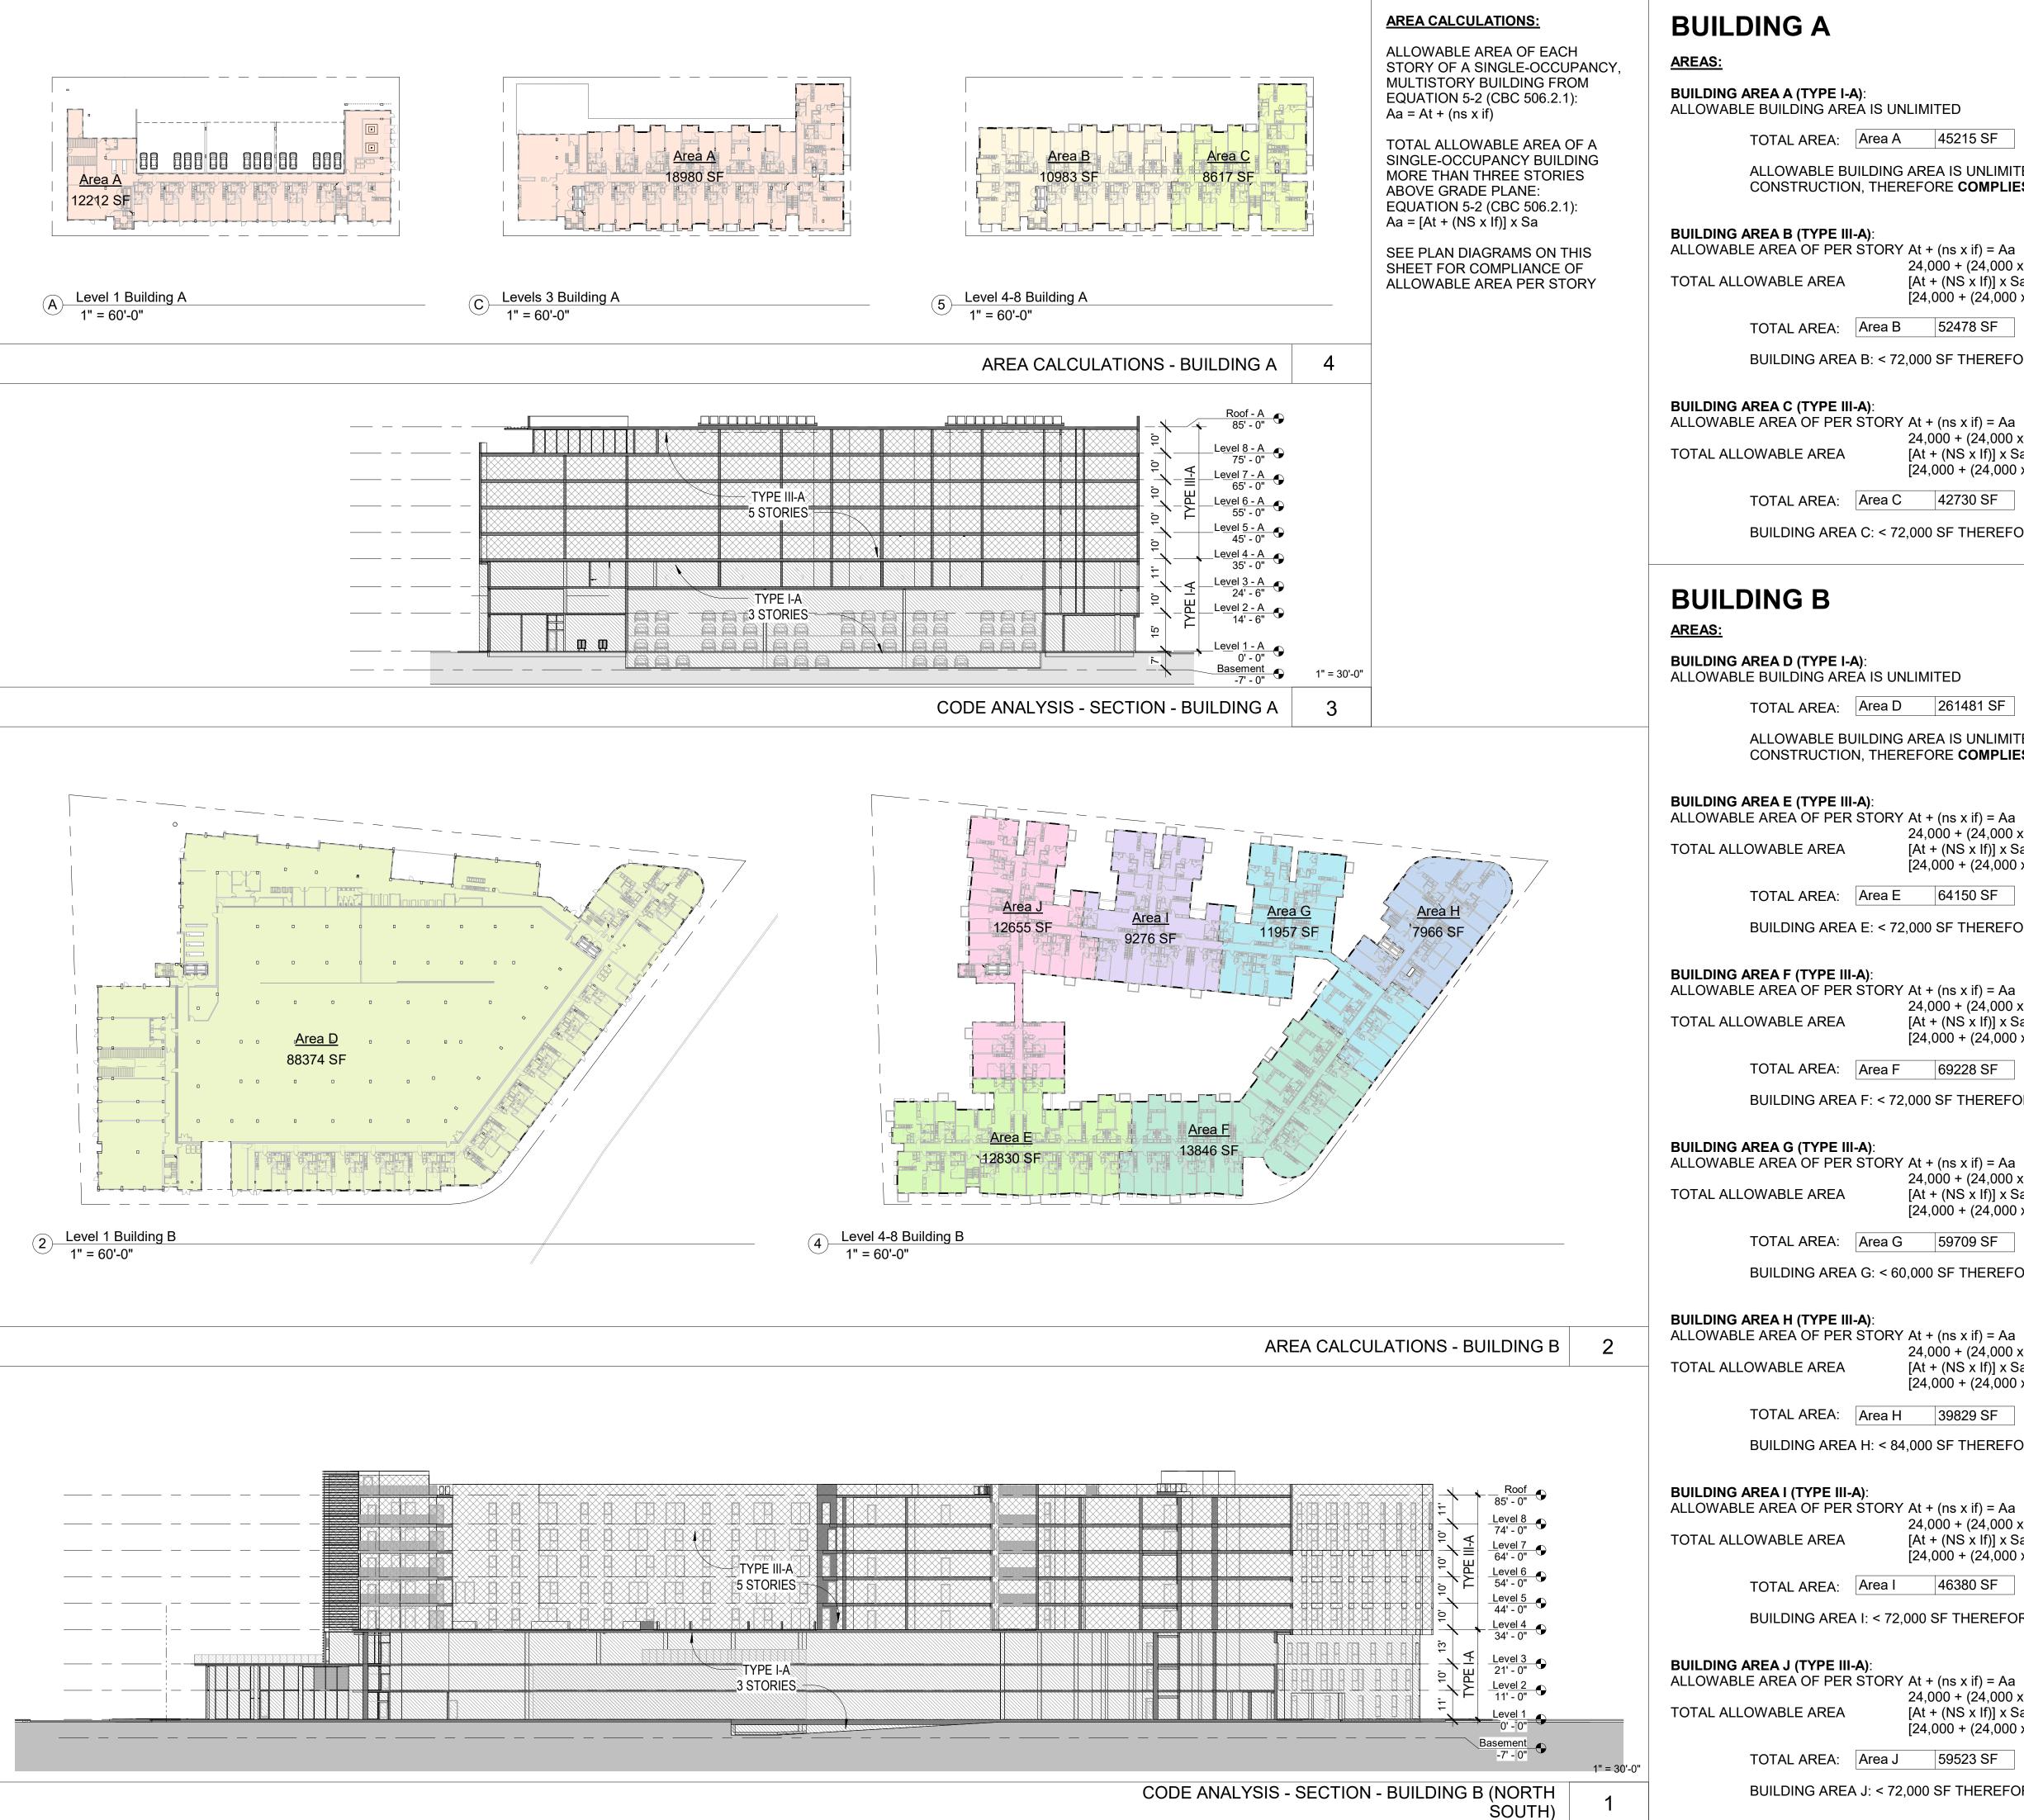
Design Update -April 2024

**Drawing Title** 

FIRE DIAGRAMS

Sheet No. G-200

04/18/2024 Project No. 21620



BUILDING AREA A (TYPE I-A): ALLOWABLE BUILDING AREA IS UNLIMITED

TOTAL AREA: Area A 45215 SF

ALLOWABLE BUILDING AREA IS UNLIMITED FOR TYPE I-A CONSTRUCTION. THEREFORE COMPLIES

**BUILDING AREA B (TYPE III-A):** 

ALLOWABLE AREA OF PER STORY At + (ns x if) = Aa  $24,000 + (24,000 \times .5) = 36,000 \text{ SF}$  $[At + (NS \times If)] \times Sa = Aa$ 

 $[24,000 + (24,000 \times 0.5)] \times 2 = 72,000 \text{ SF}$ 

BUILDING AREA B: < 72,000 SF THEREFORE **COMPLIES** 

52478 SF

24,000 + (24,000 x.5) = 36,000 SF

 $[At + (NS \times If)] \times Sa = Aa$  $[24,000 + (24,000 \times 0.5)] \times 2 = 72,000 \text{ SF}$ 

TOTAL AREA: Area C 42730 SF

BUILDING AREA C: < 72,000 SF THEREFORE **COMPLIES** 

#### **BUILDING B**

**BUILDING AREA D (TYPE I-A):** ALLOWABLE BUILDING AREA IS UNLIMITED

TOTAL AREA: Area D 261481 SF

ALLOWABLE BUILDING AREA IS UNLIMITED FOR TYPE I-A

CONSTRUCTION, THEREFORE COMPLIES

**BUILDING AREA E (TYPE III-A)**:

ALLOWABLE AREA OF PER STORY At + (ns x if) = Aa 24,000 + (24,000 x.5) = 36,000 SF

TOTAL ALLOWABLE AREA [At + (NS x If)] x Sa = Aa $[24,000 + (24,000 \times 0.5)] \times 2 = 72,000 \text{ SF}$ 

TOTAL AREA: Area E 64150 SF

BUILDING AREA E: < 72,000 SF THEREFORE **COMPLIES** 

BUILDING AREA F (TYPE III-A): ALLOWABLE AREA OF PER STORY At + (ns x if) = Aa 24,000 + (24,000 x.5) = 36,000 SF

TOTAL ALLOWABLE AREA  $[At + (NS \times If)] \times Sa = Aa$ 

 $[24,000 + (24,000 \times 0.5)] \times 2 = 72,000 \text{ SF}$ 

TOTAL AREA: Area F 69228 SF

BUILDING AREA F: < 72,000 SF THEREFORE **COMPLIES** 

BUILDING AREA G (TYPE III-A):
ALLOWABLE AREA OF PER STORY At + (ns x if) = Aa

TOTAL ALLOWABLE AREA

 $24,000 + (24,000 \times .25) = 30,000 \text{ SF}$  $[At + (NS \times If)] \times Sa = Aa$  $[24,000 + (24,000 \times 0.25)] \times 2 = 60,000 \text{ SF}$ 

TOTAL AREA: Area G 59709 SF

BUILDING AREA G: < 60,000 SF THEREFORE **COMPLIES** 

BUILDING AREA H (TYPE III-A): ALLOWABLE AREA OF PER STORY At + (ns x if) = Aa

 $24,000 + (24,000 \times .75) = 42,000 \text{ SF}$  $[At + (NS \times If)] \times Sa = Aa$ TOTAL ALLOWABLE AREA  $[24,000 + (24,000 \times 0.75)] \times 2 = 84,000 \text{ SF}$ 

> TOTAL AREA: Area H 39829 SF

BUILDING AREA H: < 84,000 SF THEREFORE **COMPLIES** 

BUILDING AREA I (TYPE III-A):
ALLOWABLE AREA OF PER STORY At + (ns x if) = Aa

TOTAL ALLOWABLE AREA

24,000 + (24,000 x.5) = 36,000 SF[At + (NS x If)] x Sa = Aa [24,000 + (24,000 x 0.5)] x 2 = **72,000 SF** 

TOTAL AREA: Area I 46380 SF

BUILDING AREA I: < 72,000 SF THEREFORE **COMPLIES** 

**BUILDING AREA J (TYPE III-A):** 

ALLOWABLE AREA OF PER STORY At + (ns x if) = Aa

24,000 + (24,000 x.5) = 36,000 SF $[At + (NS \times If)] \times Sa = Aa$  $[24,000 + (24,000 \times 0.5)] \times 2 = 72,000 \text{ SF}$ 

TOTAL AREA: Area J 59523 SF

BUILDING AREA J: < 72,000 SF THEREFORE **COMPLIES** 

Woodland Park Euclid Improvements



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License Stamp

Issuances Date Description 2/27/2024 Entitlements Update

Revisions Rev. Description Date

1 Response to Comments 4/19/2024

Set Title

Design Update -April 2024

**Drawing Title** 

CODE ANALYSIS - GENERAL


Sheet No.

G-201

04/18/2024 21620

Date

Project No.

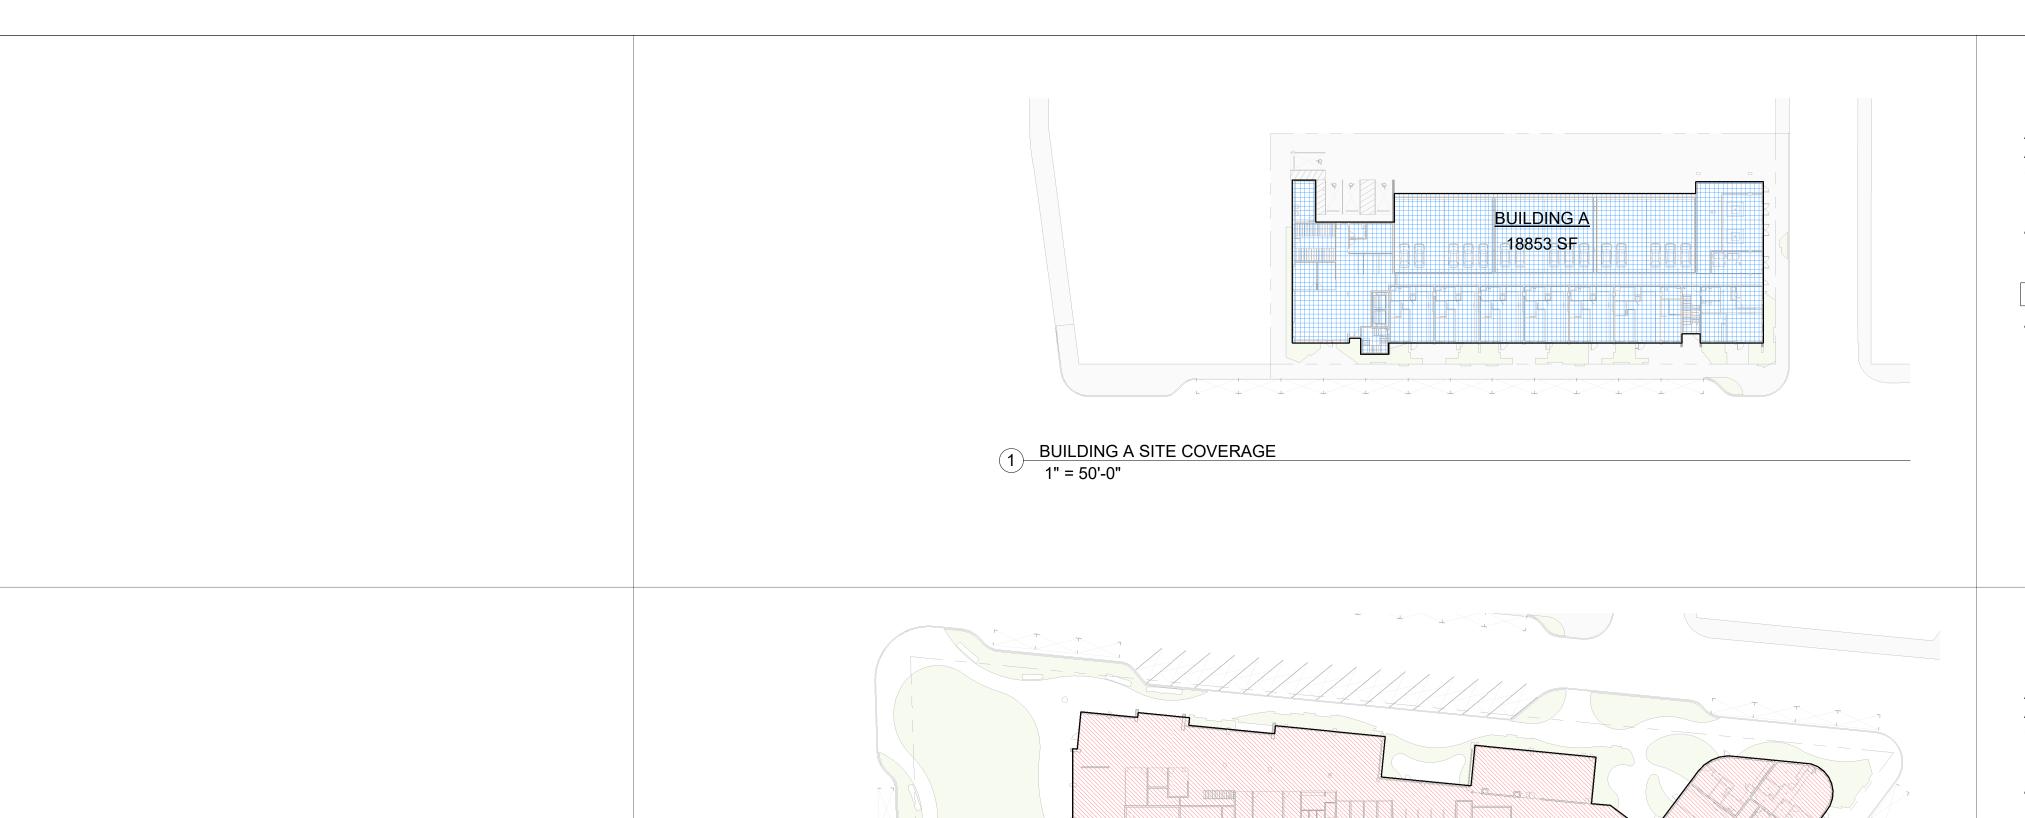


#### BUILDING A LOT COVERAGE

ALLOWABLE
ALLOWABLE LOT COVERAGE = 70% MIN
(PER EPAMC 18.10.030)

# ACTUAL LOT AREA = 31,596 SF BUILDING FOOTPRINT:

**BUILDING A** 18853 SF

ACTUAL LOT COVERAGE = 59%

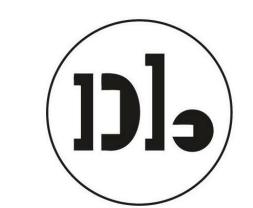

Euclid

Woodland Park

Improvements

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PLANNING DIAGRAMS

G-202

04/18/2024 Date Project No. 21620

# BUILDING B LOT COVERAGE ALLOWABLE ALLOWABLE LOT COVERAGE = 70% (PER EPAMC 18.10.030)

5' SIDE SETBACK

10'

3 SECTION - BALCONIES @ MANHATTAN

1/16" = 1'-0"

Roof 85' - 0"

Level 8 74' - 0"

Level 7 64' - 0"

<u>Level 6</u> 54' - 0"

Level 5 44' - 0"

Level 4 34' - 0"


Level 3 21' - 0"

Level 2 11' - 0"

**ACTUAL** LOT AREA = 139,345 SF BUILDING FOOTPRINT: **BUILDING B** 89544 SF

ACTUAL LOT COVERAGE = 64%

WALL ANGLES, SETBACK VARIES ——► MAXIMUM 2'

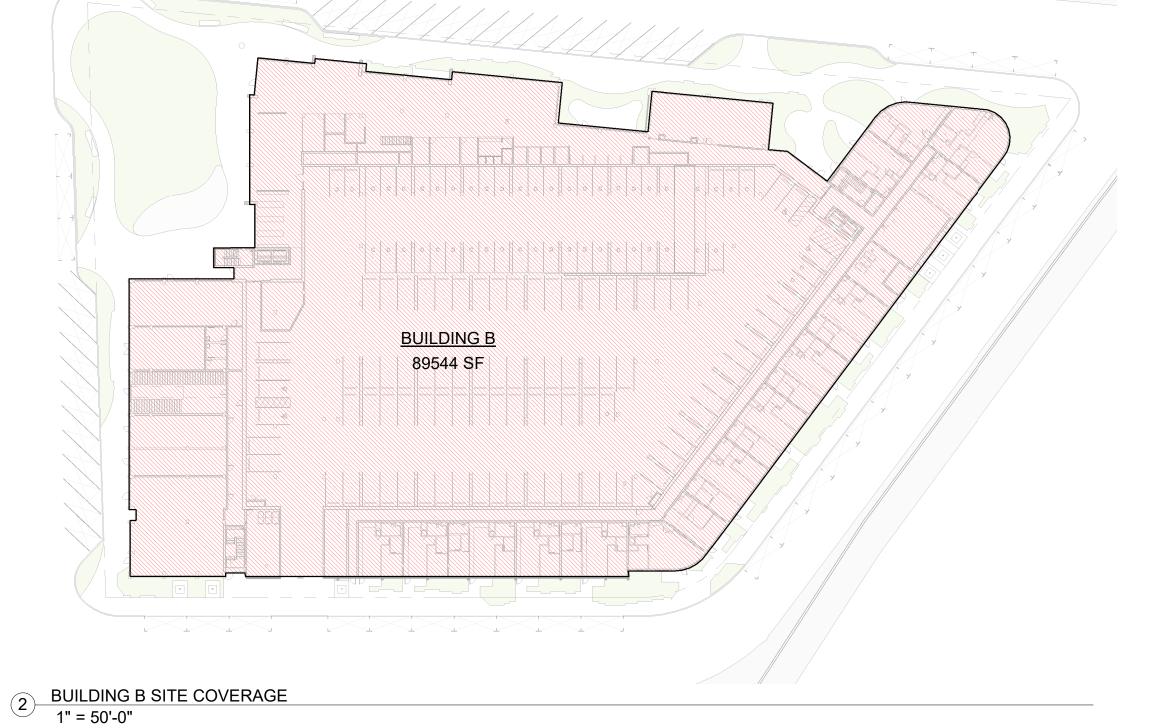







## **Existing properties:**

(11 rent-stabilized units)

2025 Euclid Avenue (7 rent-stabilized units)

6 x Studio Units 1 x 1 Bedroom Unit

2031 Euclid Avenue (12 rent-stabilized units)

12 x 1 Bedroom Units

2032 Euclid Avenue

1 x 2 Bedroom Single-Family-House (non-RSO)

2036 Euclid Avenue (4 rent-stabilized units)

> 2 x Studio Units 1 x 1 Bedroom Unit 1 x 2 Bedroom Unit

2040 & 2042 Euclid Avenue (2 rent-stabilized units)

1 x 2 Bedroom Unit 1 x 4 Bedroom Unit

2041 Euclid Avenue (also known as 420 O'Keefe)

Community Engagement Office

2043 Euclid Avenue

Resident Services Office and Community Technology Center

2044 Euclid Avenue (2 rent-stabilized units)

1 x 2 Bedroom Unit 1 x 3 Bedroom Unit

2054 Euclid Avenue (8 rent-stabilized units)

8 x 1 Bedroom Units

2012 Euclid Avenue/501 O'Connor Street (22 rent-stabilized units)


22 x 1 Bedroom Units

2001 Manhattan Avenue (60 rent-stabilized units)


> 8 x Studio Units 52 x 1 Bedroom Units

2033 Manhattan Avenue (32 rent-stabilized units)

26 x Studio Units 6 x 1 Bedroom Units

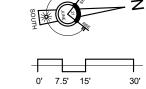

# Woodland Park Euclid Improvements

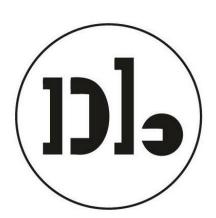

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Revisions Rev. Description Date

Set Title

Application -September 2019

**Drawing Title** 

SITE PLAN -**EXISTING** 

> Sheet No. A100

08-23-2022 Date Project No. 21620

# - 10' FENCE AT PROPERTY LINE 10' FENCE AT PROPERTY LINE 11' - 3" THINNER DASHED LINE INDICATES BUILDING OVERHANG ABOVE THINNER DASHED LINE INDICATES BUILDING OVERHANG ABOVE EUCLID AVENUE PROPERTY BOUNDARIES NEW BUS STOP 83' RECREATION COURT CORNER PARK OFFICE RECRÉATION PLAZA ST O'CONNOR BIKE ROOM MPOE ELEC COMMUNITY ROOM RED FILL REGIONS INDICATE CORNER VISION TRIANGLE PROPERTY BOUNDARY MANHATTAN AVE. 0' 7.5' 15' 30' FOUR SEASONS / UNIVERSITY CIRCLE COMPLEX

# Woodland Park Euclid Improvements



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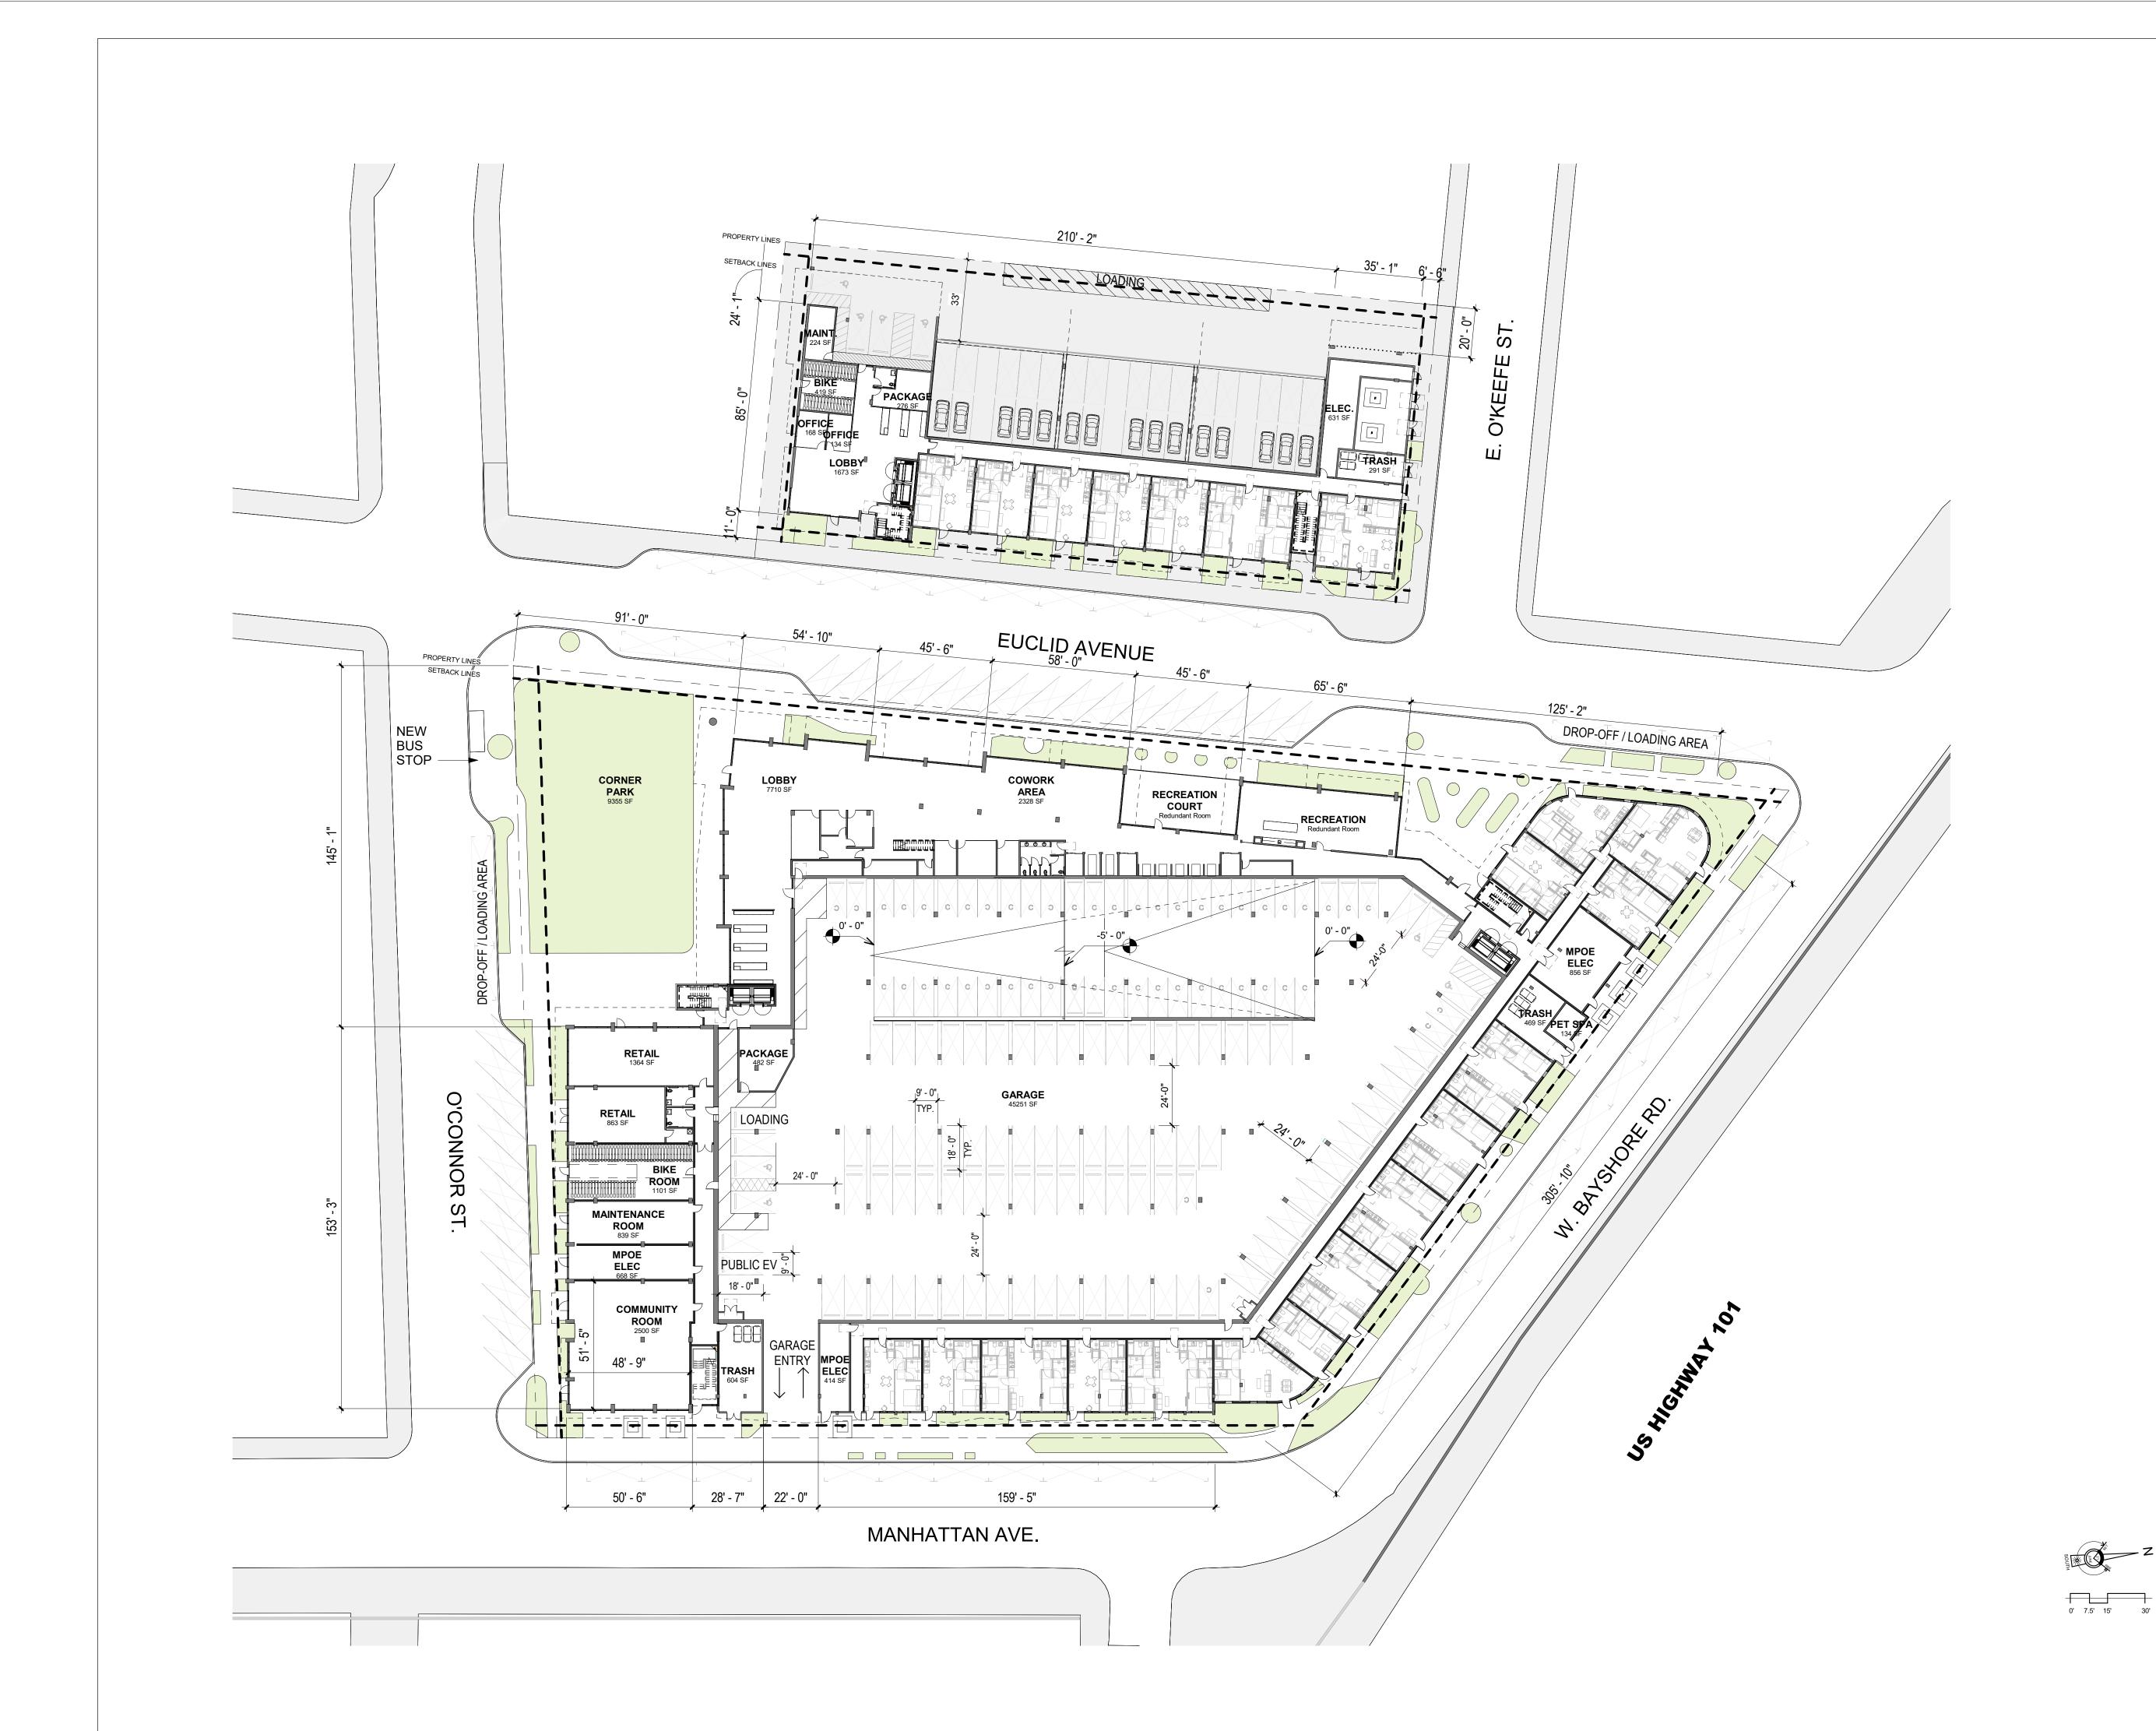
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**Drawing Title** 

SITE PLAN -PROPOSED

A-101





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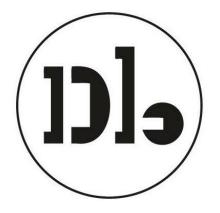
FLOOR PLAN -LEVEL 1

Sheet No.

A-201

# 53' - 1" 157' - 1" OPEN TO BELOW GROUP FITNESS 966 SF 29' - 8" 20' - 3" 195' - 4" 158' - 4" 45' - 6" 125' - 1" OPEN TO BELOW OPEN TO -BELOW MEDIA LOUNGE 544 SF OPEN TO / BELOW POOL / SERVICE 1277 SF BIKE ROOM = = = 210' - 0" 50' - 6" 0' 7.5' 15' 30'

# Woodland Park Euclid Improvements



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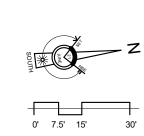
FLOOR PLAN -LEVEL 2

A-202


04/18/2024 21620

Project No.

# 157' - 0" COURTYARD **RECREATION** 29' - 8" 173' - 7" 42' - 11" 69' - 0" 73' - 9" 87' - 3" POOL DECK 6961 SF GROUP FITNESS 1039 SF 209' - 4" 50' - 6"



# Woodland Park Euclid Improvements

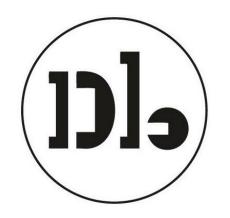

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	Issuances
Description	Date
Entitlements Update	2/27/2024

		INCVISIONS
Rev.	Description	Date

1 Response to Comments 4/19/2024

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Design Update -April 2024


**Drawing Title** 

FLOOR PLAN -LEVEL 3


A-203

# 211'-5" PROPERTY LINES SETBACK LINES 10-0" 31'-2" 173'-5" 42'-11'



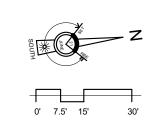

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Rev.	Description	Date
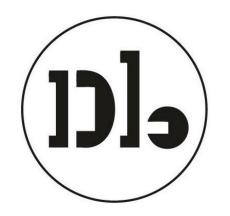
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Design Update -April 2024


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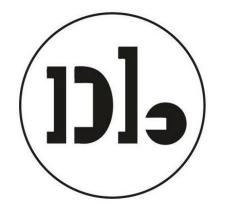
FLOOR PLAN -LEVEL 4

Sheet No.

A-204

# 31' - 1" 19' - 10" 74' - 9" 69' - 0" 73' - 9" 10' - 0" 52' - 5" 209' - 7"



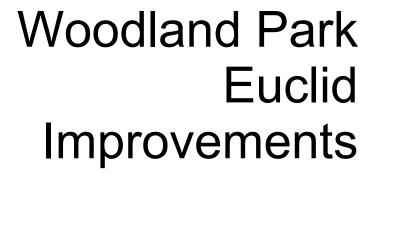

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Drawing Title

FLOOR PLAN -LEVELS 5-7

A-205


 Date
 04/18/2024

 Project No.
 21620

0' 7.5' 15' 30'

# PROPERTY LINES 211'-5" 36'-7' SETRACK LINES CLUBHOUSE 908 SF ROOF DECK 2141 SF 31'-1" 19'-10" 162'-5" 34'-7"



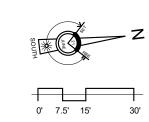

# Woodland Park Euclid Improvements



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		LENBIOLIS
Rev.	Description	Date

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Set Tit

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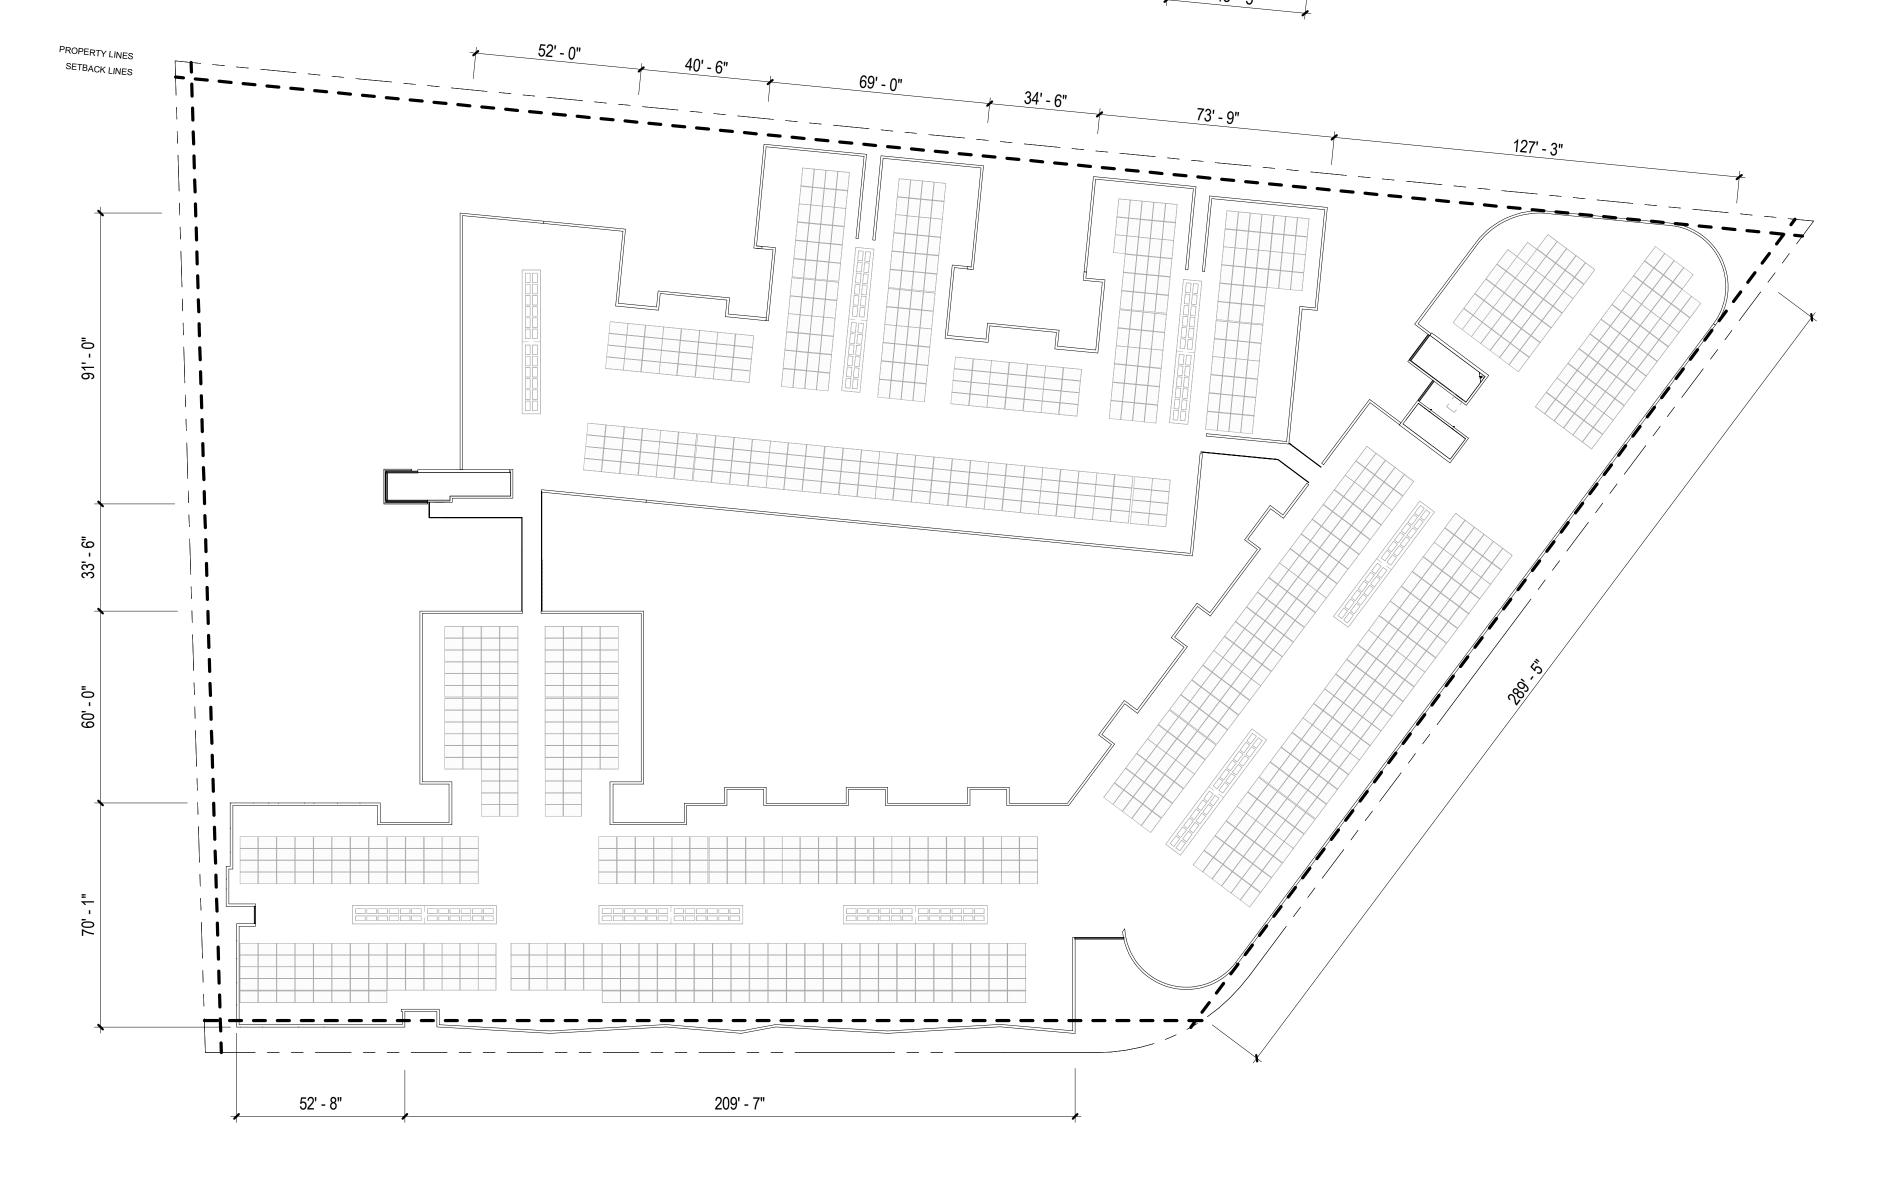
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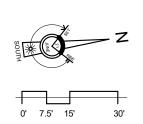
FLOOR PLAN -LEVELS 8

A 000


A-206

# PROPERTY LINES 194' - 11" 36' - 7" SETBACK LINES 34' - 5" 153' - 7" 43' - 5"





# Woodland Park Euclid Improvements

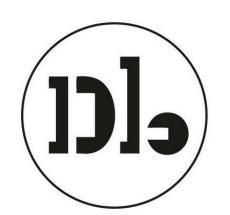

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Description	Date
Entitlements Update	2/27/2024

		Revisions
Rev.	Description	Date
		-

1 Response to Comments 4/19/2024

Set Tit

Design Update -April 2024

**Drawing Title** 

FLOOR PLAN -ROOF

Sheet No.
A-207

Date 04/18/2024 Project No. 21620

#### **MATERIAL LEGEND**

- 1 Textured Concrete with Vine Cover
- 2 Vertical Wood Siding
- 3 Storefront System4 Cement Board (Dark)
- 5 Cement Board (Light)
- 6 Perforated Metal Screen (Painted)
- 7 GFRC
- 8 Thin Brick
- 9 Aluminum Windows
- 10 Balconies with Perforated Metal Guardrails
- 11 Corten Steel Panels12 Smooth Concrete
- 13 Metal Sunshade
- 14 Standing Seam Steel



MANHATTAN AVE.

Key Plan
1" = 160'-0"


NOTE: PLEASE REFER TO LANDSCAPE PLAN FOR PLANTING LOCATIONS







# Woodland Park Euclid Improvements

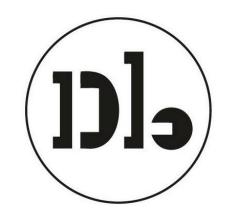

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Description	Date
Entitlements Update	2/27/2024

		Revisions
Rev.	Description	Date

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Design Update -April 2024

**Drawing Title** 


BUILDING **ELEVATIONS** 

> Sheet No. A-300

04/18/2024 Project No. 21620

#### **MATERIAL LEGEND**

- 1 Textured Concrete with Vine Cover
- 2 Vertical Wood Siding
- 3 Storefront System4 Cement Board (Dark)
- 5 Cement Board (Light)
- 6 Perforated Metal Screen (Painted)
- 7 GFRC
- 8 Thin Brick
- 9 Aluminum Windows
- 10 Balconies with Perforated Metal Guardrails
- 11 Corten Steel Panels12 Smooth Concrete
- 13 Metal Sunshade
- 14 Standing Seam Steel

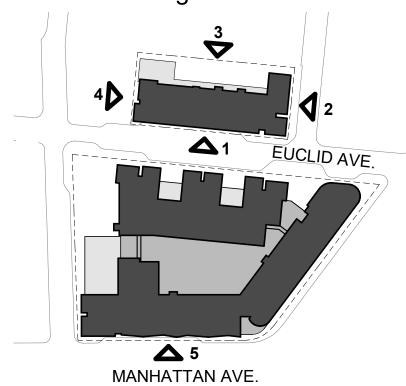

Key Plan
1" = 160'-0"

NOTE: PLEASE REFER TO LANDSCAPE PLAN FOR PLANTING LOCATIONS










BUILDING A - WEST ELEVATION Copy 1
1" = 30'-0"





# Woodland Park Euclid Improvements

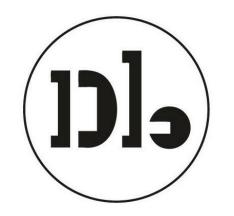

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	Issuances
Description	Date
Entitlements Update	2/27/2024

		Revisions
Rev.	Description	Date
		-

1 Response to Comments 4/19/2024

Design Update -**April 2024** 

**Drawing Title** 

BUILDING **ELEVATIONS** 

A-301


04/18/2024 Project No. 21620




MANHATTAN AVE.

Key Plan


1" = 160'-0"

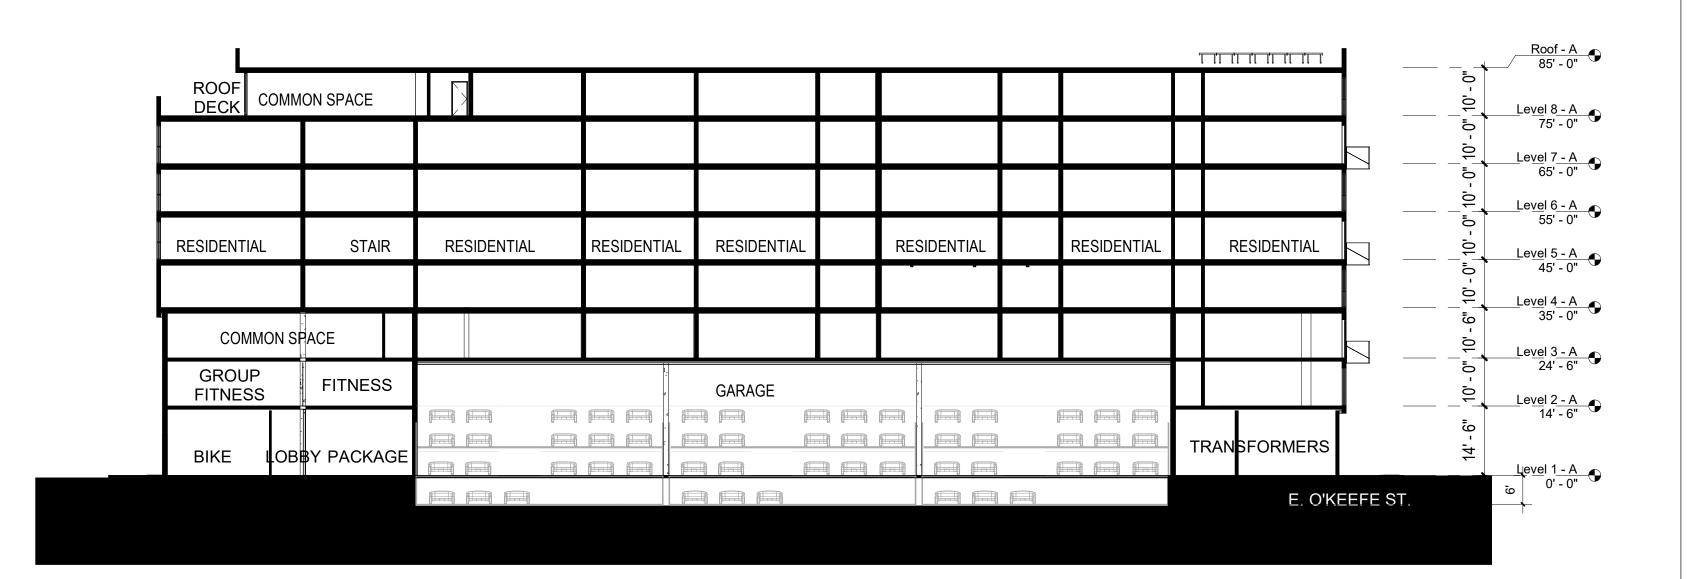


Building Section - N/S West Building
1" = 20'-0"

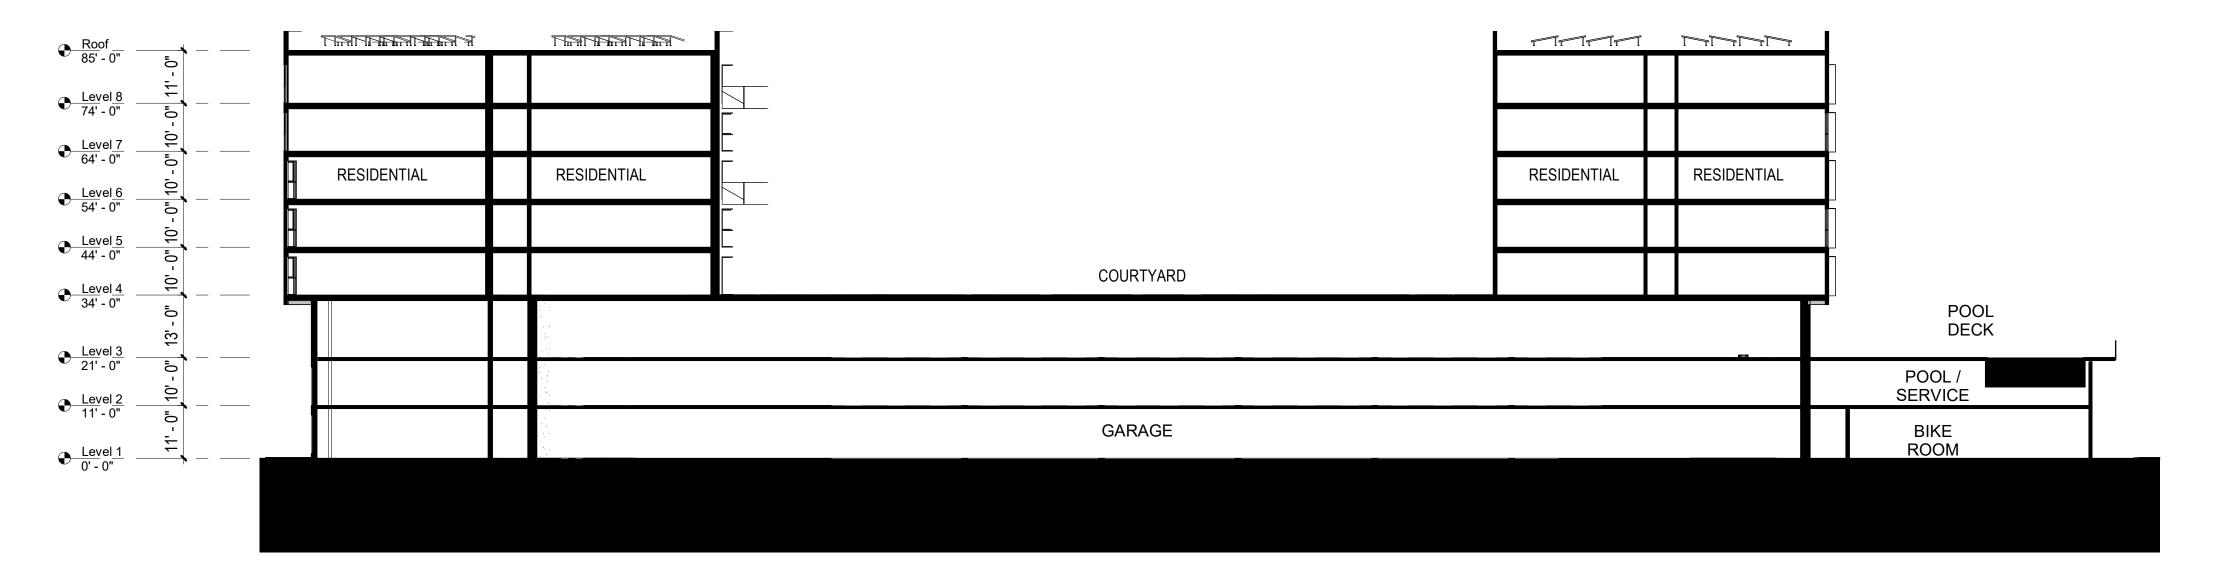

Building Section - N/S
1" = 20'-0"

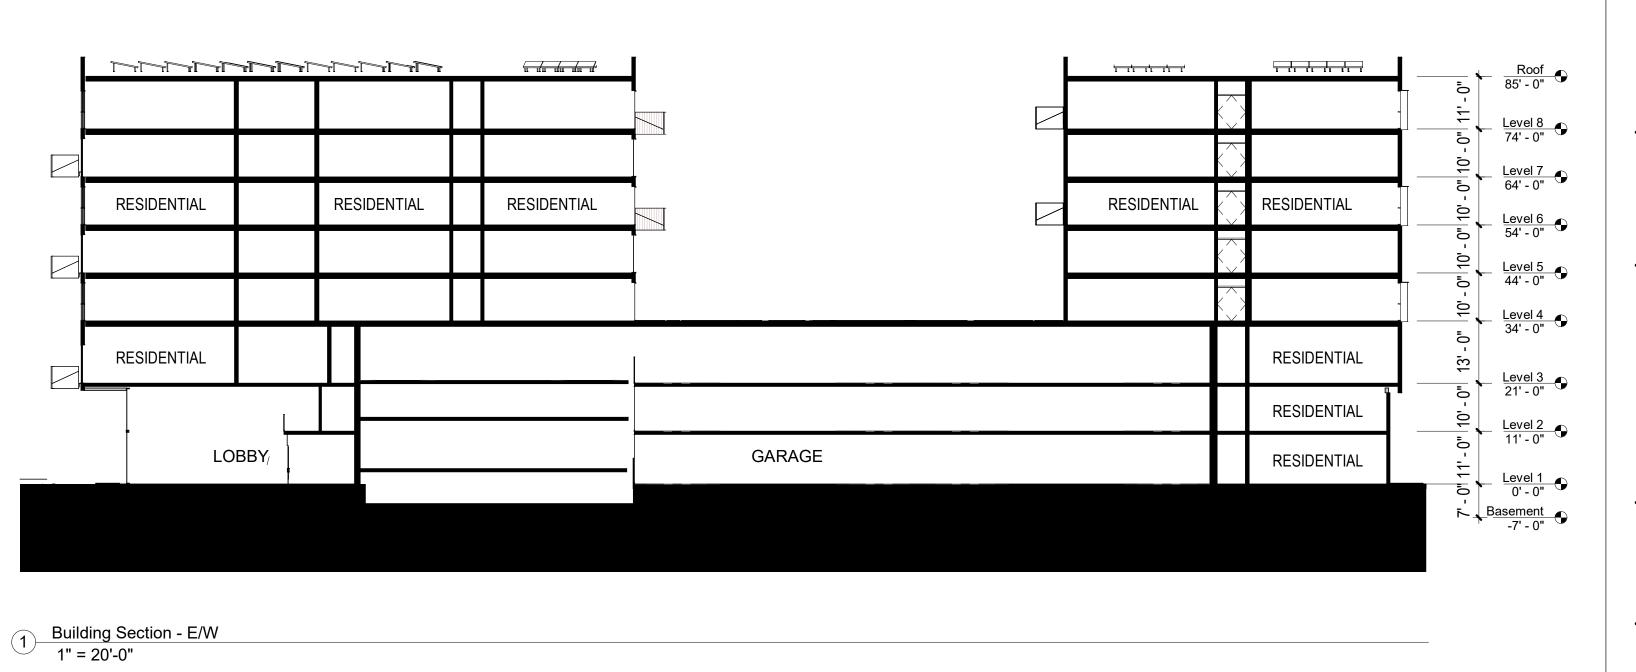

# Woodland Park Euclid Improvements

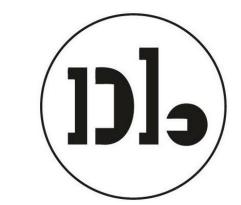

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Description	Date
Entitlements Update	2/27/2024

		Revisions
ev.	Description	Date
		-

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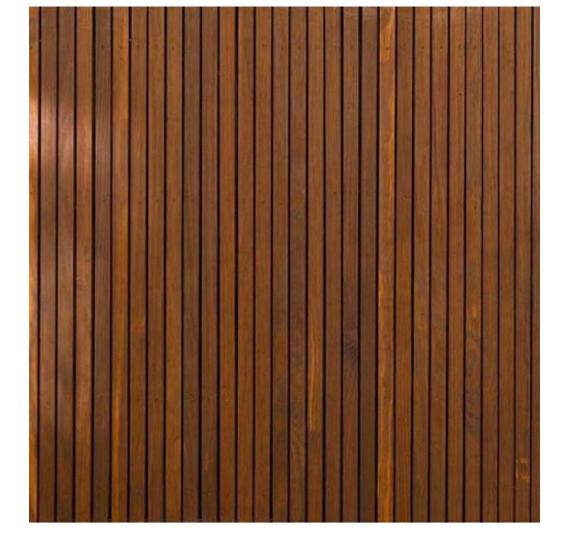
Design Update -April 2024

Drawing Title

BUILDING SECTIONS

Sheet No. **A-302** 


1 - Textured Concrete with Vine Cover




2 - Vertical Wood Siding




3 - Storefront System

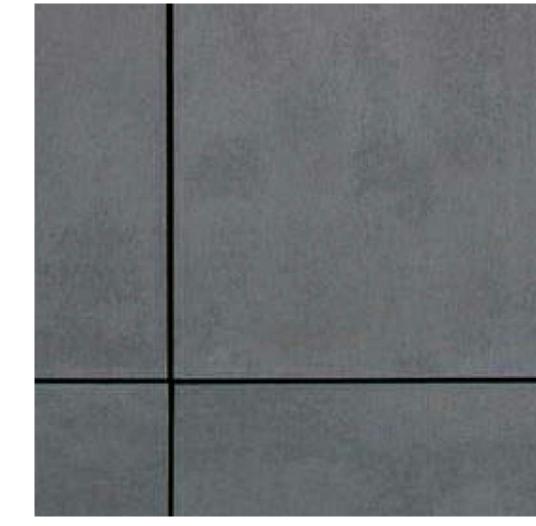

4 - Cement Board (Dark)

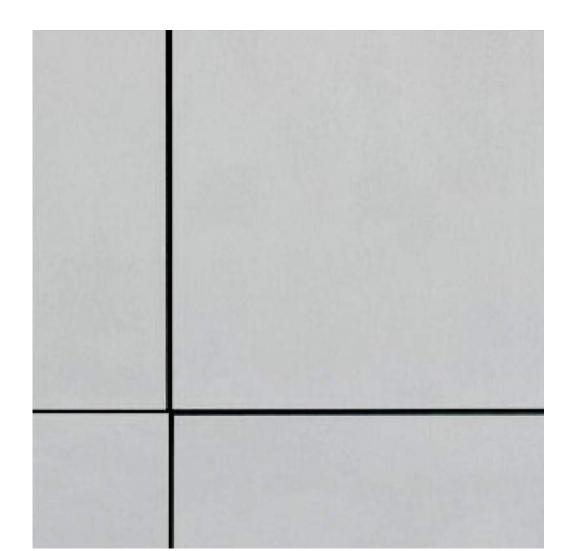


5 - Cement Board (Light)

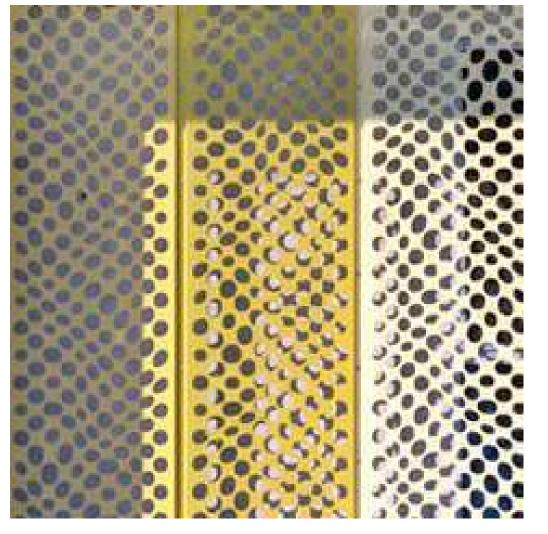


6 - Perforated Metal Screen (Painted)




7 - GFRC

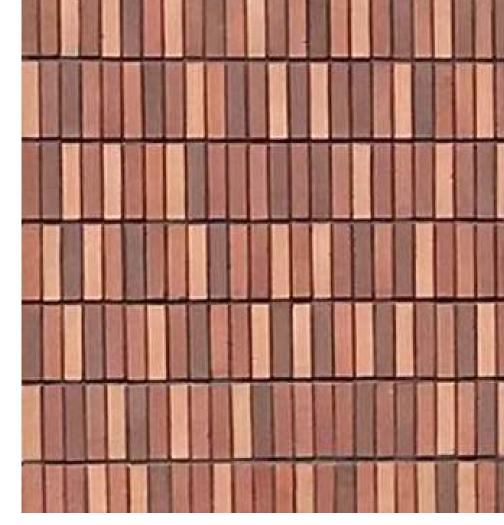

8 - Thin Brick

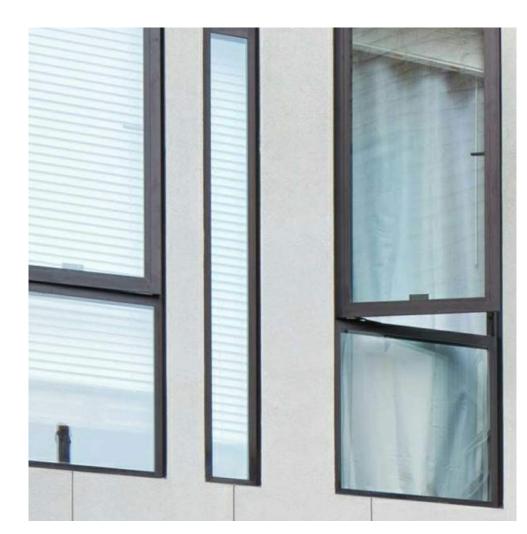


9 - Aluminum Windows

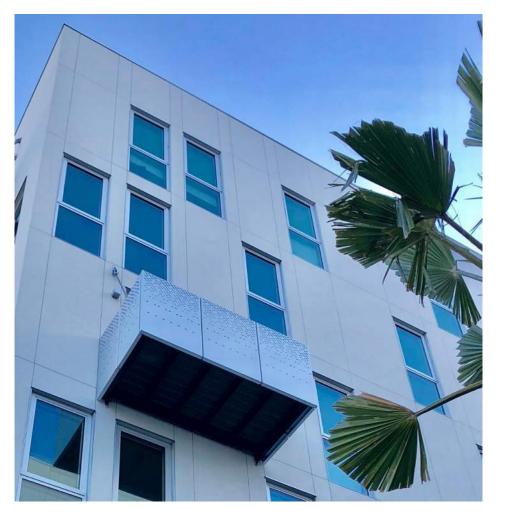


10 - Balconies with Perforated Metal Guardrails



11 - Corten Steel Panels

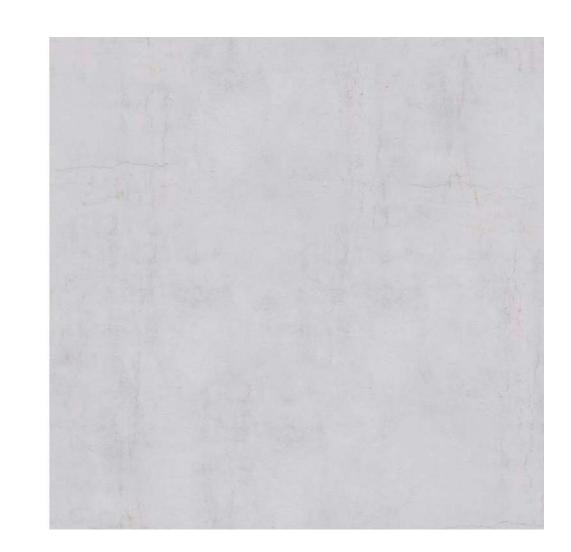

12 - Smooth Concrete

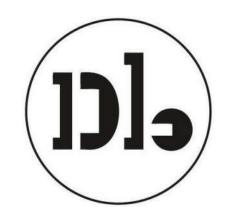

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#### PREVIOUSLY SUBMITTED SHEET NO CHANGE

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	Issuances
Description	Date
Entitlements Update	1/8/2024

		Revisions
ev.	Description	Date

Set Title

Entitlements -January 2024

Drawing Title

EXTERIOR MATERIALS

A303

 Date
 12-08-2023


 Project No.
 21620





L1 DECORATIVE BOLLARD LIGHT

O

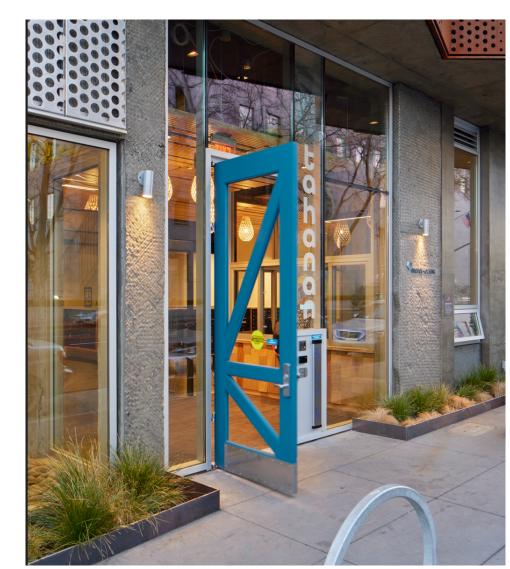

2 WALL MOUNTED DOWN LIGHT



HANGING STRING "FESTOON-STYLE" LIGHTS


NOTES:

1. OUTDOOR LIGHTING WILL COMPLY WITH EPAMC 18.22.050
2. OUTDOOR LIGHTING LEVELS WILL COMPLY WITH EPAMC 18.22.050 (C)

3. OUTDOOR LIGHTING WILL BE DESIGNED TO MINIMIZE ADVERSIE IMPACTS ON ADJACENT PROPERTIES AND TO NOT PRODUCE GLARE ONTO ADJACENT PROPERTIES OR ROADWAYS.

4. PARKING AREA LIGHT FIXTURES AND LIGHT FIXTURES ON STRUCTURES
SHALL BE FULL CUT-OFF FIXTURES

# Woodland Park Euclid Improvements

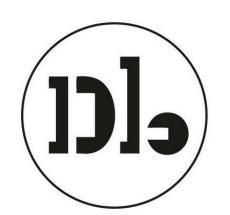

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		Revisions
Rev.	Description	Date

1 Response to Comments 4/19/2024

Set Title

Design Update -April 2024

Drawing Title

CONCEPTUAL LIGHTING PLAN

Sheet No.

A-511

# OPEN SPACE -PUBLIC 1335 SF 80'-2" OPEN SPACE -**PUBLIC** 7400 SF CORNER PARK OPEN SPACE PUBLIC PLAZA 9355 SF OPEN SPACE -1372 SF OPEN SPACE -PRIVATE 1 LEVEL 1 PLAN - OPEN SPACE DIAGRAM 1" = 50' 0" 1" = 50'-0"



#### EAST PALO ALTO DEVELOPMENT CODE 18.08.010:

Common Open Space. The land area within a residential or nonresidential development not individually owned or dedicated for public use and designed, intended, and reserved exclusively for the shared enjoyment or use by all the residents and their guests. Does not include enclosed spaces/facilities (e.g., community center, meeting rooms, etc.)

Private Open Space. An outdoor or unenclosed area directly adjoining and accessible to a dwelling unit, reserved for the exclusive private enjoyment and use of residents of the dwelling unit and their guests (e.g., balcony, deck, porch, terrace, etc.). Boundaries are evident through the use of fences, gates, hedges, walls, or other similar methods of controlling access and maintaining privacy.

Publicly Accessible / Usable Open Space. An outdoor or unenclosed area within a residential development on the ground, or on a roof, balcony, deck, porch or terrace, designed and accessible for outdoor living, active or passive recreation, pedestrian access, or landscaping. Parking facilities, driveways, utility or service areas and submerged land do not constitute usable open space.

#### **OPEN SPACE - PROVIDED**

#### WEST PARCEL (BUILDING A)

#### **COMMON:**

Level 3	OPEN SPACE - COMMON	2,085 SF
Level 8	OPEN SPACE - COMMON	2,318 SF
		4,403 SF

#### PRIVATE:

#### (BALCONIES)

evel 1	OPEN SPACE - PRIVATE	1	2,192 5
evel 2	OPEN SPACE - PRIVATE	2	84 5
evel 3	OPEN SPACE - PRIVATE	7	1,636 S
evel 4	OPEN SPACE - PRIVATE	11	510 S
evel 5	OPEN SPACE - PRIVATE	12	559 S
evel 6	OPEN SPACE - PRIVATE	12	558 S
evel 7	OPEN SPACE - PRIVATE	12	559 S
evel 8	OPEN SPACE - PRIVATE	9	414 S
		66	6,510 S

WEST PARCEL GRAND TOTAL 10,913 SF

#### **USABLE / PUBLIC:**

Level 1	OPEN SPACE - PUBLIC	1,913 SF
		1,913 SF

EAST PARCEL (BUILDING B)

#### COMMON:

Level 1	OPEN SPACE - COMMON	1,090 SF
Level 3	OPEN SPACE - COMMON	6,352 SF
Level 4	OPEN SPACE - COMMON	17,018 SF
Level 8	OPEN SPACE - COMMON	3,251 SF
	-	27 711 SF

#### PRIVATE:

#### (BALCONIES)


Level 1	OPEN SPACE - PRIVATE	2	5,130 S
Level 3	OPEN SPACE - PRIVATE	14	3,137 S
Level 4	OPEN SPACE - PRIVATE	49	2,978 S
Level 5	OPEN SPACE - PRIVATE	40	2,071 S
Level 6	OPEN SPACE - PRIVATE	34	1,782 S
Level 7	OPEN SPACE - PRIVATE	40	2,071 S
Level 8	OPEN SPACE - PRIVATE	31	1,638 S
		210	18,808 S

EAST PARCEL GRAND TOTAL 46,519 SF

#### **USABLE / PUBLIC:**

Level 1	OPEN SPACE - PUBLIC	18,127 SF
		18,127 SF

# Woodland Park Euclid Improvements

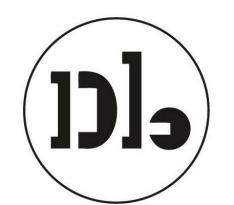

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		Revision
Rev.	Description	Dat

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Design Update -April 2024

**Drawing Title** 

**OPEN SPACE** DIAGRAMS

04/18/2024 Project No. 21620

#### PROJECT TOTAL:

TOTAL OPEN SPACE PROVIDED: 10,913 SF + 46,519 SF = 57,432 SF TOTAL (104 SF PER UNIT)

#### OPEN SPACE -OPEN SPACE -PRIVATE OPEN SPACE -PRIVATE – 48 SF OPEN SPACE -PRIVATE PRIVATE 48 SF PRIVATE 42 SF OPEN SPACE -PRIVATE -48 SF OPEN SPACE -PEN SPACE PRIVATE OPEN SPACE PRIVATE OPEN SPACE PRIVATE PRIVATE PRIVATE OPEN SPACE -48 SF OPEN SPACE - OPEN SPACE - PRIVATE OPEN SPACE -PRIVATE -48 SF PRIVATE OPEN SPACE -— PRIVATE 48 SF OPEN SPACE - PRIVATE G PRIVATE PEN SPACE - PEN SPACE - PEN SPACE - PRIVATE - PRIVATE - PRIVATE - PRIVATE - PRIVATE - 48 SF OPEN SPACE -PRIVATE -



48 SF

OPEN SPACE - 75 SF PRIVATE

OPEN SPACE -

PRIVATE

OPEN SPACE - | PRIVATE -48 SF

OPEN SPACE -PRIVATE

OPEN SPAC

PRIVATE 48 SF

OPEN SPACE - OPEN SPACE - OPEN SPACE -

PRIVATE

48 SF




OPEN SPACE -COMMON

165'

PRIVATE

48 SF

# Woodland Park Euclid Improvements

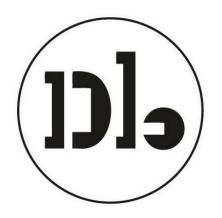

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Description	Date
Entitlements Update	2/27/2024

		Revisions
Rev.	Description	Date

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Design Update -April 2024


**Drawing Title** 

OPEN SPACE DIAGRAMS

A-502

Project No.

04/18/2024 21620

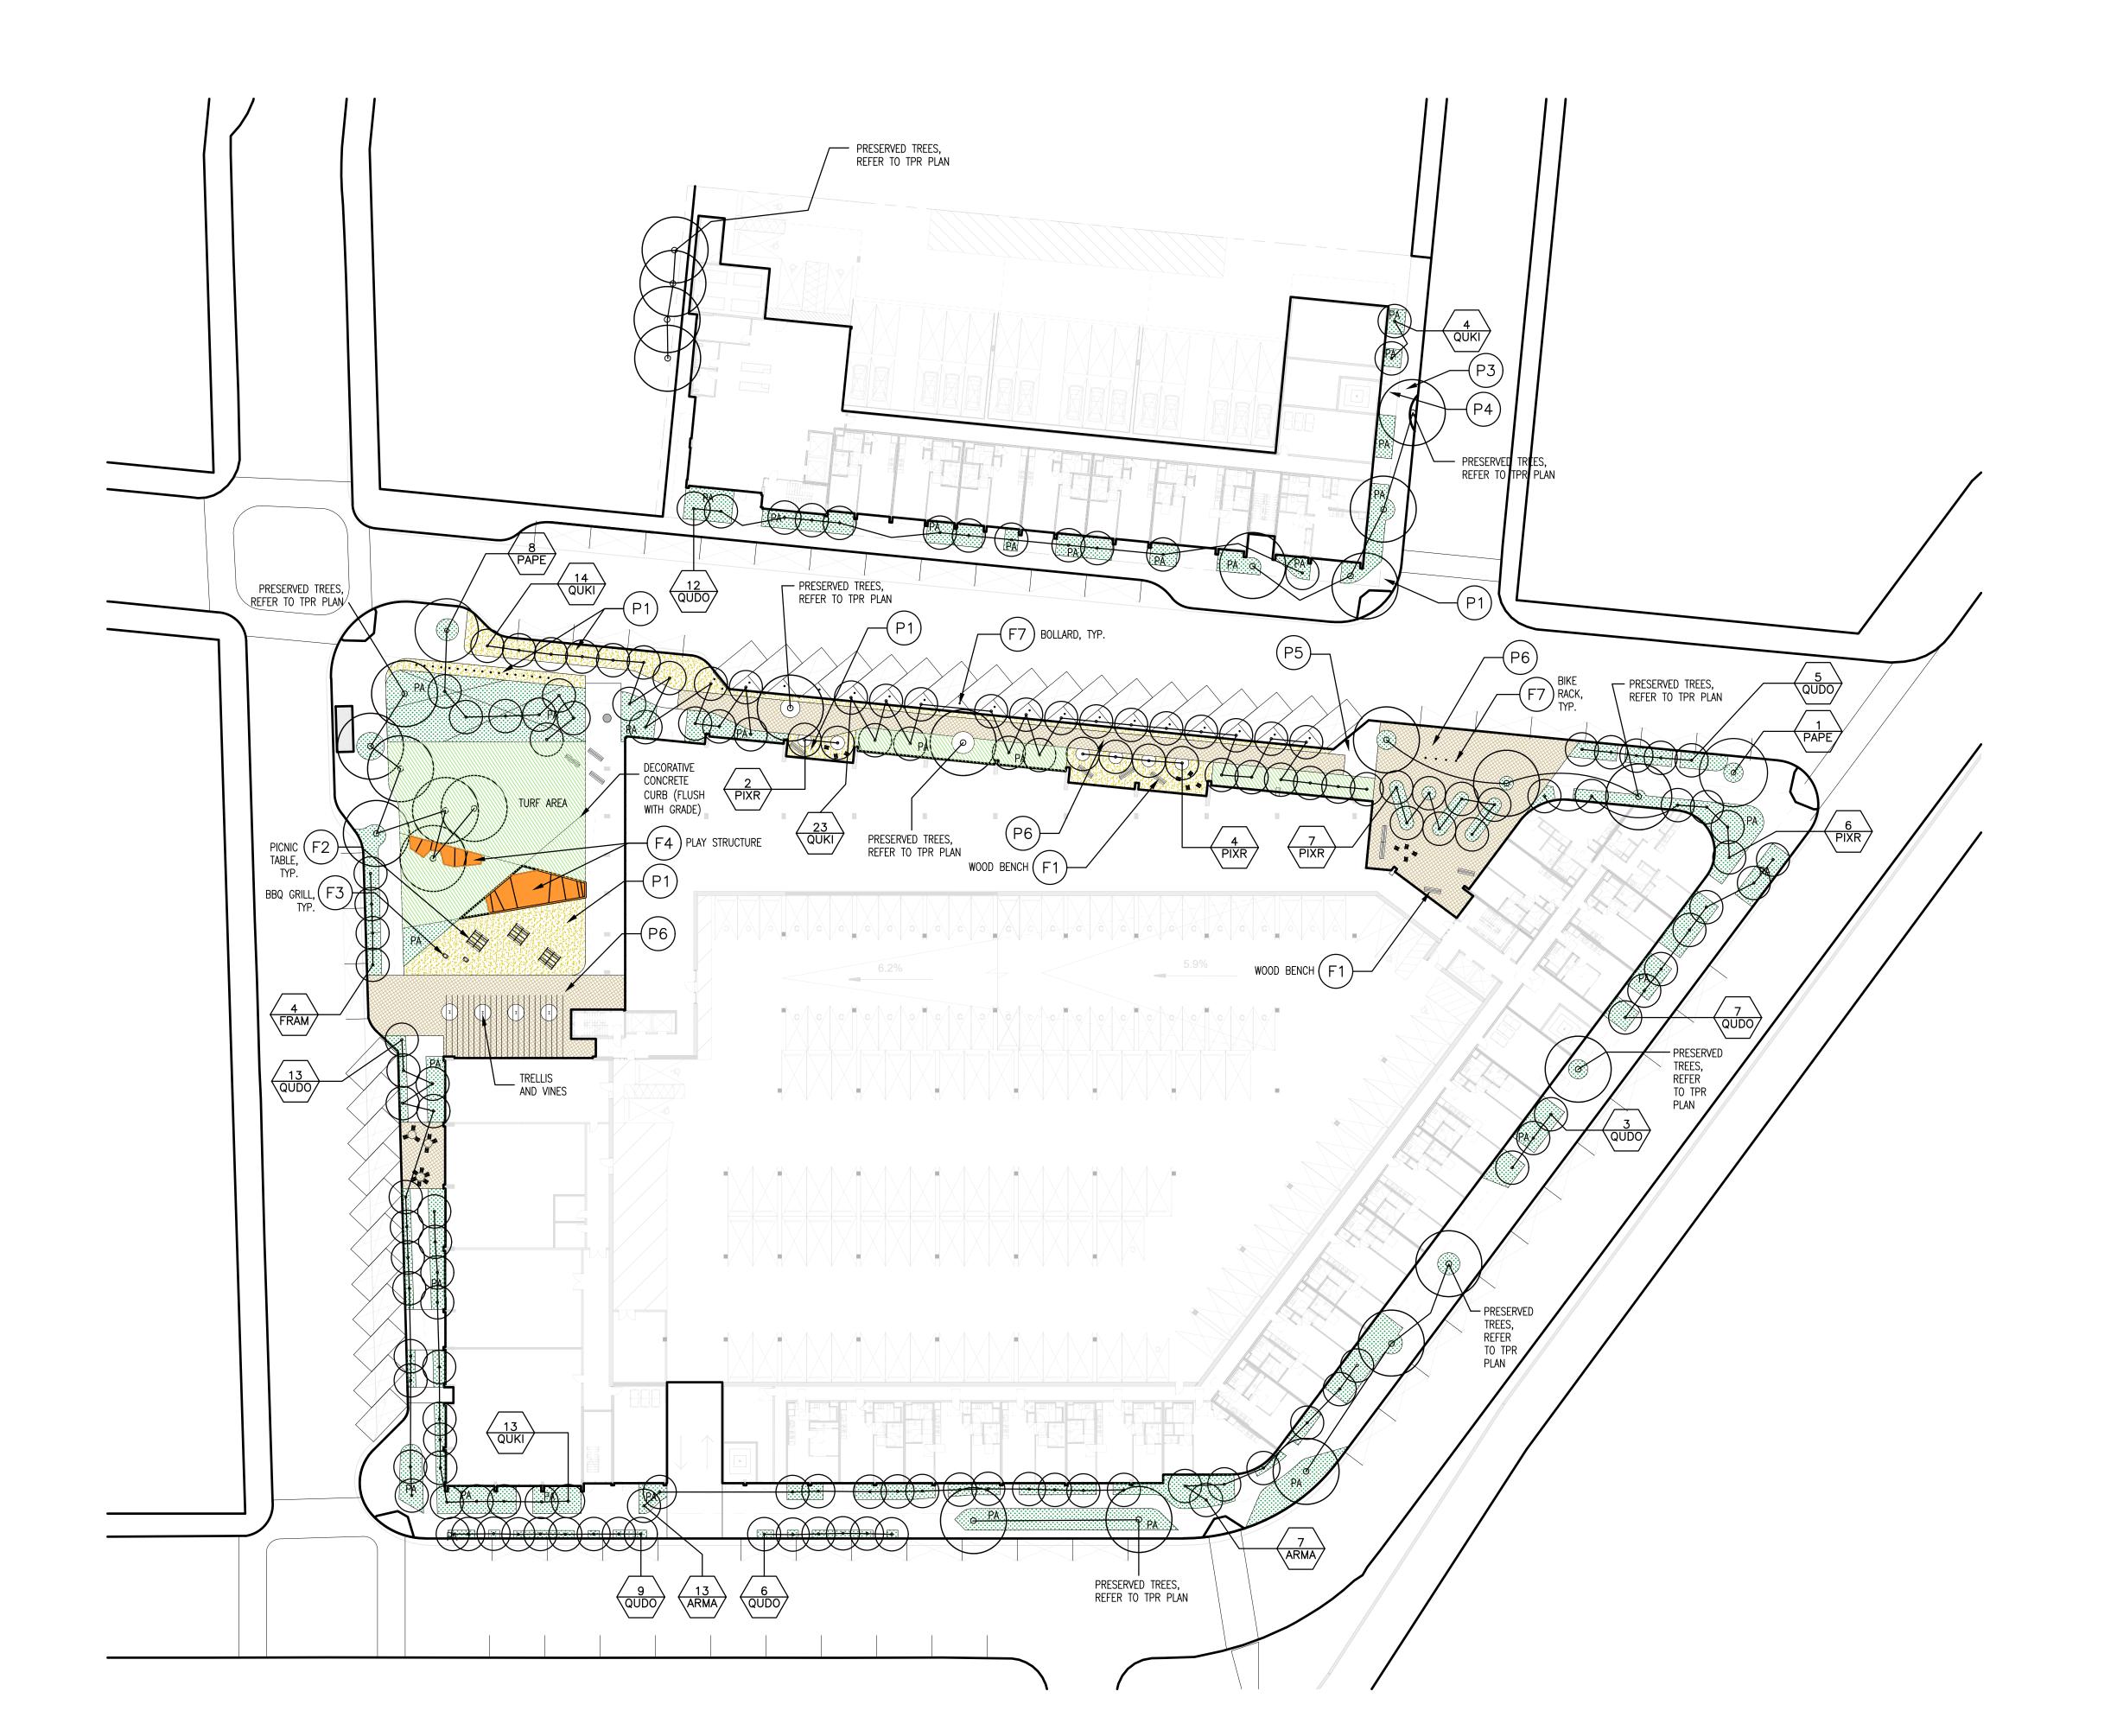

#### LEGEND:

LEGEN <u>PAVIN</u>		
KEY	SYMBOL	DESCRIPTION / LOCATION
P1		DECOMPOSED GRANITE
P2	0000	GRAVEL
P3		CIP CONCRETE
P4		ASPHALT BLOCK PAVER
P5		CIP COLORED CONCRETE
P6		STONE PAVERS
<u>FURNI</u>	SHINGS	
KEY	SYMBOL	DESCRIPTION / LOCATION
F1		WOOD BENCH
F2		PICNIC TABLE
F3		BBQ GRILL
F4		CUSTOM PLAY AND SEATING STRUCTURE
F5		CURVED CONCRETE BENCH
F6		GARDEN BED
F7	o	BIKE RACK / BOLLARD
LIGHT	FIXTURES	
key   PLANT	SYMBOL LIST	DESCRIPTION / LOCATION
TREES		
KEY	SYMBOL	COMMON NAME
	The state of the s	PROTECTED TREE
FRAM	The state of the s	WHITE ASH
ARMA	$\odot$	MARINA STRAWBERRY
QUDO	•	BLUE OAK
PIXR	$\odot$	RED PUSH PISTACHE
QUKI	$\odot$	KINDRED SPIRIT OAK
PAPE	Manager of the second of the s	IRONWOOD

PA PLANTING AREA

# Woodland Park Euclid Improvements



David Baker Architects

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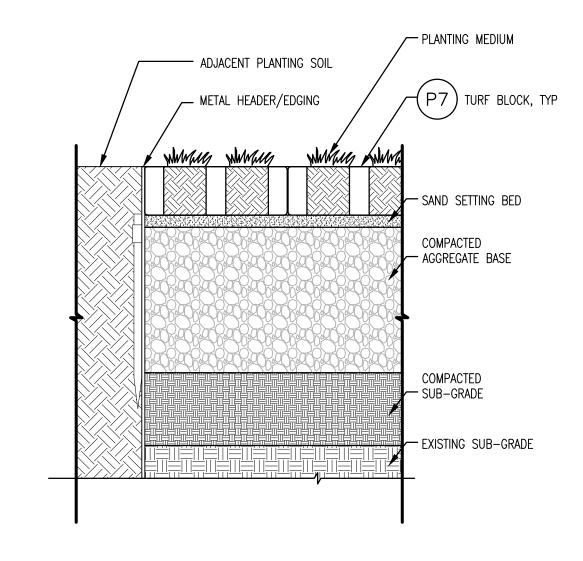
Entitlements
Application

Drawing Title


Landscape Site Plan

Sheet No.


Date 27 February, 2024 Project No. 21620



# 5 P7 - ECO-GRID PAVER AT PLANTING SCALE: 1-1/2" = 1' - 0"

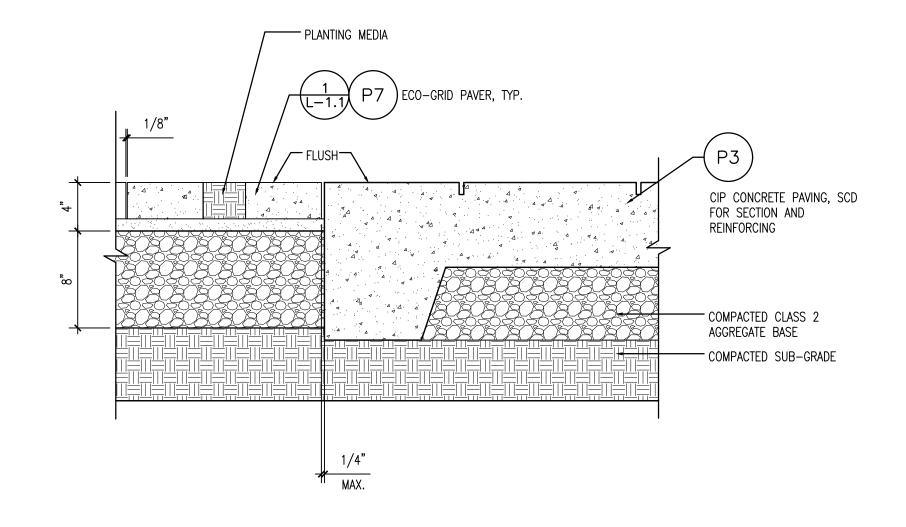

# 4 P7 - ECO-GRID PAVER AT CONCRETE PAVING SCALE: 1-1/2" = 1' - 0"

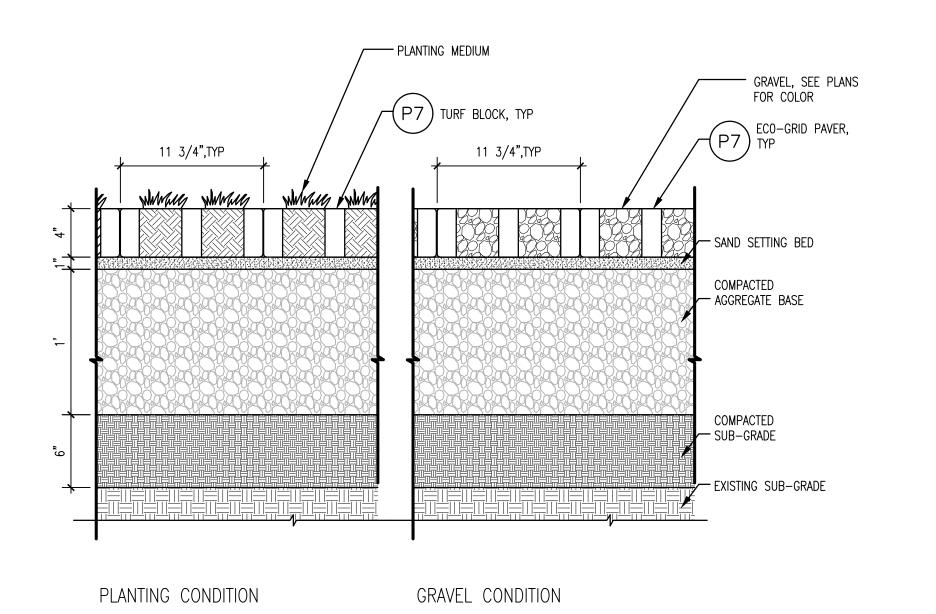


3 P7 - ECO-GRID PAVER, TYPICAL SCALE: 1-1/2" = 1' - 0"










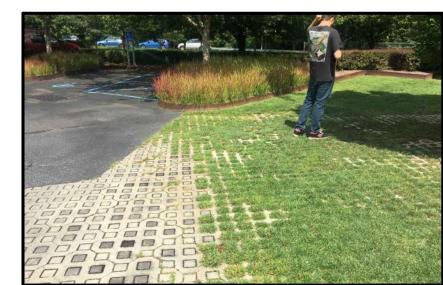







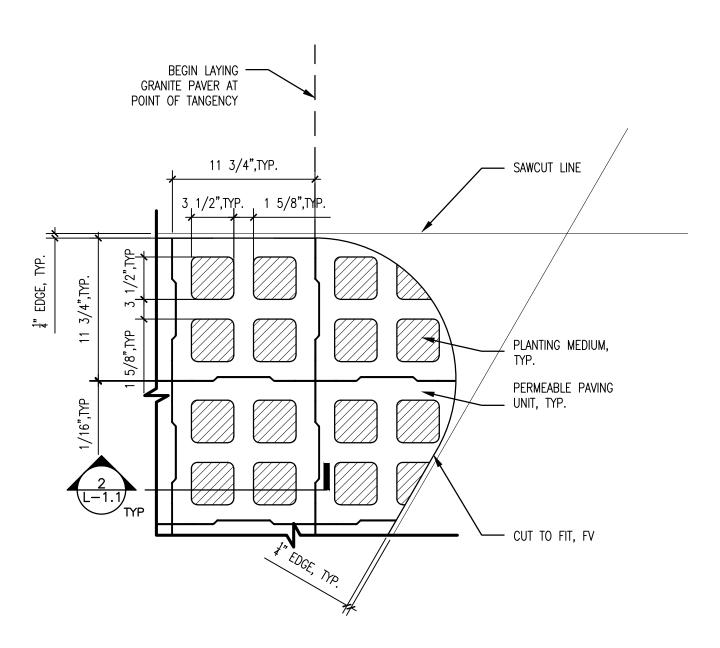

1 P7 - ECO-GRID PAVERS FOR FLEX PARKING AREA SCALE: 1-1/2" = 1' - 0"

# Woodland Park Euclid Improvements



David Baker Architects

dbarchitect.com 461 Second St, Loft c127 San Francisco, CA 94107 415.896.6700



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3016 FILBERT street
studio 2
DAKLAND, CA 94608
510 . 595 0688
www.hooddesignstudio.com

Description Issuances

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Design Update -February 2024

Drawing Title

Landscape Details

Sheet No.

Date 27 February, 2024 Project No. 21620

#### **GENERAL NOTES**

- 1. ALL TREE REMOVAL WORK SHALL BE PERFORMED IN CONFORMANCE WITH APPLICABLE LOCAL CODES AND
- 2. ALL ADDITIONAL REQUIREMENTS FOR TREE PROTECTION AND MITIGATION AS REQUIRED BY THE CITY ARBORIST AND THE PROJECT ARBORIST SHALL BE FOLLOWED. REFERENCE CITY OF SANTA CLARA ARBORIST NOTES AND PROJECT ARBORIST NOTES.
- 3. CONTRACTOR SHALL VISIT THE SITE WITH OWNER'S REPRESENTATIVES PRIOR TO BEGINNING ANY WORK. VERIFY ALL TREES, SHRUBS & VEGETATION WITHIN THE LIMITS OF WORK TO BE REMOVED AND ALL TREES & PLANTS TO REMAIN AND TO BE PROTECTED.
- 4. ALL TREES AND PLANTS DESIGNATED TO REMAIN SHALL BE PROTECTED FROM PHYSICAL DAMAGE AND MAINTAINED THROUGHOUT THE DURATION OF THE CONTRACT. THOSE TREES AND PLANTS INDICATED TO BE REMOVED SHALL BE COMPLETELY REMOVED, INCLUDING THE ROOTS, AND DISPOSED OF OFF-SITE. BACKFILL EXCAVATED AREAS TO RESTORE TO EXISTING GRADE.
- 5. PROTECTIVE FENCING: TEMPORARY FENCES OR BARRICADES SHALL BE INSTALLED AS SHOWN ON THE DRAWINGS OR AS DIRECTED IN THE FIELD BY THE PROJECT ARBORIST OR THE OWNER'S REPRESENTATIVE. FENCING SHALL BE A MINIMUM OF SIX (6) FOOT HEIGHT, CHAIN LINK. MAINTAIN FENCING IN CONTINUOUS, STABLE AND UPRIGHT CONDITION AT ALL TIMES.
- 6. CONTRACTOR SHALL REMOVE FROM THE SITE ALL DEBRIS AND UNSUITABLE MATERIAL GENERATED FROM CONSTRUCTION AND DISPOSE OF IN A LAWFUL MANNER.

#### PROJECT ARBORIST NOTES

1. THE TREE PRESERVATION GUIDELINES ARE SUPERSEDED BY THE CITY OF SANTA CLARA ARBORIST NOTES INCLUDED IN THE DOCUMENTS PROVIDED. THIS INCLUDES CITY TREE DAMAGE PENALTIES IN THE CASE THAT TREES DIE OR ARE DAMAGED DUE TO FAILURE TO PROVIDE ADEQUATE PROTECTIONS. CITY REQUIRES THAT ARBORIST SUPERVISION OF PROJECT TREE PROTECTION BE CONDUCTED BY CITY ARBORIST OR ARBORIST EMPLOYED BY CITY.

2. THESE GUIDELINES PROVIDE FOR THE CARE AND MAINTENANCE OF THE TREE(S) BEFORE, DURING AND AFTER CONSTRUCTION ACTIVITIES. THE GOAL OF TREE PROTECTION AND PRESERVATION IS TO PROVIDE FOR A SUCCESSFUL TRANSITION TO A MODIFIED SITE.

3. TO BE MOST EFFECTIVE, TREE PRESERVATION AND HEALTH MITIGATION MEASURES MUST COMMENCE WELL BEFORE THE TIME OF DISTURBANCE AS HEALTHY TREES ARE MORE LIKELY TO SURVIVE ADVERSE IMPACTS.

4. TO BE EFFECTIVE, PROJECT ARBORIST MUST HAVE THE ABILITY TO ASSURE THE GUIDELINES ARE OBSERVED AND HAVE THE ABILITY TO HALT ALL CONSTRUCTION ACTIVITIES IF TRANSGRESSIONS OCCUR.

5. PROJECT CONSTRUCTION DOCUMENTS MUST ACCURATELY SHOW TREE PROTECTION AREAS AND SPECIFY PROTOCOL AND PROCEDURES TO BE USED FOR ALL ACTIVITIES WITHIN THE DESIGNATED TREE PROTECTION AREA.

#### SITE ANALYSIS AND EARLY TREE HEALTH MITIGATION

6. THE INFORMATION GAINED FROM SITE ANALYSIS IS UTILIZED FOR ROOT AND SOIL PROTECTION AND TO ASSURE THAT ADEQUATE MITIGATION TREATMENTS ARE

7. SOIL PROFILE EXAMINATION – THE SOIL PROFILE EXAMINATION DETERMINES SOIL TEXTURE AND MOISTURE LEVELS. SOIL COMPACTION IS ALSO ASSESSED. THIS INFORMATION IS VITAL TO THE UNDERSTANDING OF THE LEVEL OF SOIL PROTECTION AND MITIGATION THAT WILL BE NECESSARY.

8. LABORATORY ANALYSIS - ANALYSIS OF SOIL AND PLANT TISSUE SAMPLES CAN HELP GUIDE THE USE OF SOIL AMENDMENTS AND FERTILIZATION.

9. ROOT INVESTIGATION - UNDERSTANDING THE DEPTH, SIZE AND AMOUNT OF ROOTS PRESENT IS REQUIRED TO HELP GUIDE PROJECT DESIGN AND ANTICIPATE WHEN A TREE IS UNLIKELY TO SURVIVE.

10. MITIGATION OF LIMITATIONS IDENTIFIED - LIMITATIONS IDENTIFIED DURING SITE ANALYSIS ACTIVITIES ARE BEST MITIGATED PRIOR TO THE BEGINNING OF CONSTRUCTION ACTIVITIES. POSSIBLE LIMITATIONS TO BE MITIGATED INCLUDE SOIL COMPACTION, NUTRITIONAL DEFICIENCIES AND INSUFFICIENT OR EXCESS SOIL MOISTURE. MOST BASIC MITIGATION ENTAILS: IRRIGATION, MULCHING, WATER JET AND AIR SPADE PROCEDURES. SOIL AMENDMENTS OTHER THAN GOOD QUALITY MULCH MUST BE BASED UPON LABORATORY SOIL AND/OR TISSUE ANALYSIS.

#### PRE-CONSTRUCTION ACTIVITIES

11. THESE ACTIVITIES SHOULD BE UNDERTAKEN PRIOR TO INITIATION OF CONSTRUCTION ACTIVITY.

12. MULCHING – USE OF GOOD QUALITY ORGANIC MULCH (WOOD CHIPS ARE BEST) ON SOIL SURFACE HELPS TO REDUCE SOIL COMPACTION AND RETAIN SOIL MOISTURE. RECOMMENDED MATERIAL IS WOOD CHIPS GENERATED FROM TREE TRIMMING. FRESH REDWOOD, INCENSE CEDAR AND WALNUT CHIPS ARE NOT ACCEPTABLE, NOR IS PALM GENERATED MULCH.

13. CROWN PRUNING -PRUNING MUST COMPLY WITH ANSI A300 PRUNING STANDARDS. PRUNING PRIOR TO CONSTRUCTION SHOULD INCLUDE: NECESSARY CLEARANCE PRUNING, DEADWOOD REMOVAL AND SAFETY PRUNING.

14. CONSTRUCTION DOCUMENTS TO SHOW PROTECTED TREES AND TREE PROTECTION REQUIREMENTS - PROJECT PLANS TO SHOW ALL TREE PROTECTION FENCING LAYOUT, AREAS OF ENCROACHMENT AND LIST PROCEDURES FOR WORKING AROUND PROTECTED TREES.

15. DESIGNATION OF TREE ROOT PROTECTION ZONE (RPZ) - CITY OF SANTA ROSA ARBORIST NOTES DESIGNATES THE "TREE PROTECTION ZONE AS 1.5 TIMES THE RADIUS OF THE DRIP LINE". THE TREE ROOT PROTECTION ZONE DESIGNATES AN AREA SURROUNDING A TREE OR GROUPING OF TREES THAT IS TO BE FENCED OFF FROM ALL ACCESS. NO MATTER THE RADIUS OF THE DRIP ZONE, THE RPZ IS NOT TO BE LESS THAN ONE (1) FOOT RADIAL DISTANCE FROM THE BASE OF THE TREE FOR EVERY ONE (1) INCH IN TREE DIAMETER. A TREE WITH A 10 INCH DIAMETER WOULD HAVE A MINIMUM RPZ EQUAL TO 10 FEET OUT FROM THE TREE. PROJECT ARBORIST CAN MODIFY THE RPZ DISTANCE BASED UPON PHYSICAL EVIDENCE OF ROOT PRESENCE OR ABSENCE.

16. TREE ROOT PROTECTION ZONE FENCING - FENCING IS TO BE CHAIN-LINK TYPE METAL FENCING WITH METAL POSTS DRIVEN TWO-FEET INTO THE SOIL. SIGNS SHALL BE ATTACHED TO TREE PROTECTION FENCING EVERY 20' WHICH READ "TREE PROTECTION ZONE DO NOT ENTER".

17. PROCEDURES AND TREATMENTS FOR WORK ACTIVITIES THAT MUST OCCUR INSIDE OF THE RPZ - ALL SUCH ACTIVITIES AND RELOCATION OF FENCING MUST BE OVERSEEN BY PROJECT ARBORIST. SPECIAL TRUNK, SCAFFOLD AND SOIL PROTECTION MEASURES ARE REQUIRED. WHEN ENCROACHMENT IS ANTICIPATED PRIOR TO THE BEGINNING OF CONSTRUCTION ACTIVITIES, THE PROTECTIONS MUST BE IN PLACE PRIOR TO BEGINNING WORK ACTIVITIES.

18. ARBORIST REVIEW AND APPROVAL OF TREE PROTECTION MEASURES - PROJECT ARBORIST EMPLOYED BY THE CITY OF SANTA CLARA TO REVIEW TREE PROTECTION GUIDELINES AND MODIFY AS DEEMED NECESSARY.

19. TREE PROTECTIONS INSTALLATION AND INSPECTED - PROJECT ARBORIST MUST CERTIFY THAT ALL TREE PROTECTION MEASURES HAVE BEEN PROPERLY

20. PRE-CONSTRUCTION MEETING - CITY EMPLOYED PROJECT ARBORIST TO MEET WITH CONSTRUCTION SUPERVISOR AND WORK CREW TO REVIEW REQUIREMENTS OF THE TREE PROTECTION. ALL PERSONNEL WORKING ON SITE MUST BE PROVIDED AN ORIENTATION TO THE TREE PRESERVATION REQUIREMENTS. NO CONSTRUCTION ACTIVITIES MAY BEGIN UNTIL THIS MEETING HAS BEEN CONDUCTED.

21. PROJECT ARBORIST CAN DIRECT THAT ALL WORK ACTIVITIES STOP IF TREE PROTECTION GUIDELINES ARE NOT BEING FOLLOWED. ALL WORK ACTIVITIES CEASE UNTIL SUCH TIME AS THE PROBLEM HAS BEEN CORRECTED.

22. WORK ACTIVITIES THAT ENCROACH INTO THE DESIGNATED RPZ

ARBORIST SUPERVISION – ALL ACTIVITIES OCCURRING WITHIN THE DESIGNATED RPZ MUST BE UNDER DIRECT SUPERVISION OF PROJECT ARBORIST. ENCROACHMENT IS NOT PERMITTED UNTIL ALL ADDITIONAL PROTECTIONS ARE IN PLACE AND HAVE BEEN APPROVED.

23. SOIL AND ROOT PROTECTION -THE EFFECTS OF FOOT TRAFFIC CAN BE MITIGATED THROUGH THE USE OF SIX (6) INCHES OF WOOD CHIP MULCH AND ¾ INCH PLYWOOD PLACED ON TOP. PROTECTIONS FOR EQUIPMENT OPERATING WITHIN THE DESIGNATED RPZ REQUIRES 12 INCHES OF MULCH WITH EITHER METAL TRENCHING PLATES OR 1 1/8 INCH PLYWOOD PLACED ON TOP.

24. TRUNK AND SCAFFOLD PROTECTION – WHENEVER CONSTRUCTION ACTIVITY MUST OCCUR INSIDE THE TREE PROTECTION ZONE. THE BASE OF THE TREE AND THE FIRST EIGHT-FEET AND EXPOSED SCAFFOLD LIMBS MUST BE ARMORED. PROTECTION IS GENERALLY PROVIDED BY WRAPPING THE TRUNK WITH STRAW WADDLES COVERED WITH ORANGE PLASTIC CONSTRUCTION FENCING. EXPOSED SCAFFOLD LIMBS ARE BEST PROTECTED BY STRAPPING 2X4 BOARDS TO THE PART EXPOSED TO POTENTIAL INJURY AND WRAPPING WITH ORANGE PLASTIC FENCING MATERIAL.

25. REQUIRED METHOD OF EXCAVATION WITHIN CRITICAL ROOT ZONE - WHEREVER POSSIBLE, ROUTE UTILITIES OUTSIDE OF THE DESIGNATED RPZ. TUNNELING IS THE PREFERRED METHOD FOR UTILITIES PASSING THROUGH THE RPZ. WHEN TRENCHING IS REQUIRED, CAREFULLY HAND EXCAVATION OR THE USE OF THE AIR SPADE OR DITCH WITCH IS REQUIRED. PROJECT ARBORIST MUST APPROVE AND SUPERVISE ALL SUCH ACTIVITY.

26. NECESSARY ROOT PRUNING – LATE FALL SEASON IS THE BEST TIME FOR ROOT PRUNING. SPRING CAN BE THE MOST HARMFUL AT THIS IS THE TIME OF GREATEST MOISTURE NEEDS. ALL NECESSARY ROOT PRUNING IS CONDUCTED BY PROJECT ARBORIST AFTER THE ROOTS HAVE BEEN EXPOSED WITHOUT DAMAGE.

27. POST CONSTRUCTION MITIGATION ARBORIST DESIGNATION OF HEALTH MITIGATION ACTIVITIES – PROJECT ARBORIST WILL DESIGNATE TREE HEALTH MITIGATION ACTIVITIES BASED UPON THE LEVEL OF ROOT LOSS AND ADVERSE IMPACTS THAT HAVE OCCURRED.

28. MONITORING TREE HEALTH - TREES THAT HAVE BEEN ADVERSELY IMPACTED BY CONSTRUCTION ACTIVITIES ARE NOTED FOR REGULAR VISUAL INSPECTION. PROJECT ARBORIST WILL DIRECT FURTHER MITIGATION. INSECTS AND FUNGAL PATHOGENS ARE A SIGN OF POOR TREE HEALTH (LOW ENERGY RESERVES) AND INDICATE THE NEED FOR HEALTH MITIGATION.

29. MONITORING OF SOIL MOISTURE - MOISTURE SHOULD BE MONITORED BY VISUAL INSPECTION USING A SOIL PROBE OR THROUGH THE USE OF TENSIOMETERS PLACED AT KEY LOCATIONS AND DEPTHS. SUPPLEMENTAL IRRIGATION IS MOST NEEDED DURING SPRING. IN CASES WHERE TREES HAVE SUFFERED ROOT LOSS, SUPPLEMENTAL IRRIGATION MAY BE REQUIRED FOR A NUMBER OF YEARS.

30. MITIGATION OF SOIL COMPACTION - THE LEVEL AND DEPTH OF SOIL COMPACTION MUST BE ASSESSED AND MITIGATED AS NECESSARY. TOOLS THAT ARE MOST SUITABLE FOR MITIGATION OF COMPACTED SOIL ARE THE WATER JET OR AIR SPADE.

31. LANDSCAPING – ALL LANDSCAPING PLANNING MUST TAKE PRECAUTIONS WHEN PLANTING WITHIN THE DESIGNATED RPZ. ALL PLANT MATERIALS SHOULD BE SELECTED FOR COMPATIBILITY WITH THE FAVORED MOISTURE REGIME (HYDROZONE) OF THE TREE SPECIES AND SOIL TEXTURE.

32. CONTINUED MULCHING - MULCH IS EXTREMELY BENEFICIAL IN CREATING A HEALTHY ROOT ENVIRONMENT. A REGULAR PROGRAM OF MULCH APPLICATION IS RECOMMENDED TO HELP RETAIN SOIL MOISTURE, PROVIDE A SOURCE OF NUTRIENTS, AND HELP CONTROL WEEDS.

33. FERTILIZATION -TREES SHOULD BE FERTILIZED ONLY WHEN THE NUTRITIONAL LIMITATIONS HAVE BEEN IDENTIFIED THROUGH LABORATORY ANALYSIS OF SOIL OR PLANT TISSUE. EXCESSIVE NITROGEN FERTILIZATION IS KNOWN TO DRAW SUCKING INSECTS (APHID, SCALE, ETC.) TO THE PLANTS AND PROVIDE NUTRITION TO FUNGAL PATHOGENS IN THE SOIL. PEST MANAGEMENT PROGRAM – HEALTHY TREES DO NOT GENERALLY HAVE SERIOUS PEST PROBLEMS. STRESSED TREES BECOME ATTRACTIVE HOSTS TO PATHOGENS WHICH CAN CONTRIBUTE TO FURTHER DECLINE. PEST MANAGEMENT IS PRESCRIBED WHEN MONITORING INDICATES A


34. ENFORCEMENT OF TREE PROTECTION – CITY OF SANTA CLARA ARBORIST NOTES LIST PENALTIES FOR FAILURE TO COMPLY WITH PROTECTION AND MAINTENANCE OF TREES DESIGNATED TO BE RETAINED.

1. ALL PLANTS DESIGNATED TO BE SAVED SHALL BE PROTECTED BY FENCING, AS


2. INSTALL TREE PROTECTION FENCE AT TREE DRIP LINE OR AT EDGE OF DISTURBED AREA PRIOR TO COMMENCEMENT OF CONSTRUCTION.

3. SPACE TREE PROTECTION ZONE SIGNS A MINIMUM OF ONE EVERY 300 FEET. THE SIZE OF EACH SIGN MUST BE A MINIMUM OF 2' x 2' AND BE VISIBLE FROM BOTH SIDES OF THE SIGN MUST CONTAIN THE FOLLOWING LANGUAGE IN BOTH ENGLISH & SPANISH: "TREE PROTECTION ZONE, KEEP OUT".

3. THERE SHALL BE NO STORAGE OF MATERIAL WITHIN THE BOUNDARIES OF THE TREE

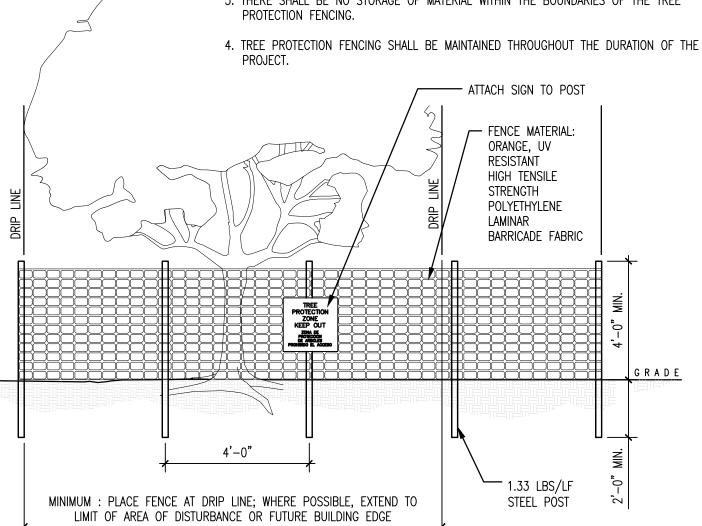

	PROTECTE				REPLACEMENT TR	REES	
NAME	SPECIES	TRUNK DIAMETER (IN)	PRESERVED	PROTECTED TREE TO BE REMOVED		SIZE	QT
860	OLEANDER	DIAMETER (IN)	(Y/N) N	→ 860	KINDRED SPIRIT OAK	24" BOX	2
861	OLEANDER	8	N N	861	KINDRED SPIRIT OAK	24 BOX 24" BOX	2
863	OLEANDER	7	N	863	BLUE OAK	24 BOX 24" BOX	2
870	CALIFORNIA BLACK WALNUT	14	N	870	KINDRED SPIRIT OAK	24" BOX	2
871	DEODAR CEDAR	36	Υ				
872	ENGLISH WALNUT	8	Υ				
873	BOXELDER	8	Y				
874	DEODAR CEDAR	40	Υ				
875	AVOCADO	14	Υ				
876	JAPANESE MAPLE	9, 6, 5	Y				
877	JAPANESE MAPLE	7, 4, 4, 4, 4, 4, 4	r				
878	COAST REDWOOD	35	Y				
879 880	SAUCER MAGNOLIA	15, 10	Y	990	KINDDED CDIDIT OAK	0.4" DOV	
881	ORANGE AVOCADO	14 26	N N	→ 880 → 881	KINDRED SPIRIT OAK BLUE OAK	24" BOX	2
882	BLACKWOOD ACACIA	26	N N	882	BLUE OAK	24" BOX 24" BOX	2
883	BLACKWOOD ACACIA  BLACKWOOD ACACIA	16	N N	883	BLUE OAK	24 BOX 24" BOX	2
885	GLOSSY PRIVET	15	N	885	BLUE OAK	24" BOX	2
	AUSTRALIAN BUSH			´			
886 887	CHERRY AUSTRALIAN BUSH	7, 6, 5, 5 14	N N	886	BLUE OAK BLUE OAK	24" BOX 24" BOX	2
888	CHERRY AUSTRALIAN BUSH	14	N	888	BLUE OAK	24 BOX 24" BOX	2
890	CHERRY AUSTRALIAN BUSH CHERRY	7	N	890	BLUE OAK	24" BOX	2
891	WEEPING BOTTLE BRUSH	14, 6	N	891	BLUE OAK	24" BOX	2
896	ENGLISH WALNUT	17	N	896	BLUE OAK	24" BOX	2
897 899	ORANGE CHERRY	13	Y N	899	KINDRED SPIRIT OAK	24" BOX	2
900	ENGLISH WALNUT	17	N N	900	KINDRED SPIRIT OAK	24 BOX 24" BOX	2
900	ORANGE	7	N	900	KINDRED SPIRIT OAK	24 BOX 24" BOX	2
902	CHINESE ELM	24	Y	901	KINDINED SI IKIT OAK	24 DUX	
903	CHINESE ELM	26	Y				
904	MONTERREY PINE	34	N	904	BLUE OAK	24" BOX	2
905	RAYWOOD ASH	7	N	905	BLUE OAK	24" BOX	2
907	RAYWOOD ASH	10, 12	N	907	BLUE OAK	24" BOX	2
908	RAYWOOD ASH	11	N	908	BLUE OAK	24" BOX	2
910	RAYWOOD ASH	9	N	910	BLUE OAK	24" BOX	2
911	RAYWOOD ASH	10	Υ				
912	PLUM	30	Y				
913	BOXELDER	20	Y				
914	BOXELDER	20	Y				
915 916	BOXELDER TULIP TREE	31 24	Y				
916	COAST LIVE OAK	17	N Y	917	BLUE OAK	24" BOX	2
917	ITALIAN CYPRESS	14	Y	/ 31/	DLUE UAK	∠4 BUX	
921	ITALIAN CYPRESS	11	Y		+		
922	ITALIAN CYPRESS	12	Y		1		
923	PLUM	12, 8	Y		1		
924	APPLE	15	N	924	KINDRED SPIRIT OAK	24" BOX	2
926	PLUM	13	N	926	KINDRED SPIRIT OAK	24" BOX	2
928	CABBAGE PALM	11, 9	N	928	BLUE OAK	24" BOX	2
929	RIVER RED GUM	32	N	929	BLUE OAK	24" BOX	2
931	SILVER DOLLAR GUM	21	N	931	BLUE OAK	24" BOX	2
932	RIVER RED GUM	36	N	932	BLUE OAK	24" BOX	2
937	RIVER RED GUM	24	N	937	BLUE OAK	24" BOX	2
938	CABBAGE PALM	50	N	938	BLUE OAK	24" BOX	2
939	SOUTHERN MAGNOLIA	30	N	939	BLUE OAK	24" BOX	2
940	COAST LIVE OAK	27	N	940	BLUE OAK	24" BOX	2
941	COAST LIVE OAK	26	Y		1		
942	SOUTHERN MAGNOLIA	26	Y		1		
943	SOUTHERN MAGNOLIA	23	Y				
944 947	COAST REDWOOD VICTORIAN BOX	30 17, 15	Y	947	KINDRED SPIRIT OAK	24" DOV	
947	PLUM	17, 15	N N	947	KINDRED SPIRIT OAK	24" BOX 24" BOX	2
270	I LUWI	l .		<del></del>	S REQUIRED REPLACED	•	7:
	OTAL PROTECTED TRE	'	36				

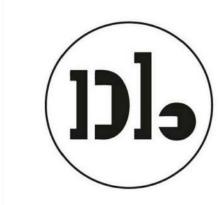

**David Baker Architects** 

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3016 FILBERT street DAKLAND, CA 94608

Issuances Date Description

Revisions Rev. Description Date


Design Update -February 2024

Drawing Title

Tree Protection and Removals List and Notes

27 February, 2024 Date 21620 Project No.



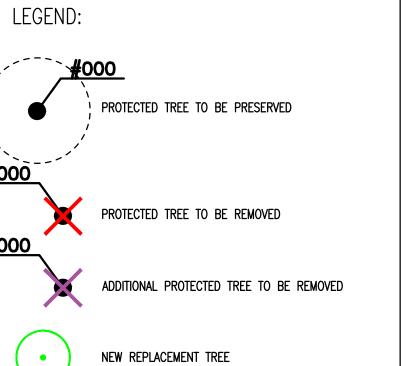



TREE QUANTITY IN AREA TREE SPECIES KEY, REFER TO PLANT LIST FOR TREE SPECIES

- 1. FOR LANDSCAPE MATERIALS, REFER TO SITE
- PLAN.

  2. FOR FULL PLANT LIST, REFER TO LANDSCAPE SCHEDULES.

  3. FOR TREE PRESERVATION LIST, REFER TO TREE PROTECTION AND REMOVALS LIST.

PLANT	LIST	
TREES		
KEY	SYMBOL	COMMON NAME
	and the same of th	PROTECTED TREE
FRAM		WHITE ASH
ARMA	$\odot$	MARINA STRAWBERR TREE
QUDO	•	BLUE OAK
PIXR	$\bigcirc$	RED PUSH PISTACHE
QUKI	$\odot$	KINDRED SPIRIT OAK
PAPE	rummar	IRONWOOD

# Woodland Park Euclid Improvements



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Issuances Date Description

Revisions Date Rev. Description

Entitlements Application


Drawing Title

Tree Protection & Removal Plan


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27 February, 2024 Project No. 21620

TREE PROTECTION AND REMOVALS (TPR) PLAN SCALE: 1" = 30'

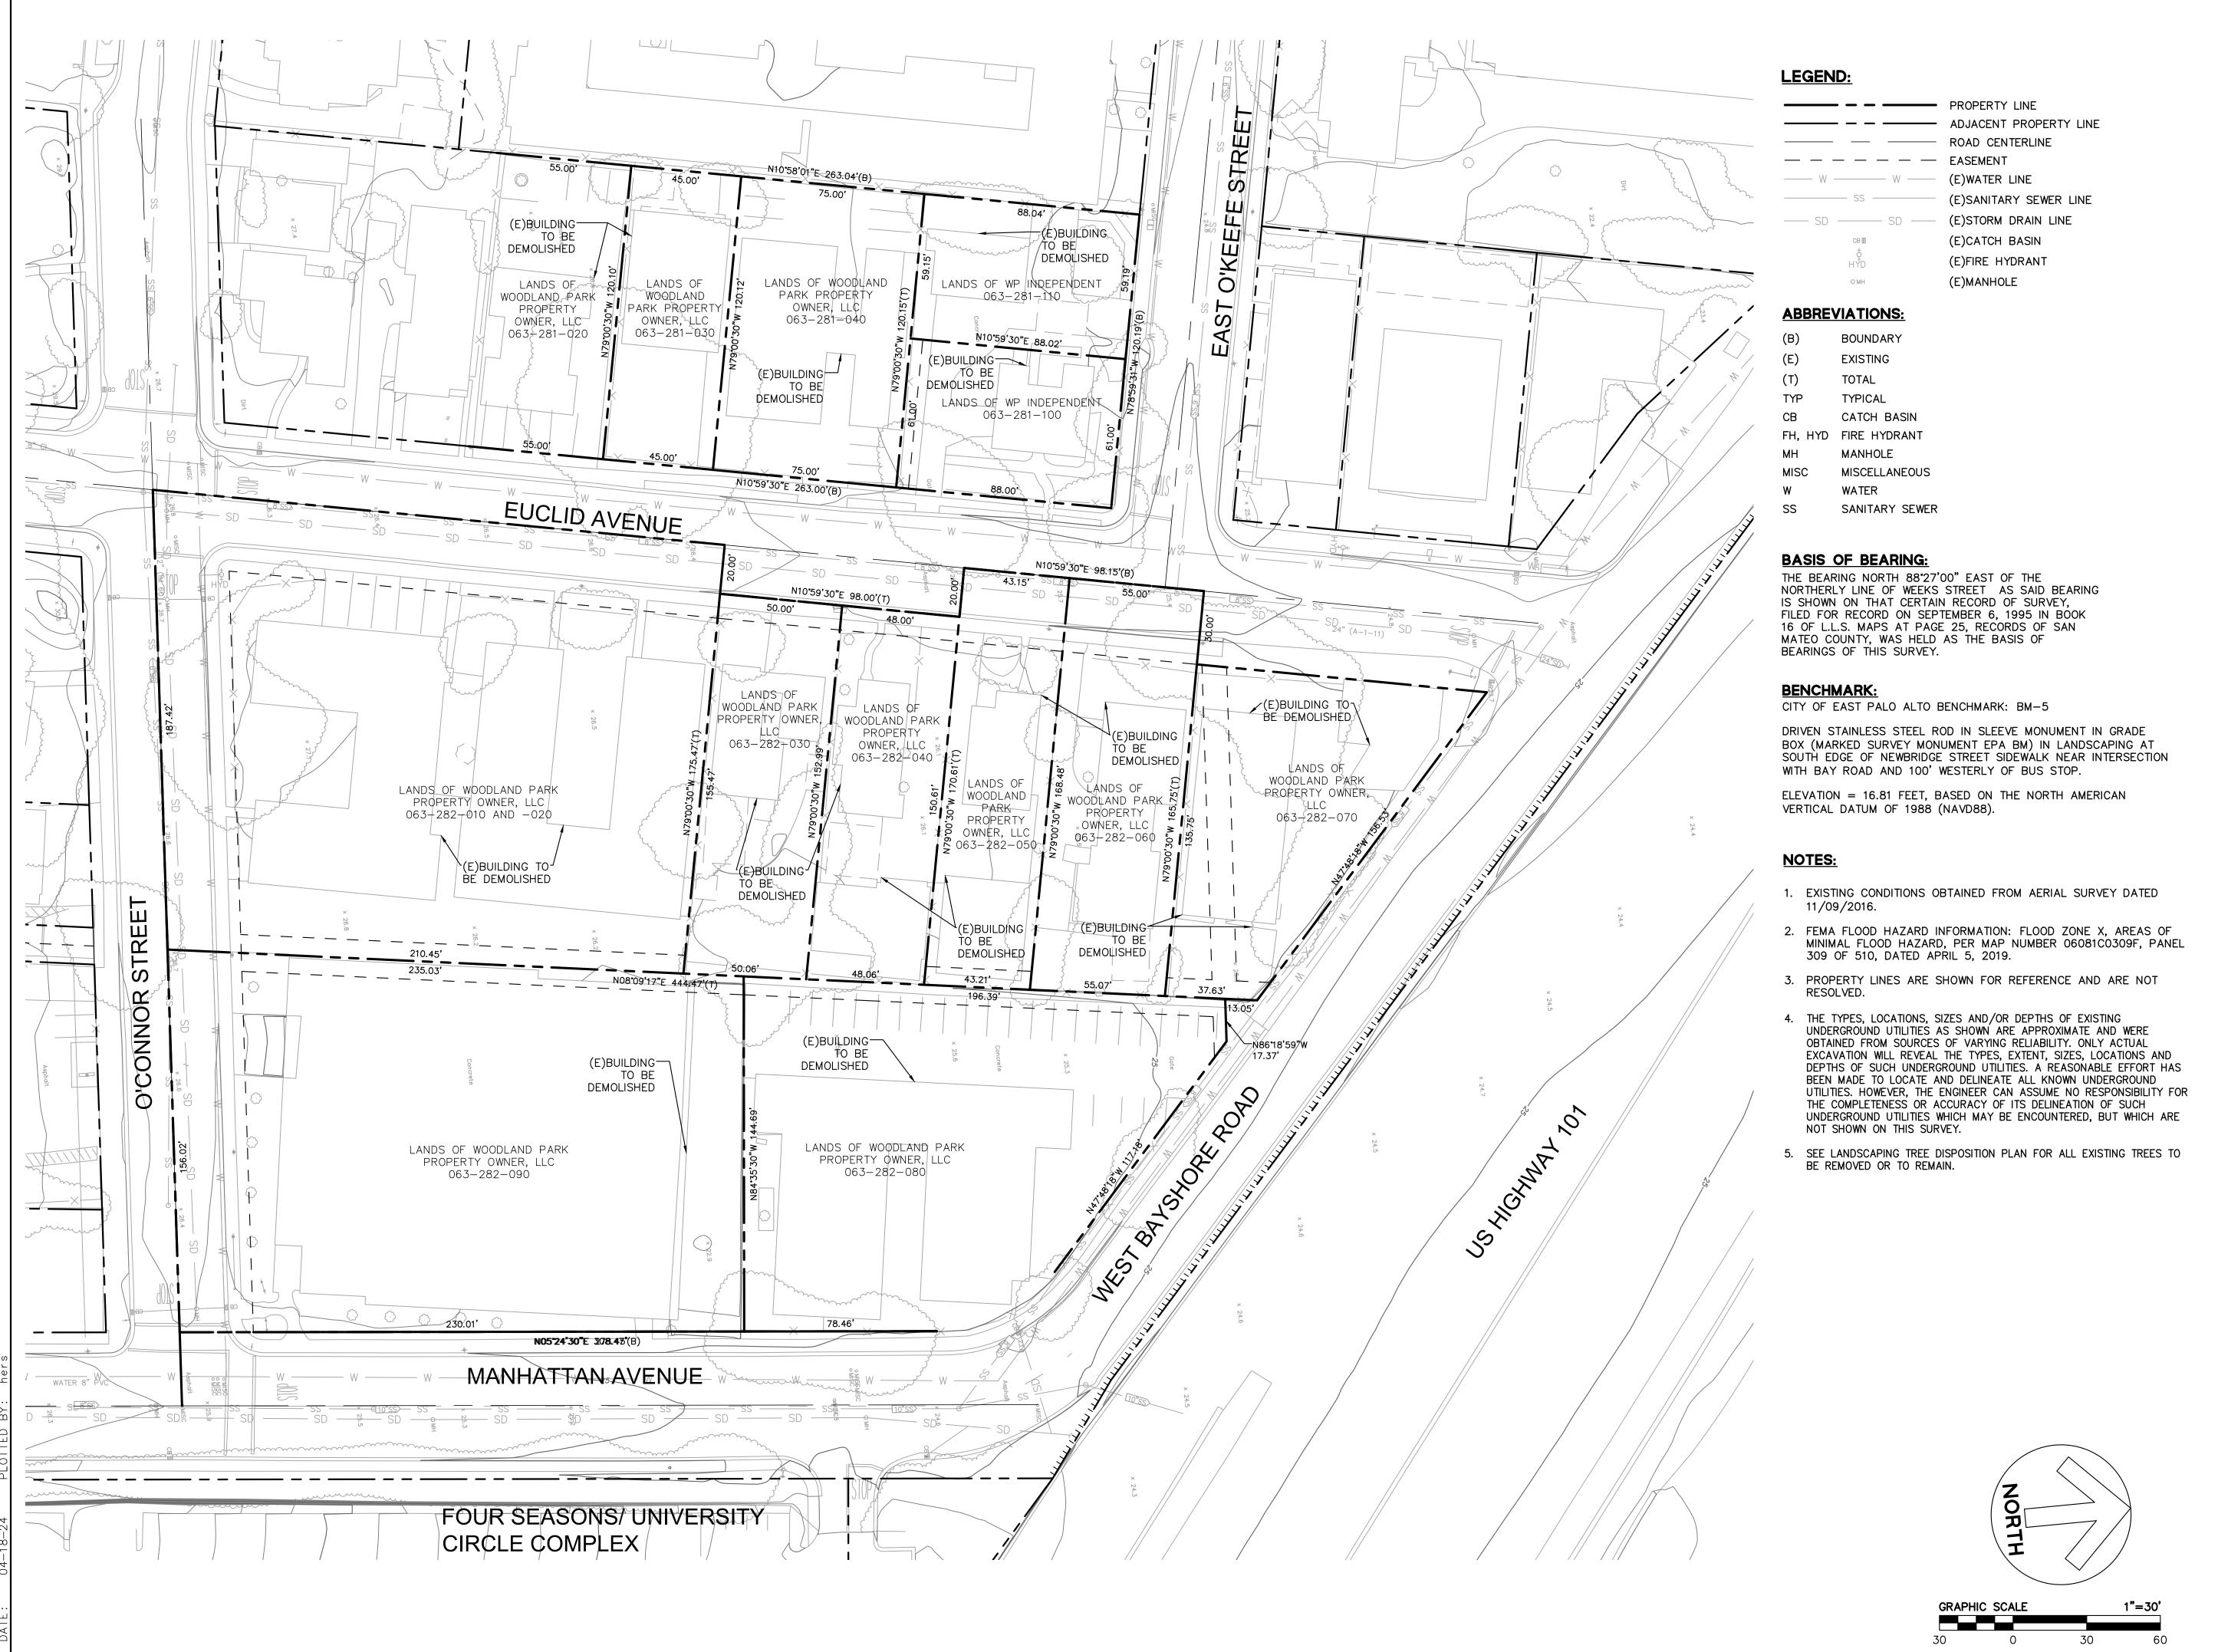

## Euclid Improvements

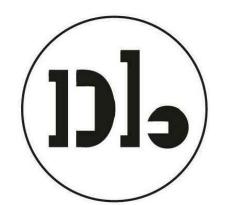

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1 Response to Comments 4/19/2024

Design Update April 2024

**Drawing Title** 

EXISTING CONDITIONS AND DEMOLITION PLAN


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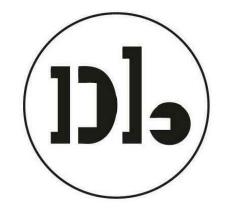
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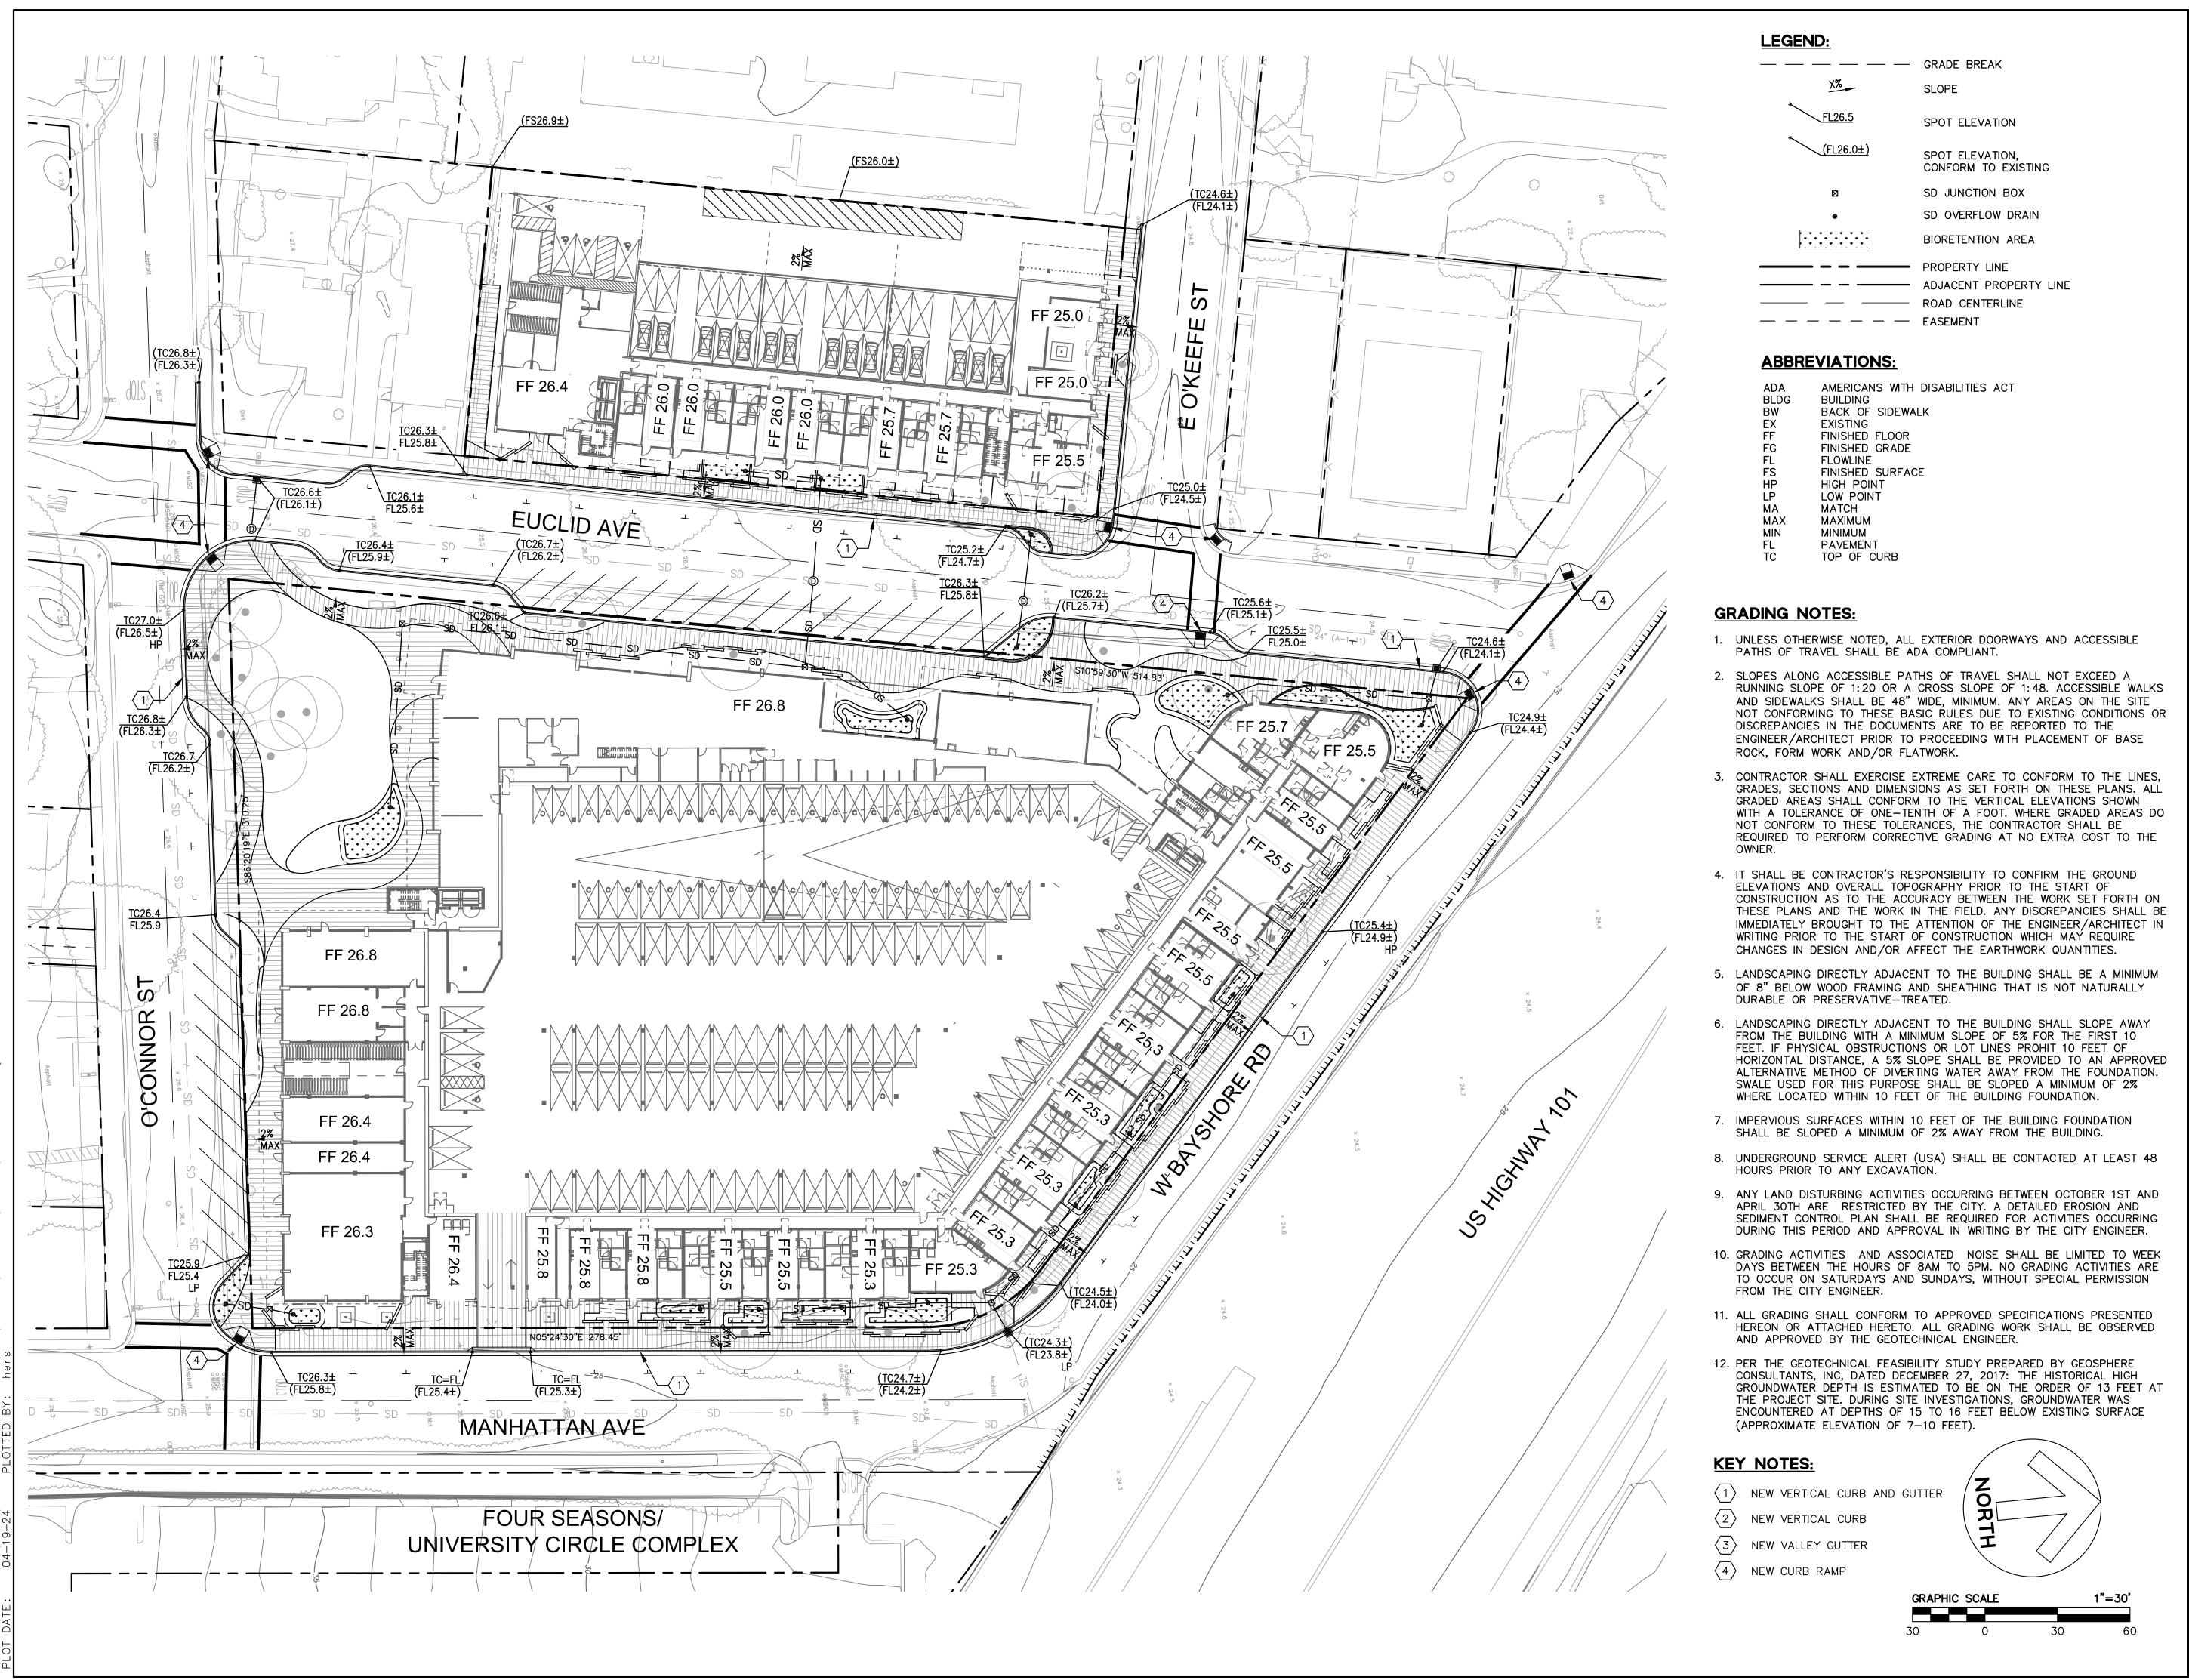
April 2024

Drawing Title


PRELIMINARY SITE PLAN

Sheet No.

Date 04/19/2024
Project No. 20166089-20

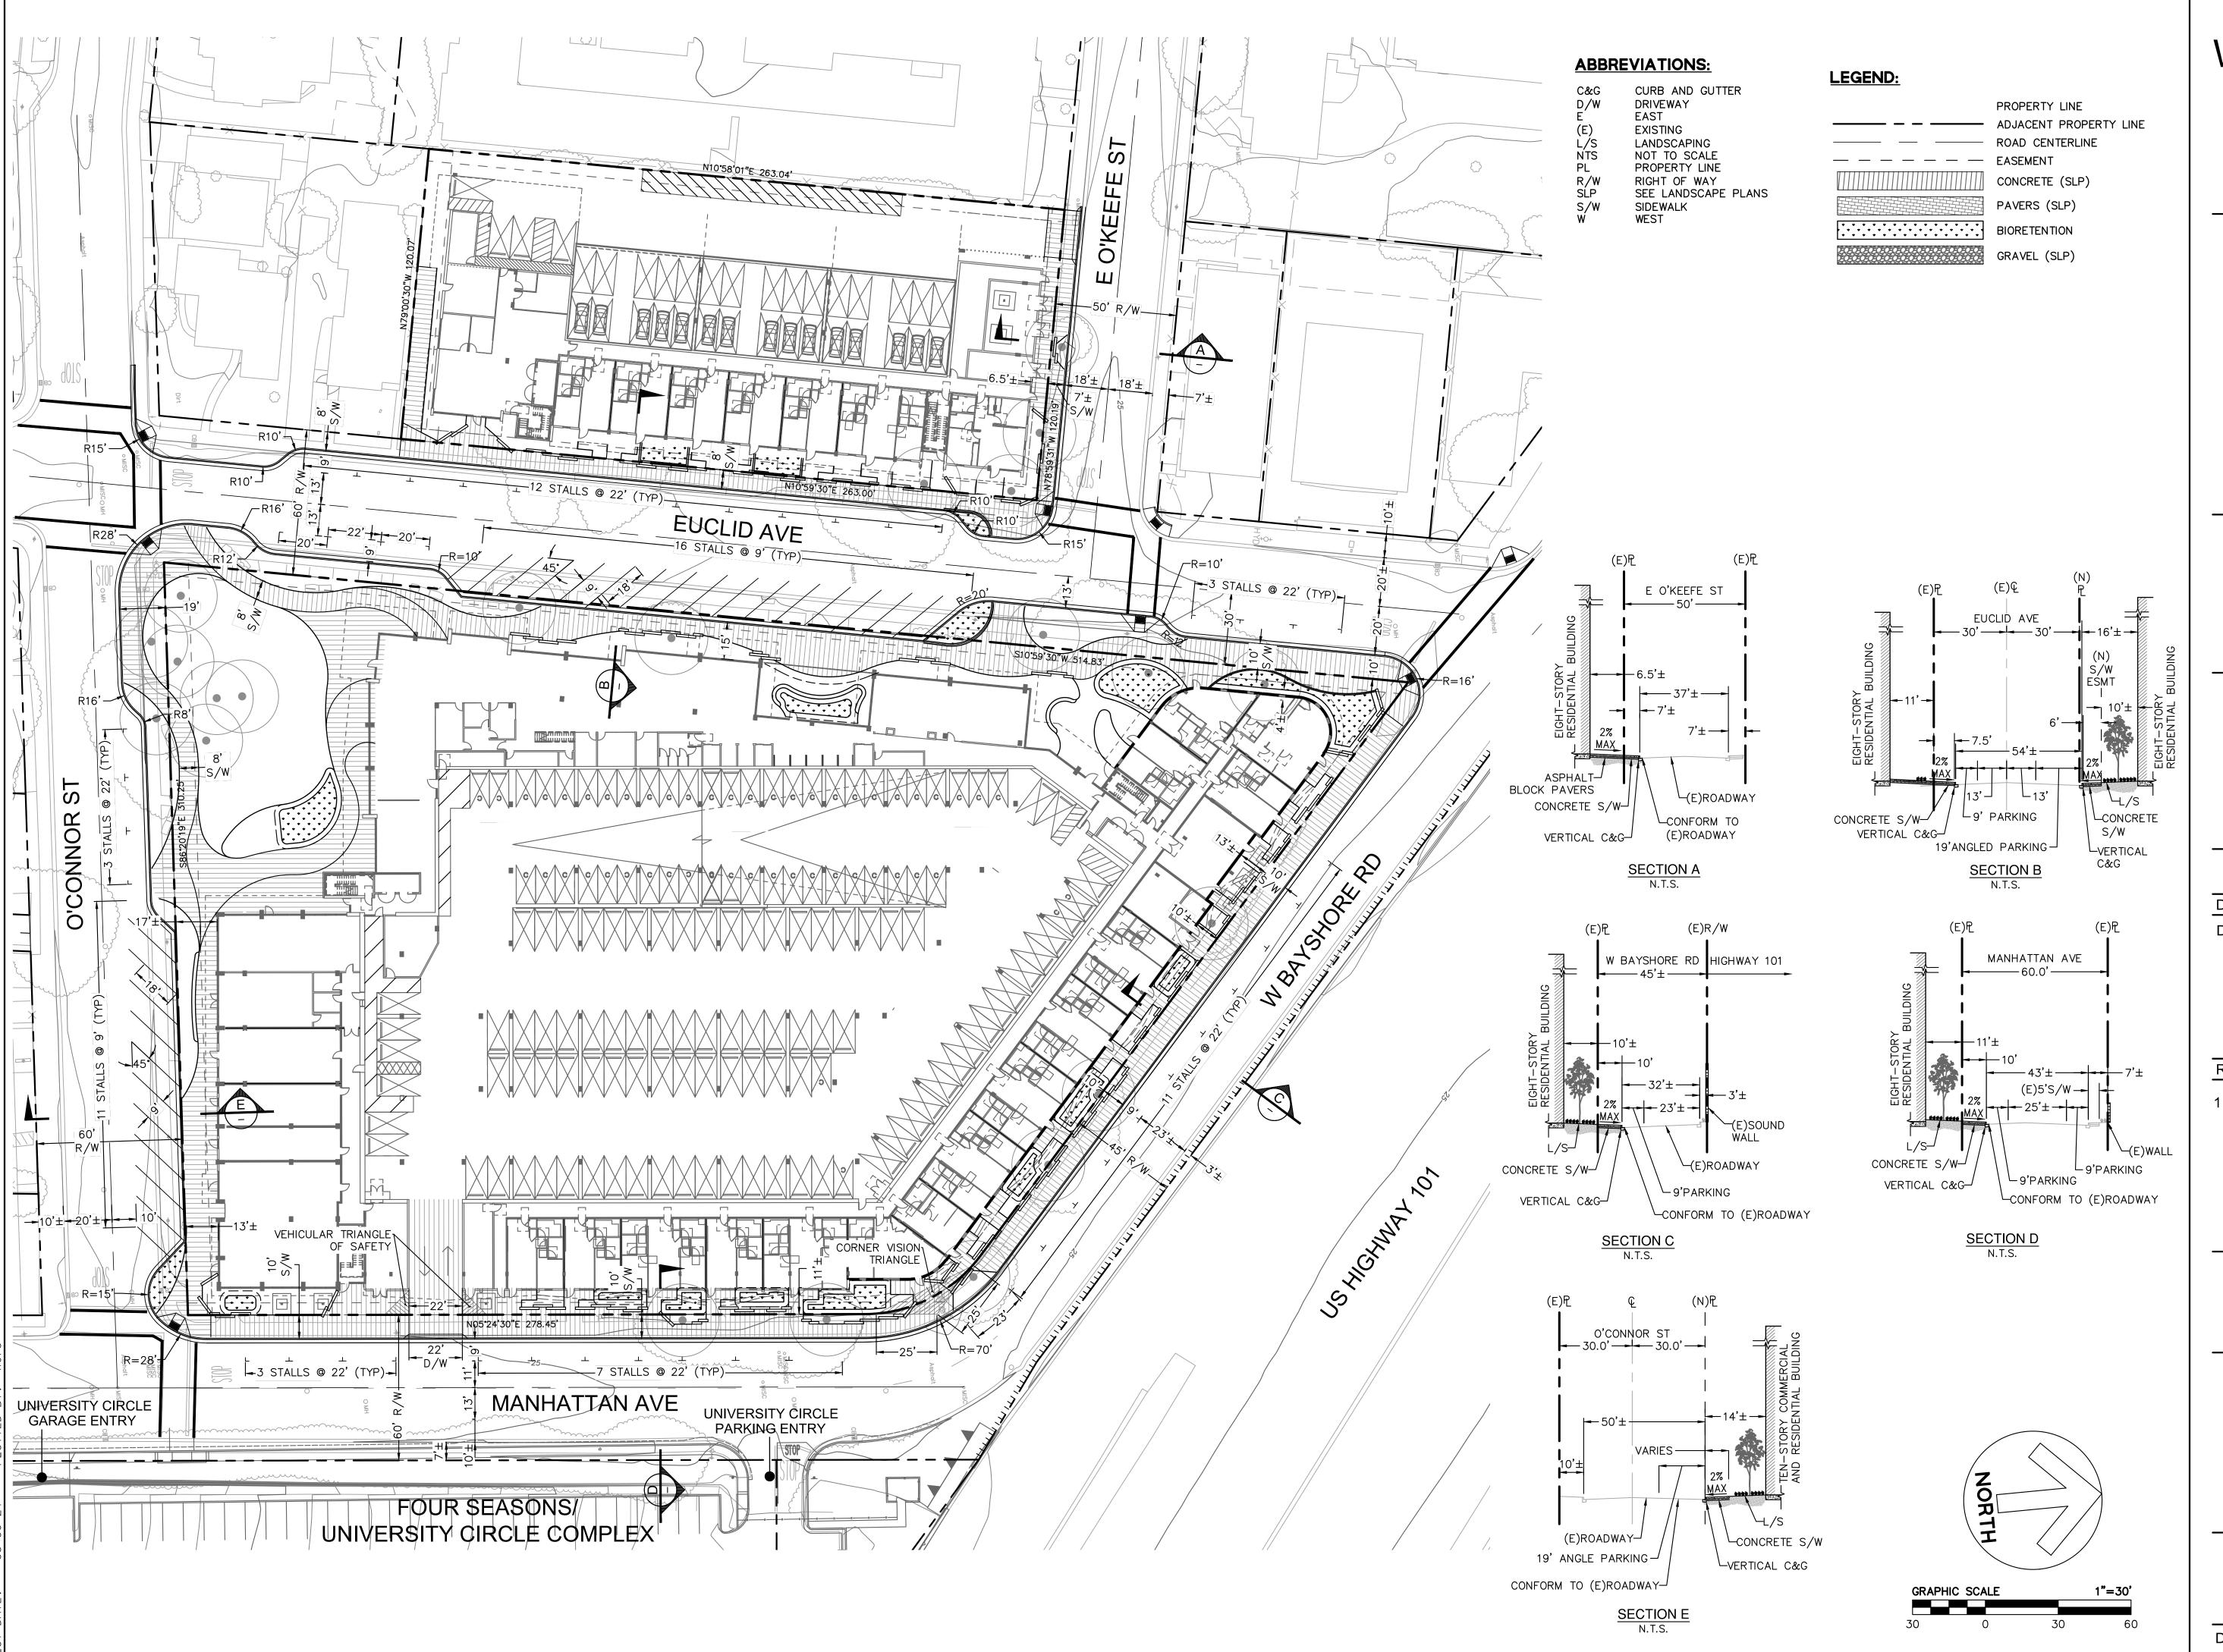

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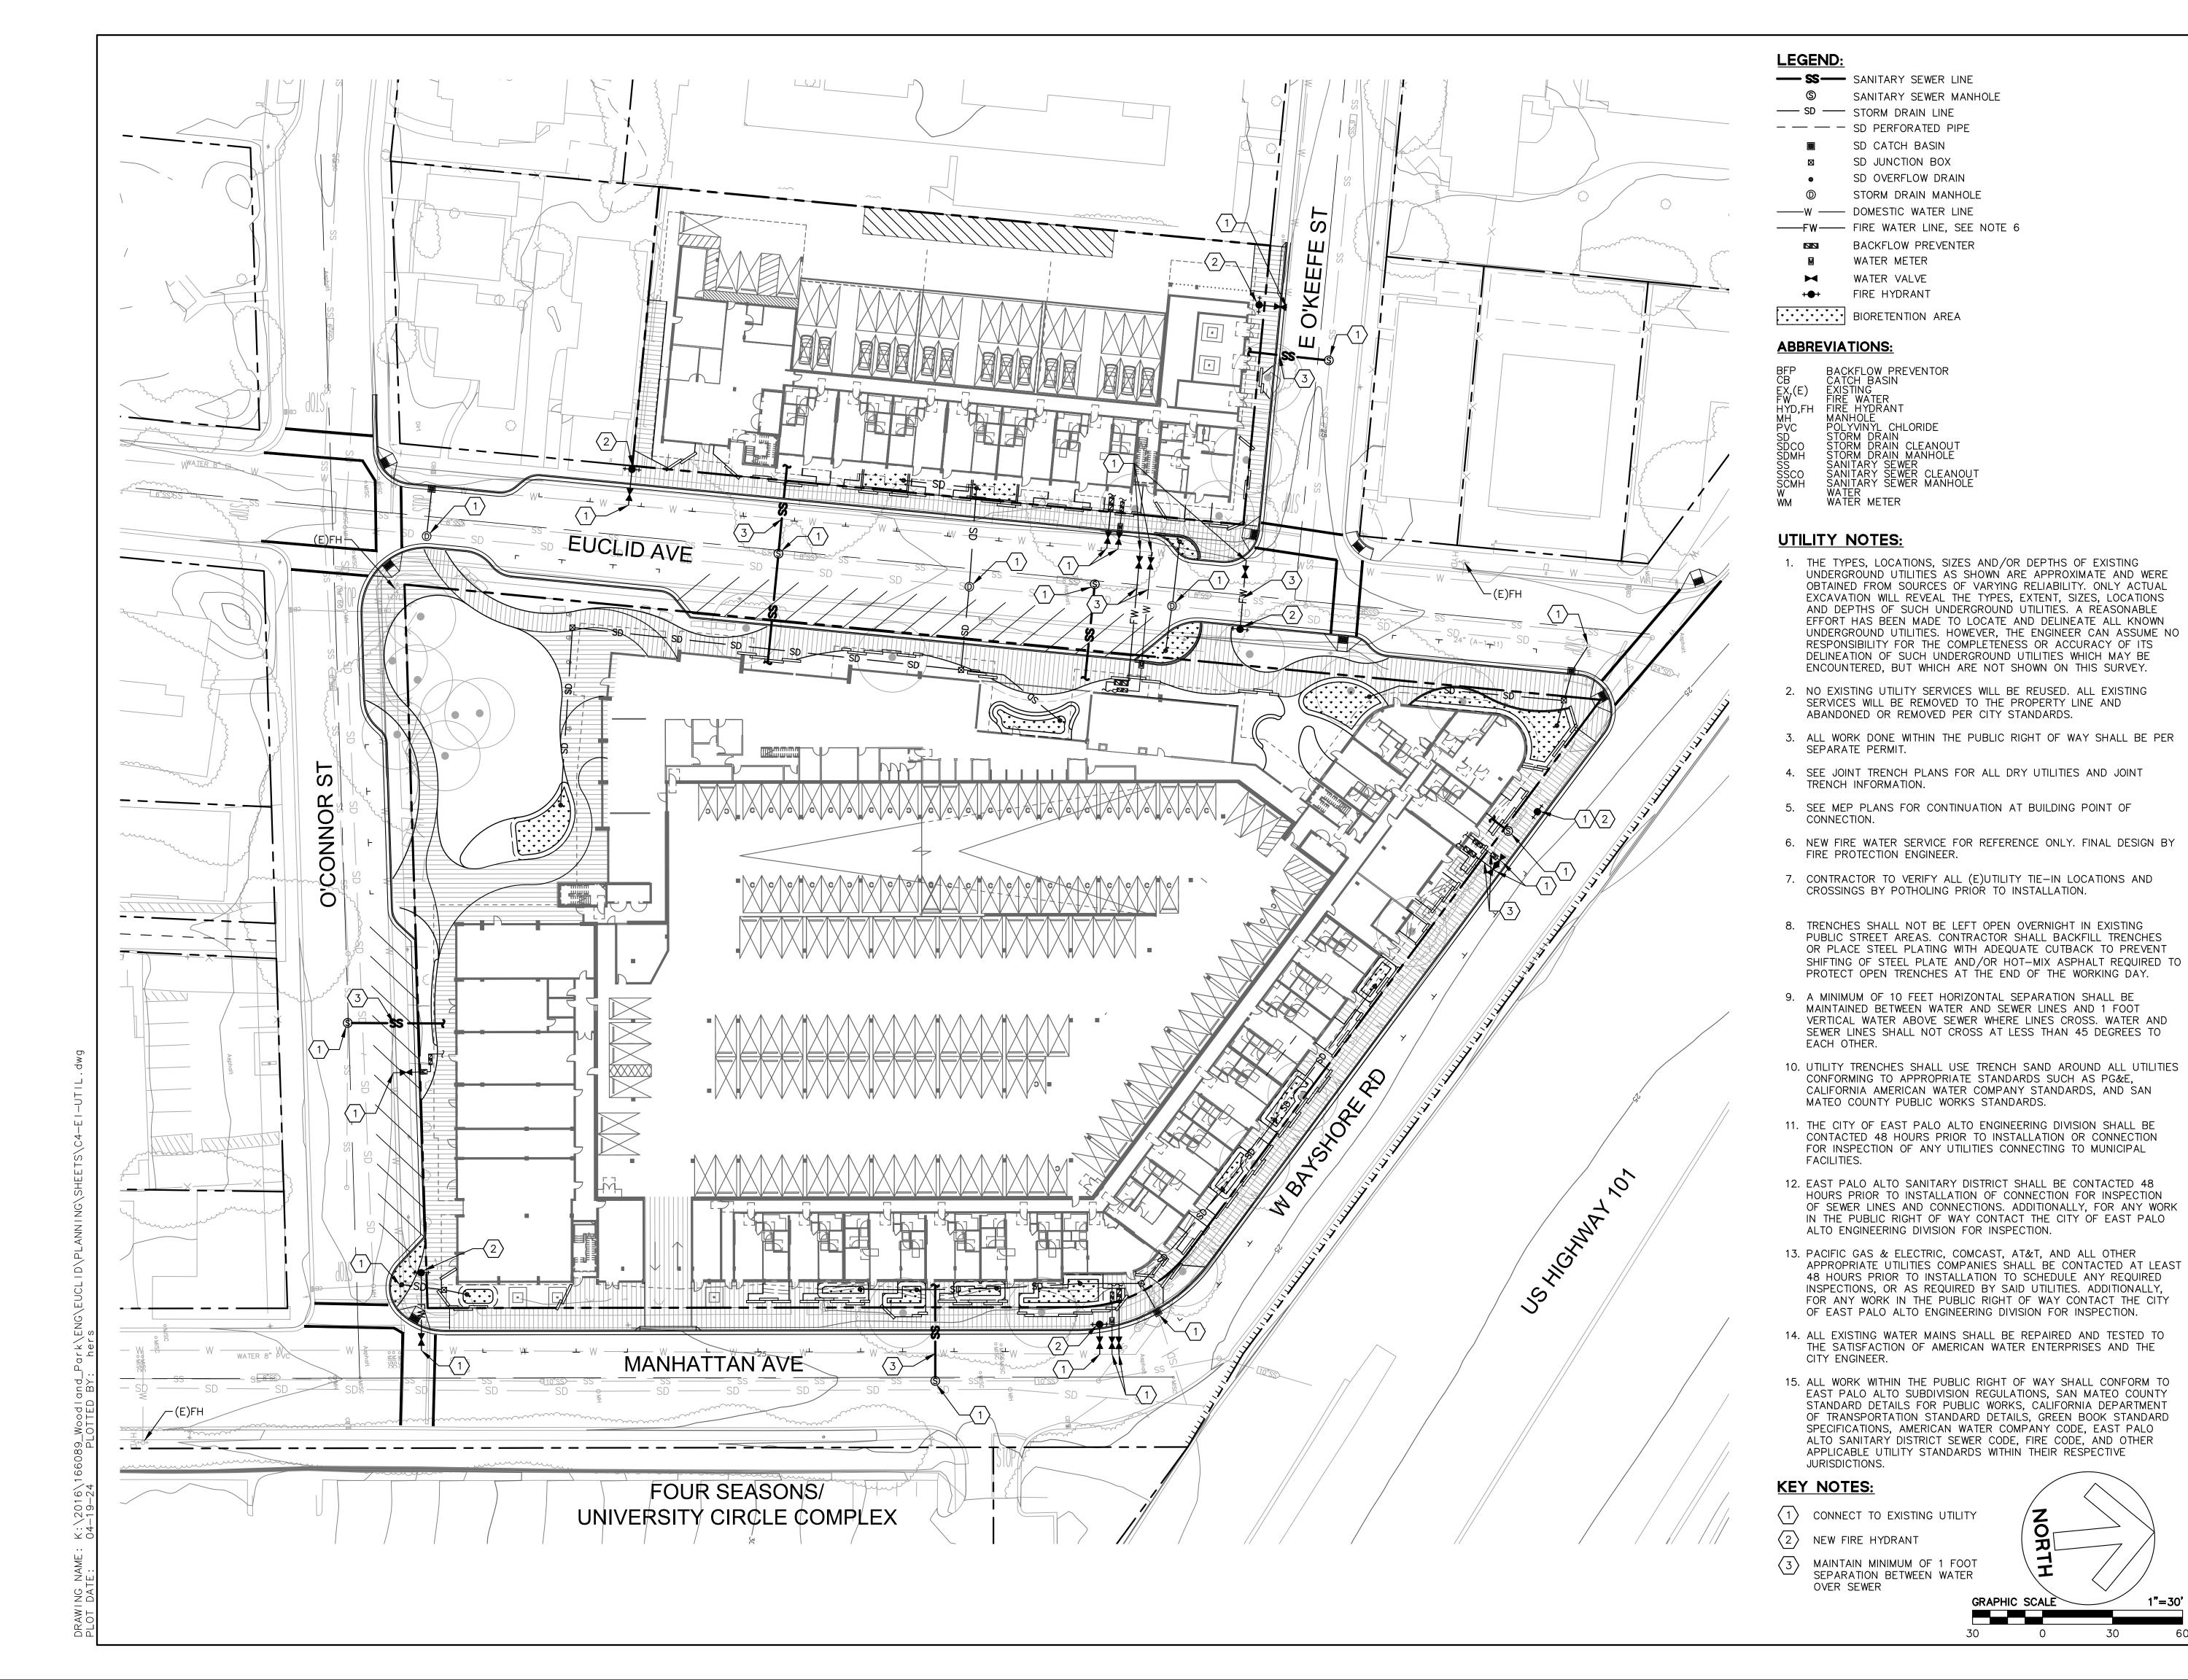
PRELIMINARY **GRADING AND** DRAINAGE PLAN

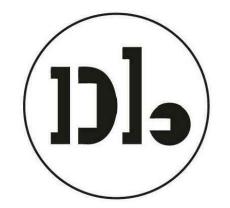Sheet No.


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**Drawing Title** 

**PRELIMINARY** UTILITY PLAN


04/19/2024 Date Project No.

1"=30'


Woodland Park
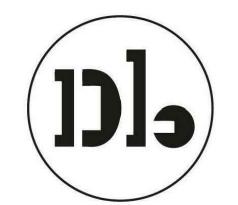
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**Drawing Title** 

PRELIMINARY STORMWATER MANAGEMENT PLAN
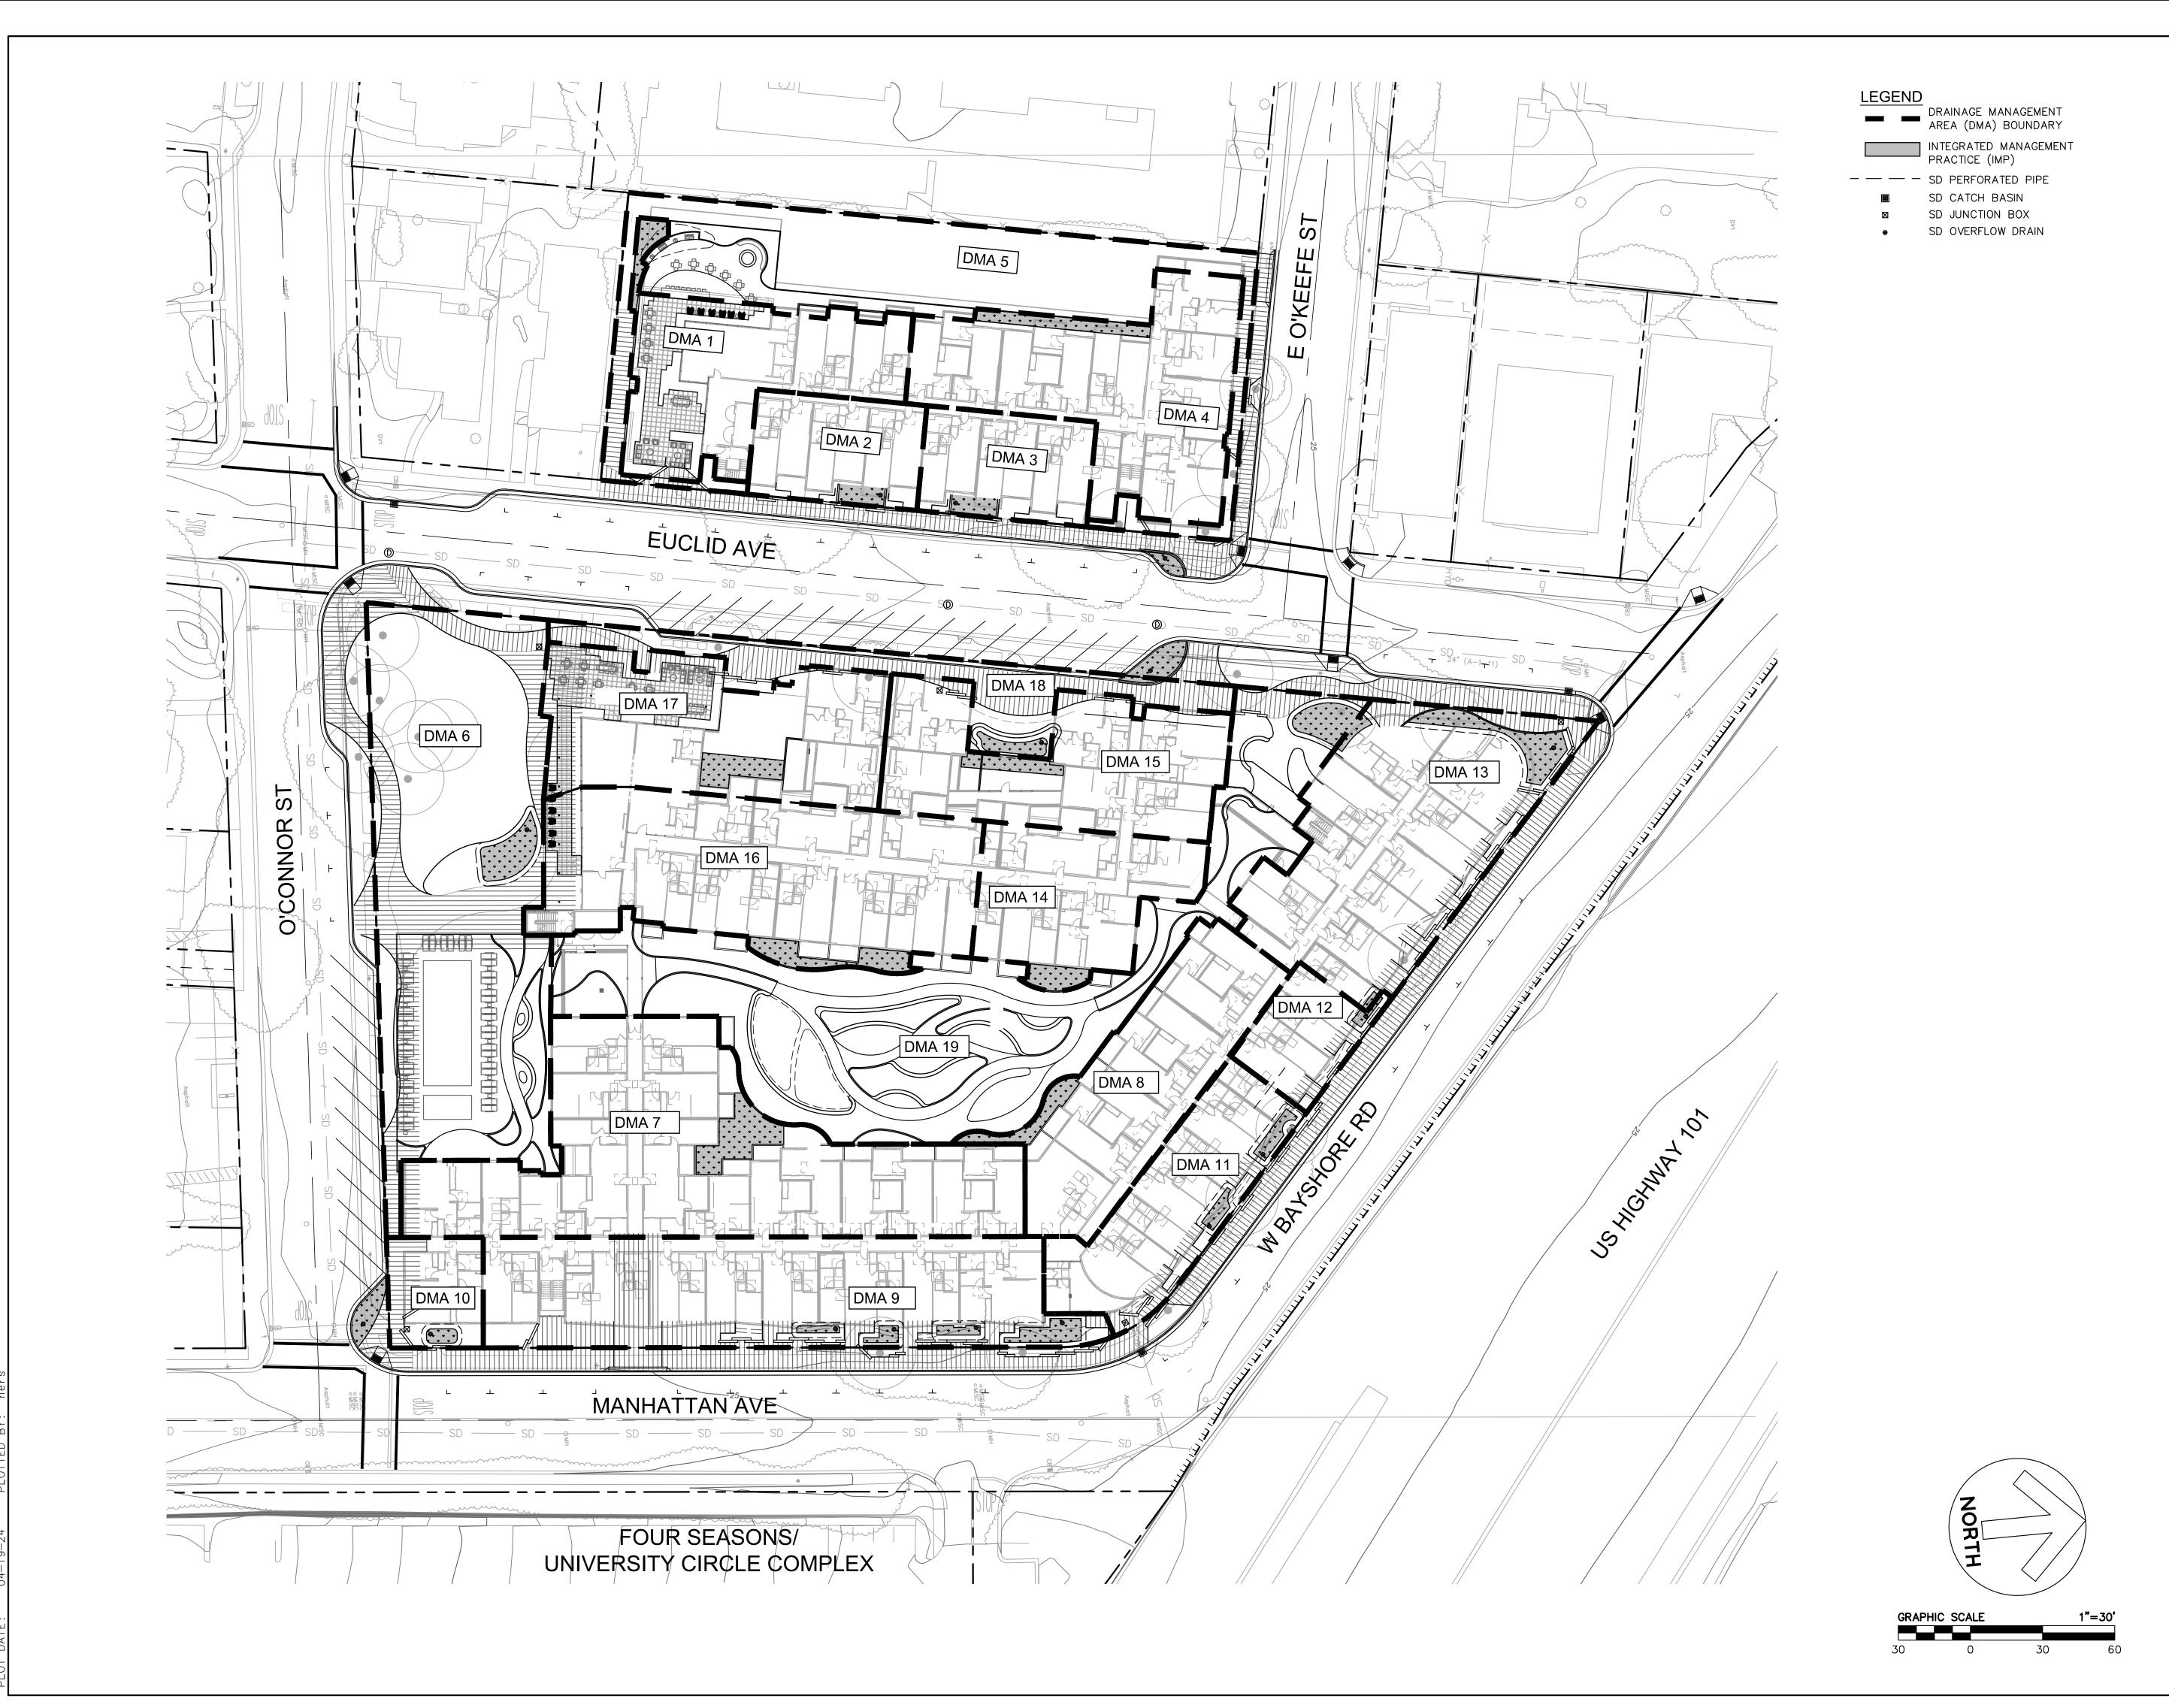
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04/19/2024 20166089-20 Project No.


TREATMENT CONTROL MEASURE SUMMA  PROPOSED CONDITION			MEASURE SIZE			
DRAINAGE AREAS	DRAINAGE AREA SIZE (SF)	PERVIOUS SURFACE	IMPERVIOUS SURFACE	REQUIRED	PROVIDED	TREATMENT MEASURE TYPE
DMA-1	6,270	(SF) LANDSCAPE 241	(SF)  ROOF/SIDEWALK 6,029	(SF) 241	(SF) 241	STRUCTURAL BIORETENTION AREA
DMA-2	3,107	LANDSCAPE 93	ROOF/SIDEWALK 3,014	121	136	STRUCTURAL BIORETENTION AREA
DMA-3	3,107	LANDSCAPE 102	ROOF/SIDEWALK 3,005	120	137	STRUCTURAL BIORETENTION AREA
DMA-4	8,485	LANDSCAPE 325	ROOF/SIDEWALK 8,120	325	365	STRUCTURAL BIORETENTION AREA
DMA-5	10,627	LANDSCAPE 427	ROOF/SIDEWALK 10,200	N/A	N/A	PERMEABLE PAVERS
DMA-6	16,590	LANDSCAPE 7,420	ROOF/SIDEWALK 9,170	367	368	NON-STRUCTURAL BIORETENTION AREA
DMA-7	13,915	LANDSCAPE 868	ROOF/SIDEWALK 13,047	522	566	STRUCTURAL BIORETENTION AREA
DMA-8	6,584	LANDSCAPE 341	ROOF/SIDEWALK 6,243	250	341	STRUCTURAL BIORETENTION AREA
DMA-9	11,073	LANDSCAPE 973	ROOF/SIDEWALK 10,100	404	405	NON-STRUCTURAL BIORETENTION AREA
DMA-10	1,819	LANDSCAPE 230	ROOF/SIDEWALK 1,589	64	73	NON-STRUCTURAL BIORETENTION AREA
DMA-11	5,089	LANDSCAPE 429	ROOF/SIDEWALK 4,660	187	206	NON-STRUCTURAL BIORETENTION AREA
DMA-12	1,978	LANDSCAPE 193	ROOF/SIDEWALK 1,785	71	71	NON-STRUCTURAL BIORETENTION AREA
DMA-13	10,219	LANDSCAPE 550	ROOF/SIDEWALK 9,669	387	512	NON-STRUCTURAL BIORETENTION AREA
DMA-14	4,754	LANDSCAPE 238	ROOF/SIDEWALK 4,516	181	238	STRUCTURAL BIORETENTION AREA
DMA-15	6,904	LANDSCAPE 270	ROOF/SIDEWALK 6,634	265	270	STRUCTURAL BIORETENTION AREA
DMA-16	11,111	LANDSCAPE 470	ROOF/SIDEWALK 10,641	426	470	STRUCTURAL BIORETENTION AREA
DMA-17	7,782	LANDSCAPE 600	ROOF/SIDEWALK 7,182	287	344	STRUCTURAL BIORETENTION AREA
DMA-18	4,040	LANDSCAPE 900	ROOF/SIDEWALK 3,140	125	153	NON-STRUCTURAL BIORETENTION AREA
DMA-19	17,244	LANDSCAPE 8,212	ROOF/SIDEWALK 9,032	361	395	NON-STRUCTURAL BIORETENTION AREA
TOTAL	150,698	22,882	127,816	4,684	5,291	
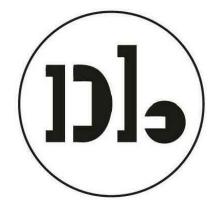
#### <u>NOTES</u>

- 1) TREATMENT AREAS WERE SIZED USING THE "4 PERCENT METHOD" FLOW-BASED SIZING CRITERIA IN THE 2014 SAN MATEO COUNTY C.3 STORMWATER TECHNICAL GUIDANCE HANDBOOK, UNLESS THE REQUIRED SF IS FOLLOWED BY AN ASTERISK "\*". IF REQUIRED SF HAS AN ASTERISK, TREATMENT IS SIZED USING THE COMBINED FLOW METHOD AND AT A MIN. PROVIDES AN EQUIVALENT OF 6-INCHES OF STORED RUNOFF IN SURFACE PONDING AREA.
- 2) NEW/REPLACED IMPERVIOUS AREA OFFSITE TOTALS 14,750 SF. PER THE "4 PERCENT METHOD", THE MINIMUM REQUIRED TREATMENT IS 590 SF. BETWEEN THE THREE BULBOUT TREATMENT AREAS, THERE IS 600 SF OF OFFSITE TREATMENT PROVIDED.

## Woodland Park

# Euclid Improvements

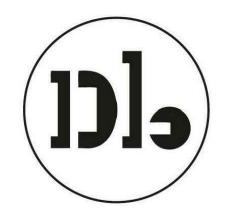

#### David Baker Architects

dbarchitect.com 461 Second St, Loft c127 San Francisco, CA 94107 415.896.6700



License Stamp

	Issuances
Description	Date
Design Update	02/27/2024

		Revisions
ev.	Description	Date

1 Response to Comments 4/19/2024

Set Title

Design Update 
April 2024

Drawing Title


PRELIMINARY STORMWATER MANAGEMENT PLAN

Sheet No


C5.1

 Date
 04/19/2024

 Project No.
 20166089-20

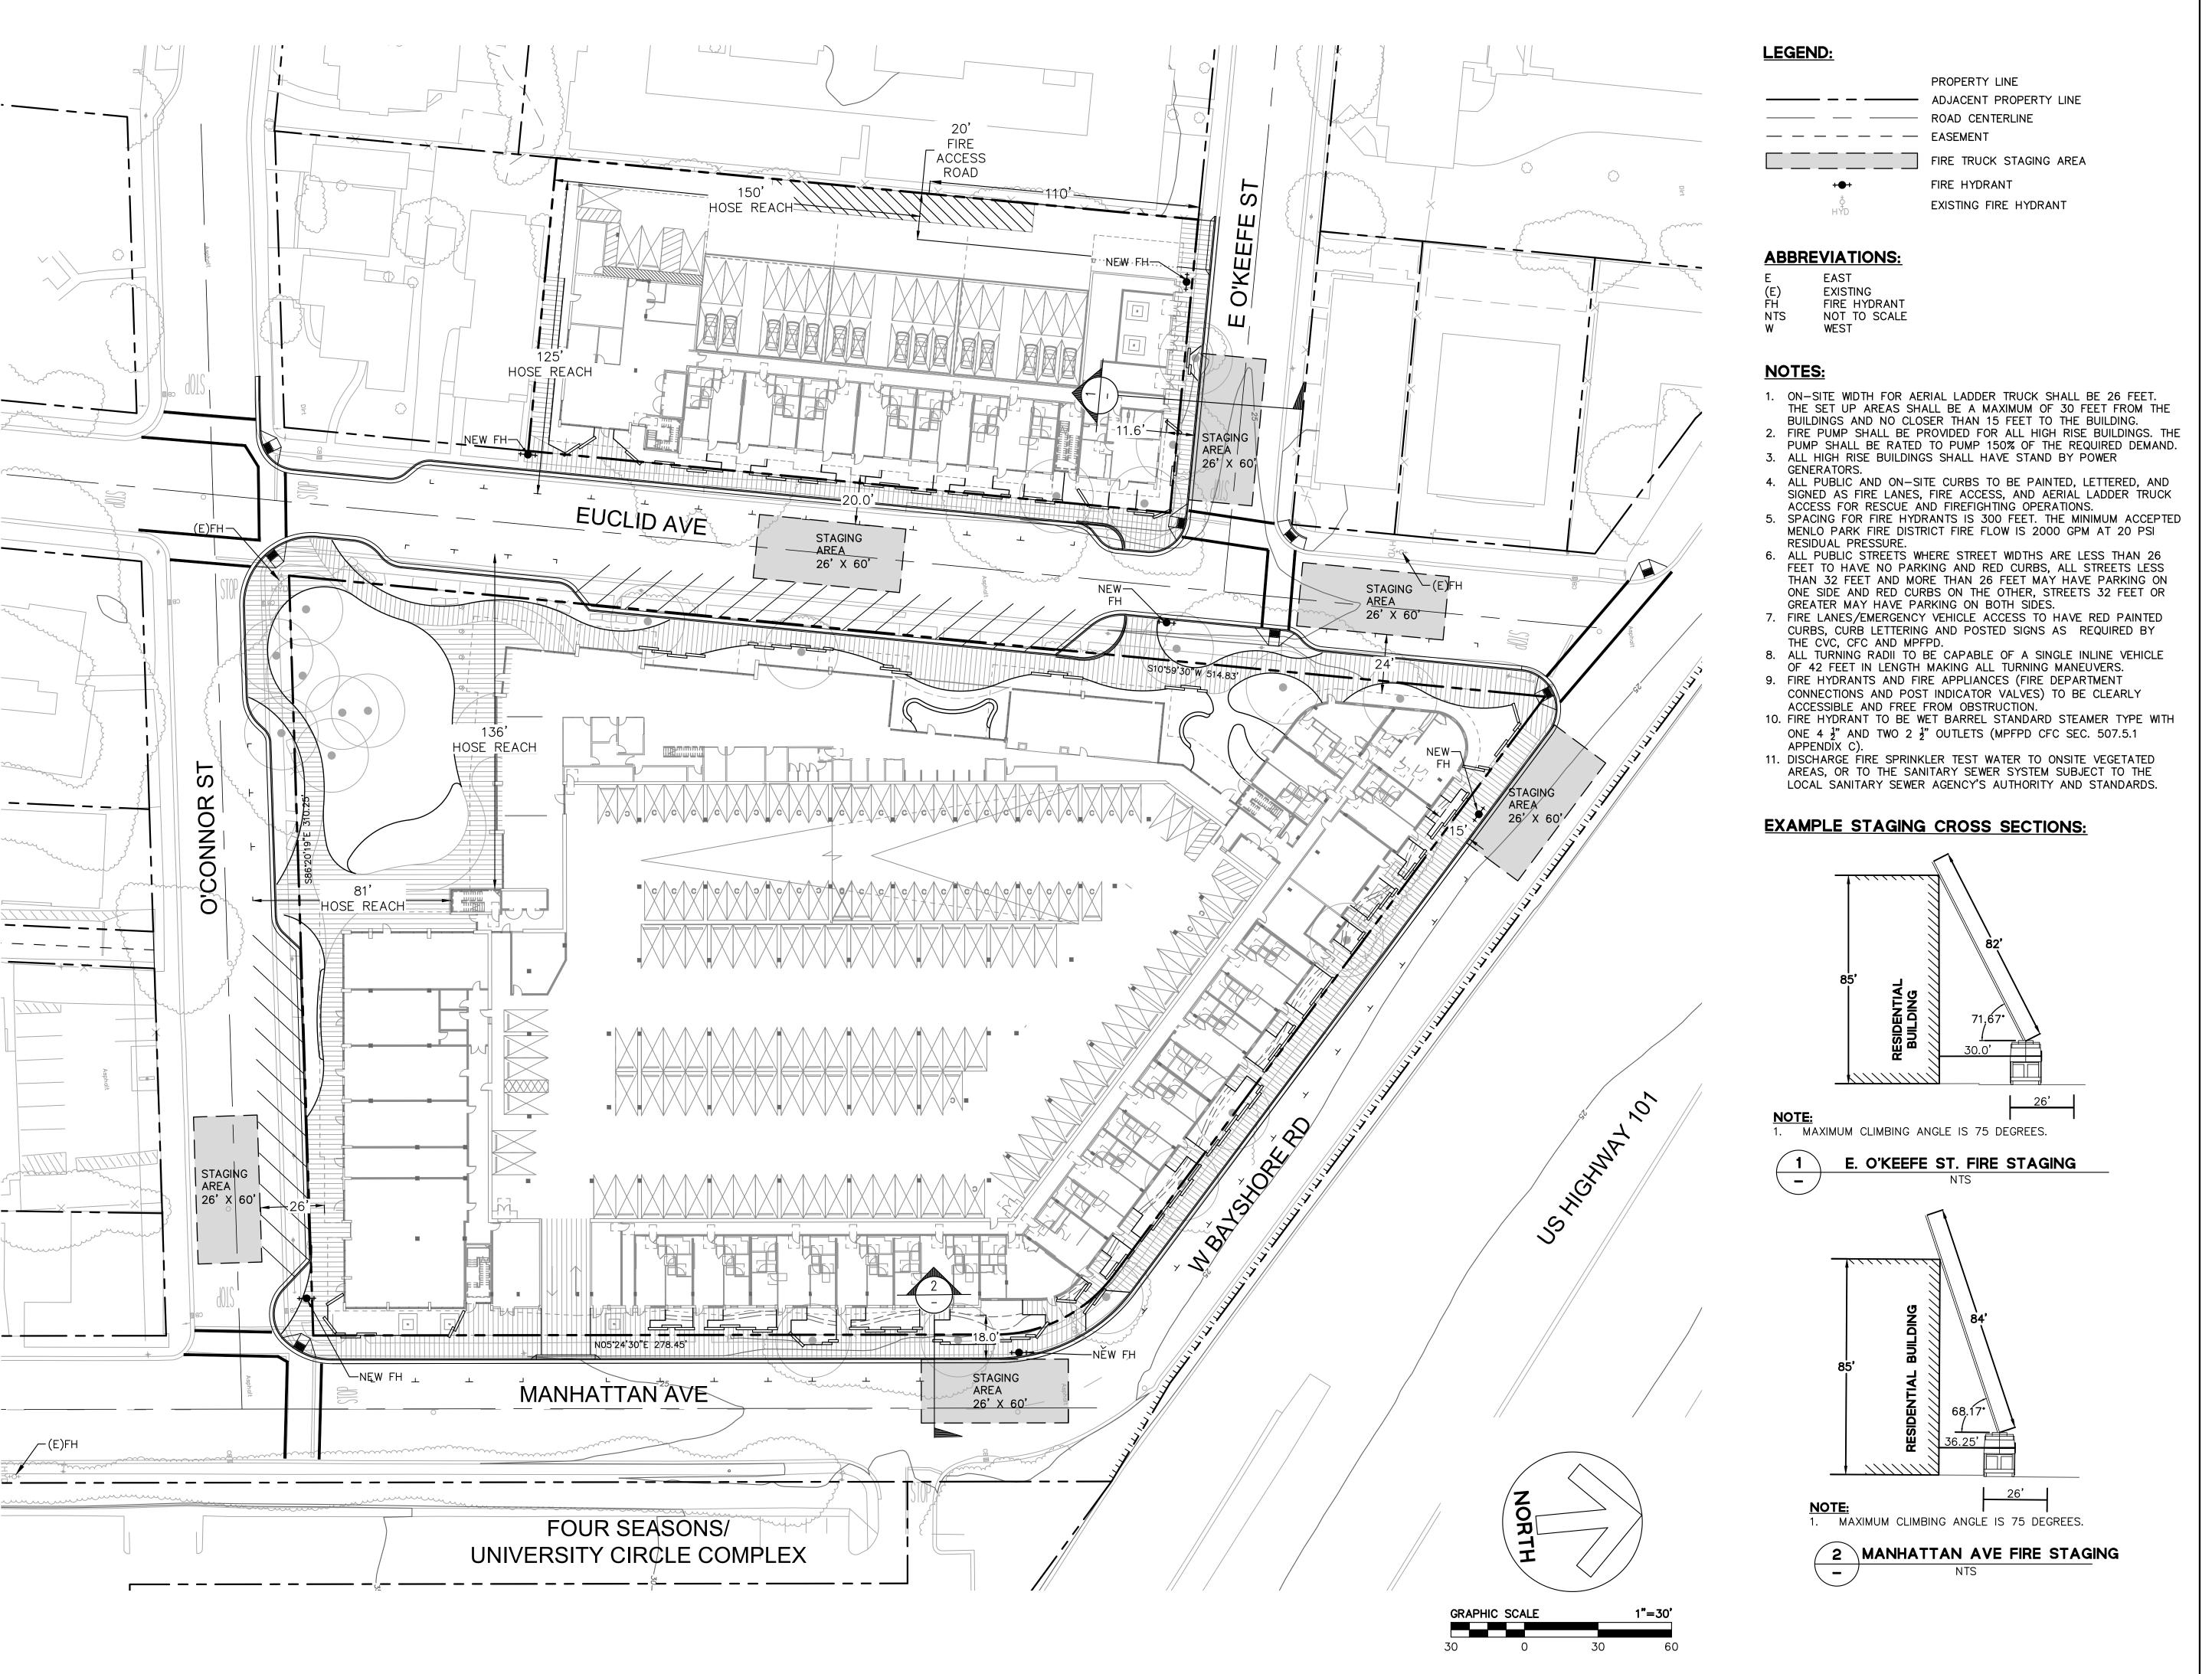

# Euclid Improvements

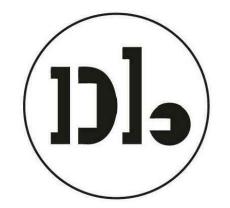

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**BKF ENGINEERS** 1730 N. FIRST STREET SUITE 600 SAN JOSE, CA 95112 (408) 467-9100

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	Issuances
Description	Date
Design Update	02/27/2024

		Revisions
Rev.	Description	Date

1 Response to Comments 4/19/2024

Design Update -April 2024

**Drawing Title** 

PRELIMINARY FIRE ACCESS PLAN

C6.0


04/19/2024 20166089-20 Project No.



2 DONOHOE ST. ELEVATION 1/16" = 1'-0"

# PUMP HOUSE WATER TANK DUMBARTON AVE.

W.BAYSHORE ELEVATION
1/16" = 1'-0"

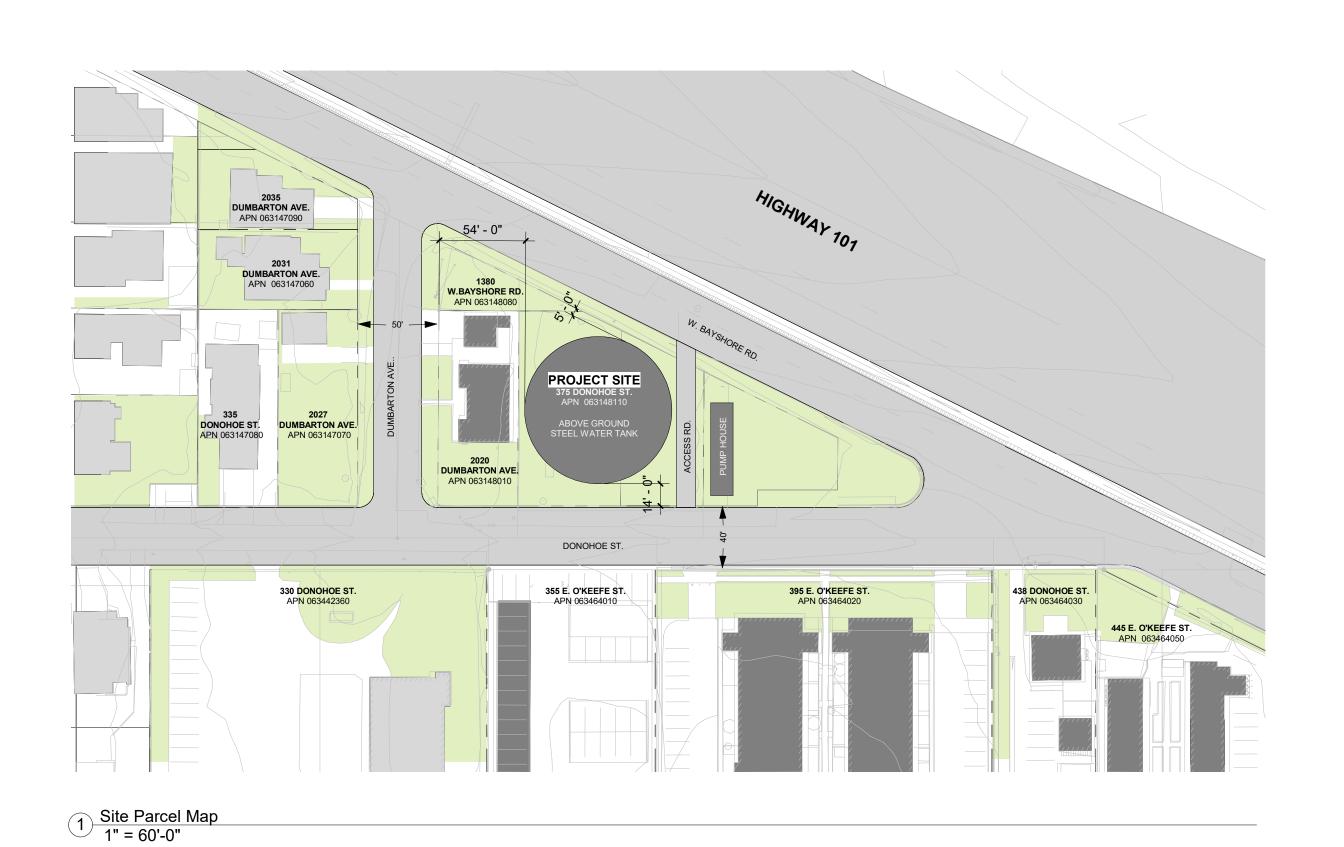



3D View - Donohoe St.

# Woodland Park Euclid Improvements



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	Issuances
Description	Date
Entitlements Submission	09/25/2019

		Revisions
Rev.	Description	Date
		-

Set Title

Application - September 2019

**Drawing Title** 

WATER TANK **EXHIBIT** 

WT-001

21620

08/19/2022 Project No.