



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No	. R	Δ	Т	L	N-COORDINATE	E-COORDINATE
12	/ 1030	58° 32′45''	588.58′	1072.91′	1994123.10	6084400.81
(15	449′	07°26′31"	29.20′	58.32′	1993845.93	6084870.39
16	880′	09°22′21"	72.14′	143.95′	1994052.08	6084491.89

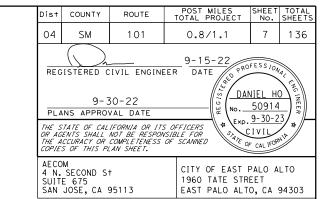

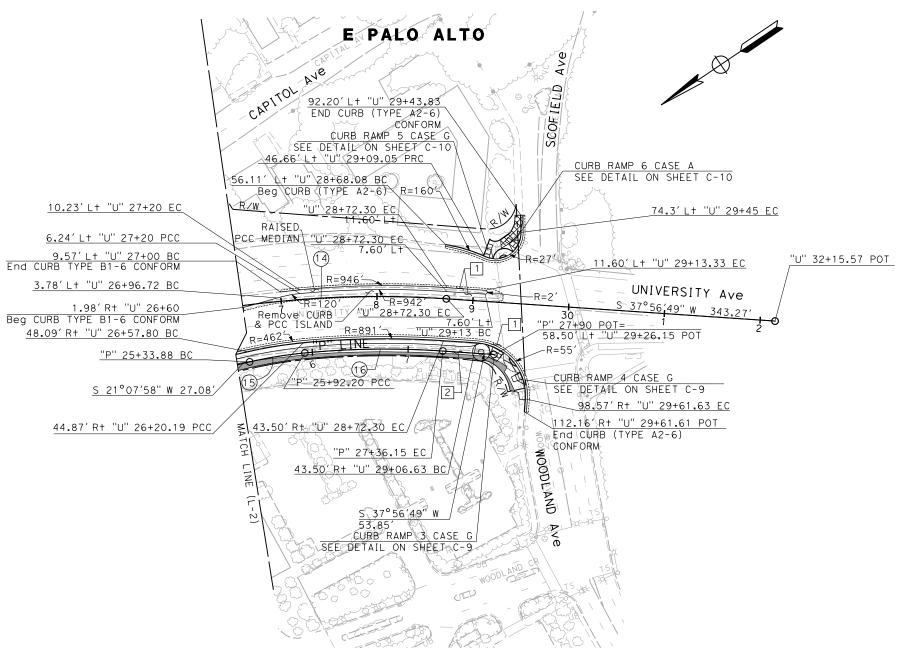

LAYOUT

SCALE 1'' = 50'

L-3

USERNAME => jose.corone! DGN FILE => 04000007591ea003.dgn RELATIVE BORDER SCALE IS IN INCHES


UNIT 0703


PROJECT NUMBER & PHASE


LEGEND, SEE SHEET L-1

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FOR NOTES, ABBREVIATIONS AND



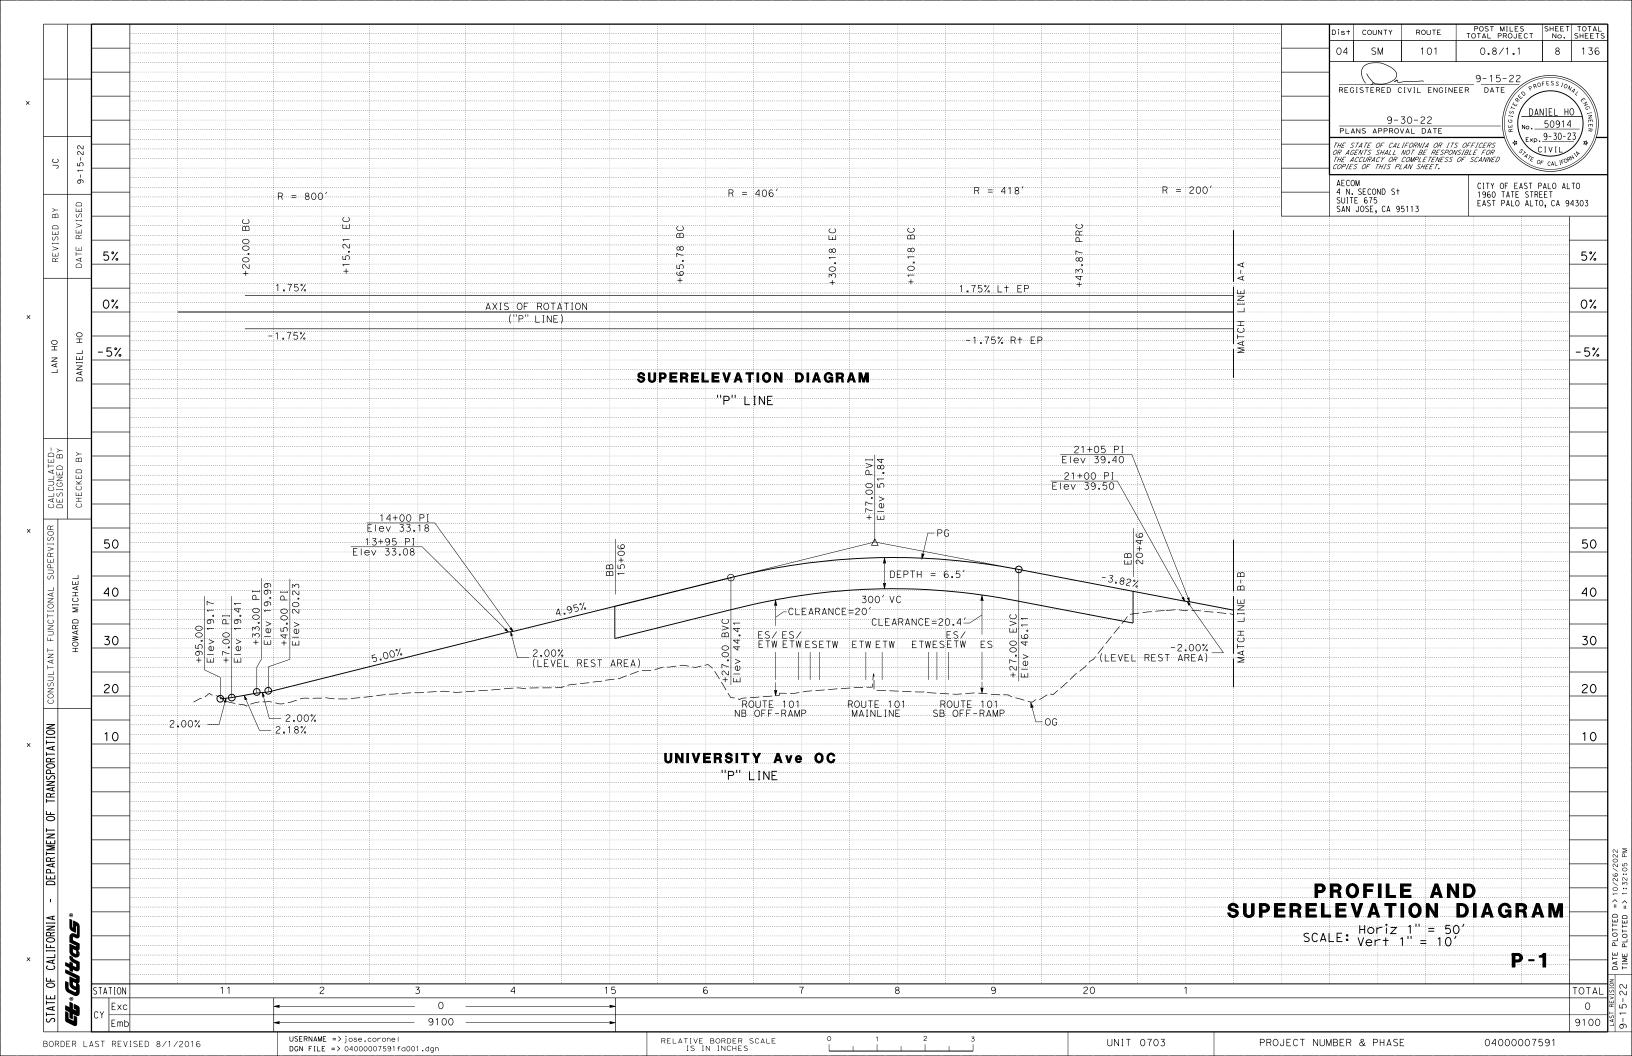

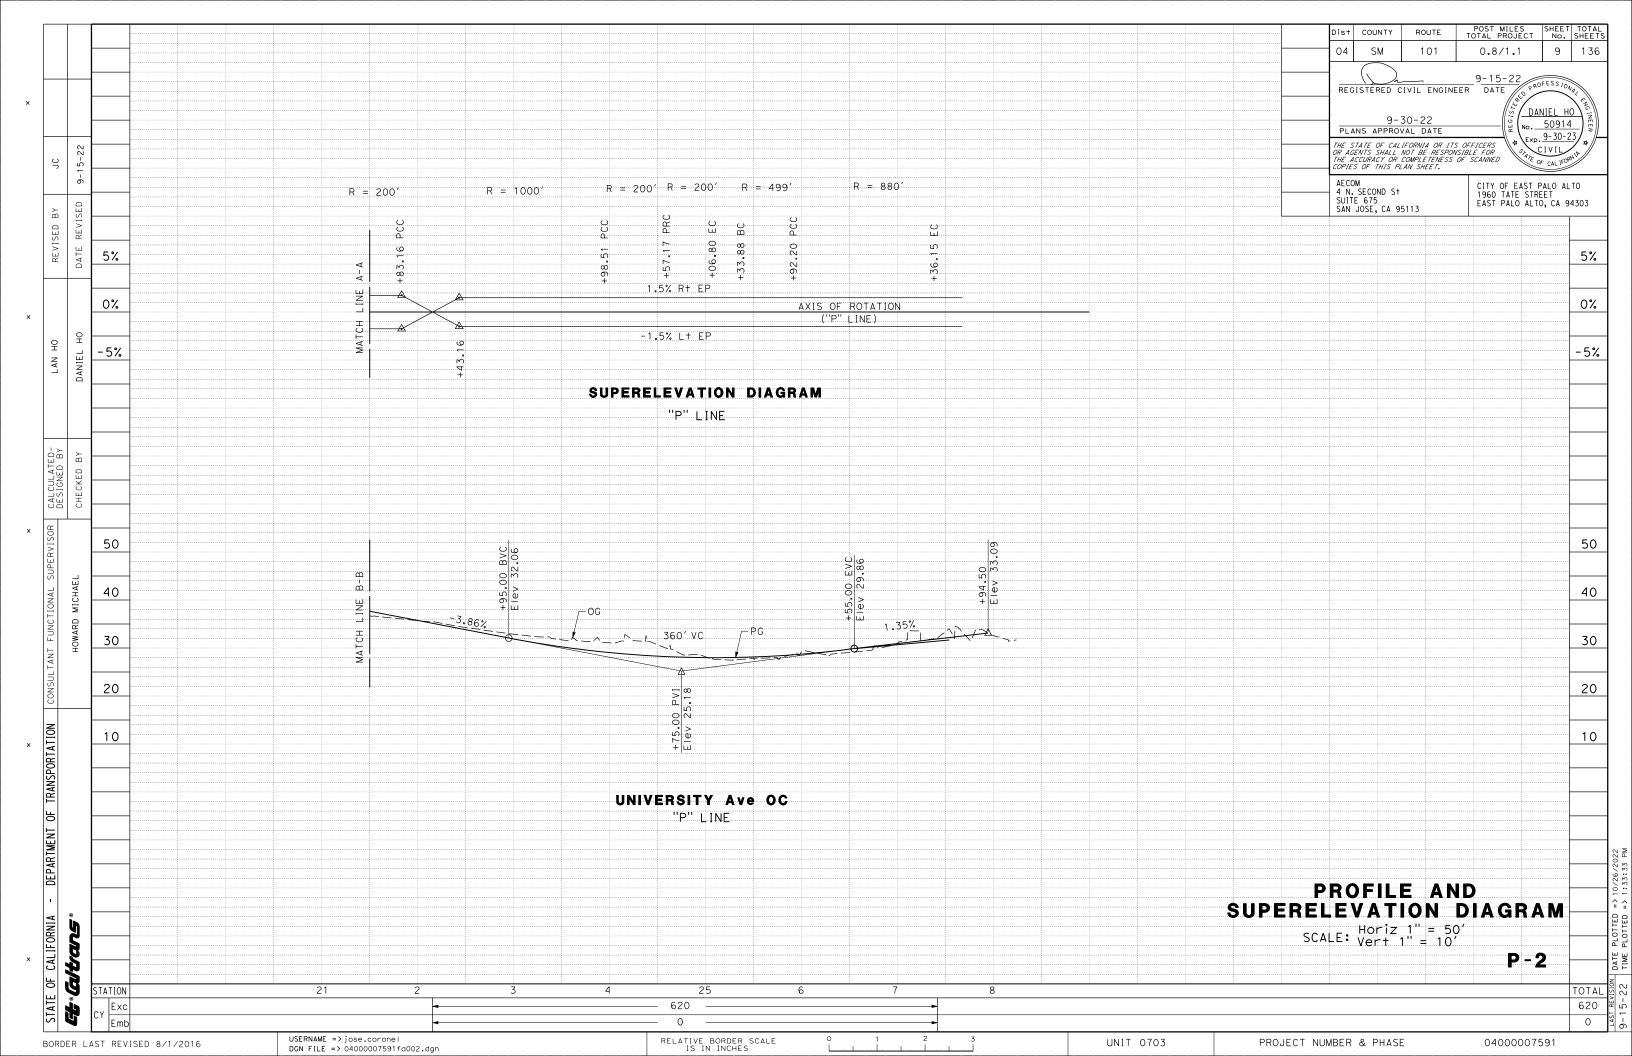

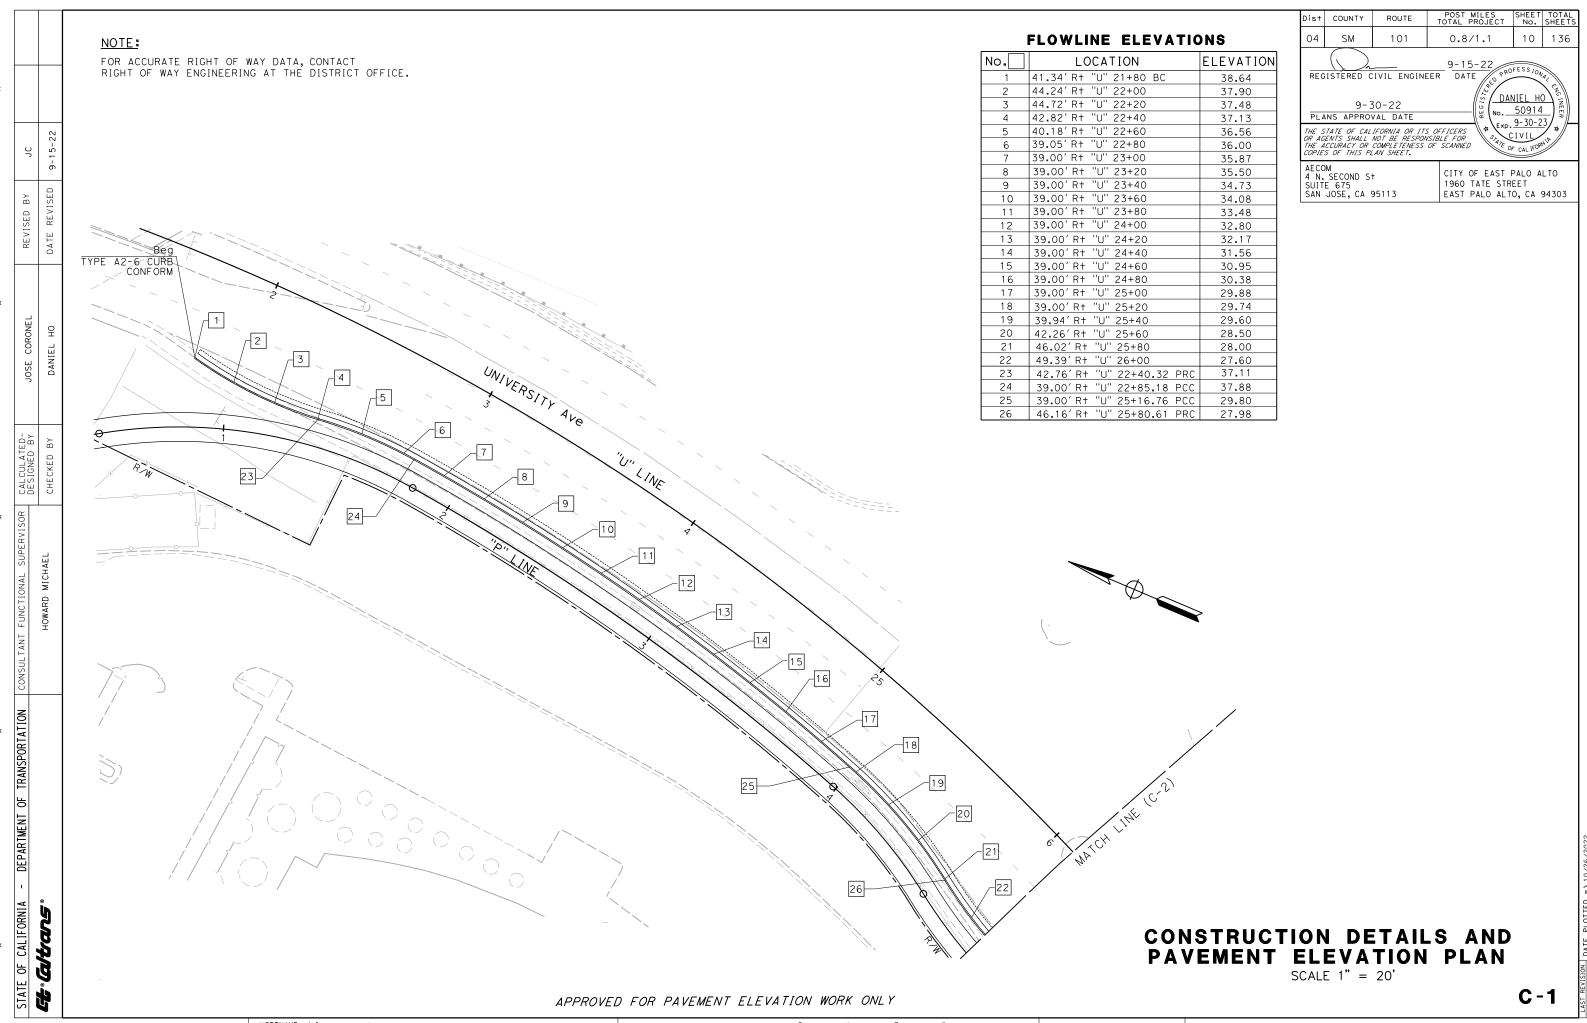04000007591

BORDER LAST REVISED 8/1/2016

USERNAME => jose.corone! DGN FILE => 04000007591ga001.dgn RELATIVE BORDER SCALE IS IN INCHES

UNIT 0703

PROJECT NUMBER & PHASE

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OF CALIFORNIA

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FOR ACCURATE RIGHT OF WAY DATA, CONTACT RIGHT OF WAY ENGINEERING AT THE DISTRICT OFFICE.

FLOWLINE ELEVATIONS

No.	LOCATION	ELEVATIO
27	50.44′R+ "U" 26+20	27.28
28	50.14' R+ "U" 26+29.47 EC	27.18
29	49.46′R+ "U" 26+40	27.12
30	48.09' R+ "U" 26+57.80 BC	27.05
31	47.90'R+ "U" 26+60	27.01
32	46.46′R+ "U" 26+80	26.81
33	45.45' R+ "U" 27+00	26.96
34	44.87′ R+ "U" 27+20	26.77
35	44.87' R+ "U" 27+20.19 PCC	26.77
36	44.54′ R† "U" 27+40	26.93
37	44.25′ R† "U" 27+60	27.11
38	44.00′ R† "U" 27+80	27.44
39	43.81′R+ "U" 28+00	27.79
40	43.66′ R+ "U" 28+20	28.29
41	43.56′ R+ "U" 28+40	28.71
42	43.50' R+ "U" 28+60	29.08
43	43.50' R+ "U" 28+72.30 EC	29.38
44	43.50' R+ "U" 28+80	29.60

FLOWLINE ELEVATIONS


No.	LOCATION	ELEVATION
45	43.50'R+ "U" 29+00	30.15
46	43.50'R+ "U" 29+06.63 BC	30.41
47	59.63'R+ "U" 29+45.54 MP	31.33
48	98.57 Rt "U" 29+61.63 EC	32.18
49	112.16' R+ "U" 29+61.61	31.97

FLOWLINE ELEVATIONS

No.	LOCATION	ELEVATION
50	1.98'R+ "U" 26+60	28.35
51	1.02'L+ "U" 26+80	28.32
52	3.78'L+ "U" 26+96.72 BC	28.35
53	4.37' L+ "U" 27+00	28.38
54	6.24′L+ "U" 27+20	28.39
55	6.57'L+ "U" 27+40	28.50
56	6.86′L+ "U" 27+60	28.54
57	7.10′L+ "U" 27+80	28.79
58	7.30'L+ "U" 28+00	29.16
59	7.44'L+ "U" 28+20	29.45
60	7.54′L† "U" 28+40	29.82
61	7.59′L+ "U" 28+60	30.15
62	7.60′L+ "U" 28+80	30.65
63	7.60'L+ "U" 29+00	31.17
64	7.60′L+ "U" 29+20	31.60
65	11.60′L† "U" 29+20	31.47
66	11.60′L† "U" 29+00	31.05
67	11.60'L+ "U" 28+80	30.48


FLOWLINE ELEVATIONS

No.	LOCATION	ELEVATION
68	11.60'L+ "U" 28+60	29.93
69	11.54′L+ "U" 28+40	29.49
70	11.44'L+ "U" 28+20	29.14
71	11.29'L+ "U" 28+00	28.90
72	11.10'L+ "U" 27+80	28.68
73	10.86'L+ "U" 27+60	28.30
74	10.57'L+ "U" 27+40	28.10
75	10.24'L+ "U" 27+20	28.02
76	9.57' L+ "U" 27+00	28.09
77	56.11'L+ "U" 27+68.08 BC	29.50
78	46.66'L+ "U" 29+09 PRC	31.12
79	46.84′R+ "U" 29+28 HP	31.35
80	74.30′L+ "U" 29+45.39 EC	31.13
81	92.20' L+ "U" 29+44	31.05

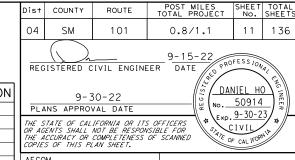

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CONSTRUCTION DETAILS AND PAVEMENT ELEVATION PLAN

SCALE 1" = 20'

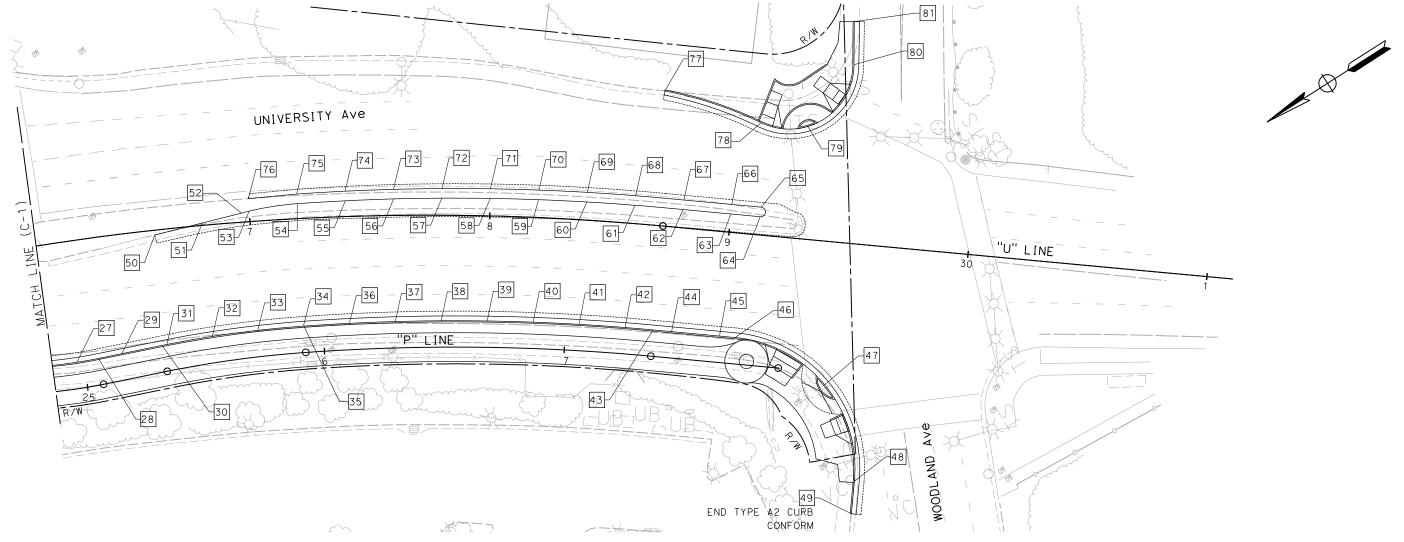APPROVED FOR PAVEMENT ELEVATION WORK ONLY

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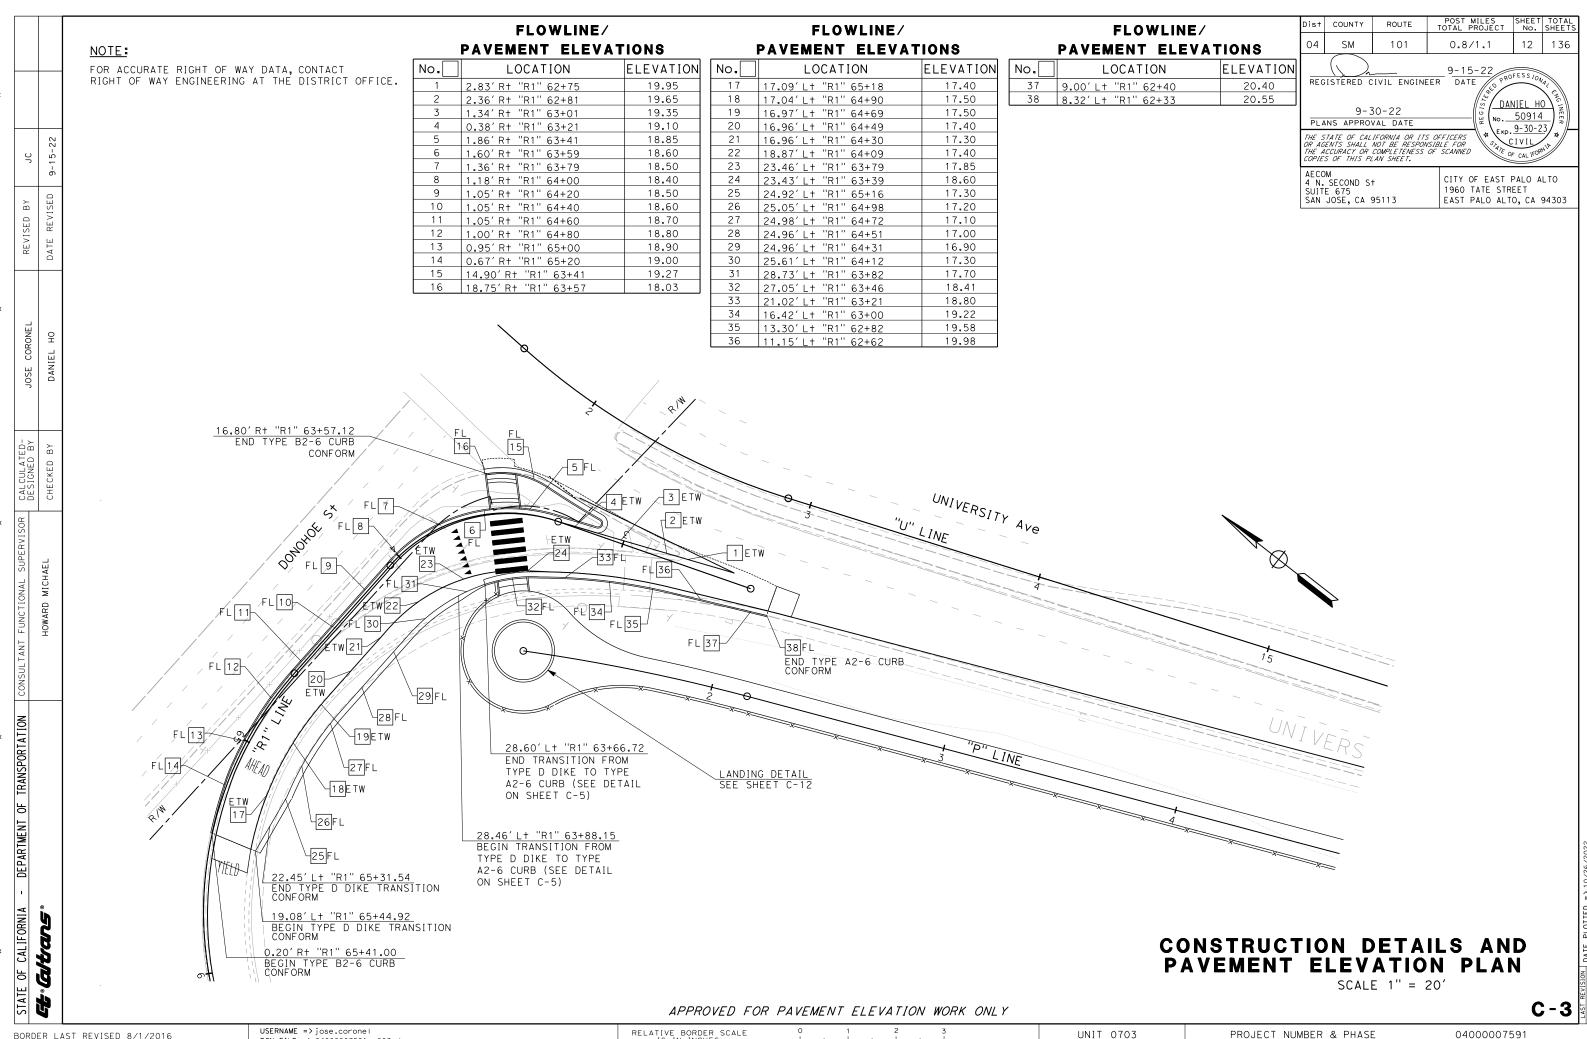
RELATIVE BORDER SCALE IS IN INCHES

UNIT 0703

PROJECT NUMBER & PHASE

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C-2



DGN FILE => 04000007591ga003.dgn

RELATIVE BORDER SCALE IS IN INCHES

UNIT 0703

REGISTERED CIVIL ENGINEER DATE DANIEL HO 9-30-22 o. <u>50914</u> PLANS APPROVAL DATE Exp. 9-30-23 THE STATE OF CALIFORNIA OR ITS OFFICERS
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AECOM 4 N. SECOND S† SUITE 675 SAN JOSE, CA 95113 CITY OF EAST PALO ALTO 1960 TATE STREET EAST PALO ALTO, CA 94303

04

P	AVEMENT ELEVATI	ONS
No.	LOCATION	ELEVATION
10	25.50′R+ "R2" 79+06	19.08
11	28.52' R+ "R2" 79+20	18.92
12	34.15' R+ "R2" 79+40	18.54
13	39.14' R+ "R2" 79+60	18.08
14	43.63' R+ "R2" 79+80	17.44
15	47.59' R+ "R2" 80+00	16.59
16	51.01'R+ "R2" 80+20	16.00
17	53.84' R+ "R2" 80+40	15.80
18	56.08' R+ "R2" 80+60	15.79
19	57.76' R+ "R2" 80+80	15.90
20	58.87' R+ "R2" 81+00	16.13
21	59.42′R+ "R2" 81+20	16.44
22	59.42′R+ "R2" 81+40	16.82
23	58.85' R+ "R2" 81+60	17.85
24	57.72' R+ "R2" 81+80	18.61
25	56.06′R+ "R2" 82+00	19.28
26	53.51' R+ "R2" 82+20	20.11
27	52.16' R+ "R2" 82+40	21.46
28	52.23' R+ "R2" 82+60	23.08
29	52.30' R+ "R2" 82+80	24.48
30	52.37' R+ "R2" 83+00	25.75
31	55.31' R+ "R2" 83+20	26.96
32	59.88′R+ "R2" 83+40	27.79
33	64.53′ R+ "R2" 83+60	28.95
34	69.55′ R+ "R2" 83+80	29.81
35	93.90′R+ "R2" 84+10	32.67
36	104.67' R+ "R2" 84+15	33.59
37	118.84' R+ "R2" 84+20	34.38
38	137.00' R+ "R2" 84+25	35.02
39	166.60′R+ "R2" 84+30	35.62
45	45.81′R+ "R2" 79+03	17.53
46	50.13′R+ "R2" 79+20	16.94
47	50.29′R+ "R2" 79+40	17.17
48	47.88′R+ "R2" 79+60	17.33
49	52.07′R† "R2" 79+80	16.63
50	55.97′R+ "R2" 80+00	15.66
51	59.27′ R+ "R2" 80+20	15.03
52	62.04′R+ "R2" 80+40	14.81
53	64.21' R+ "R2" 80+60	14.8
54	65.82′R† "R2" 80+80	14.94
55	66.70' Rt "R2" 81+00	15.17
56	67.42′R+ "R2" 81+20	15.49
57	67.42' R+ "R2" 81+40	15.86

CONSTRUCTION DETAILS AND PAVEMENT ELEVATIONS

SCALE 1" = 20'

C-4

NOTE:

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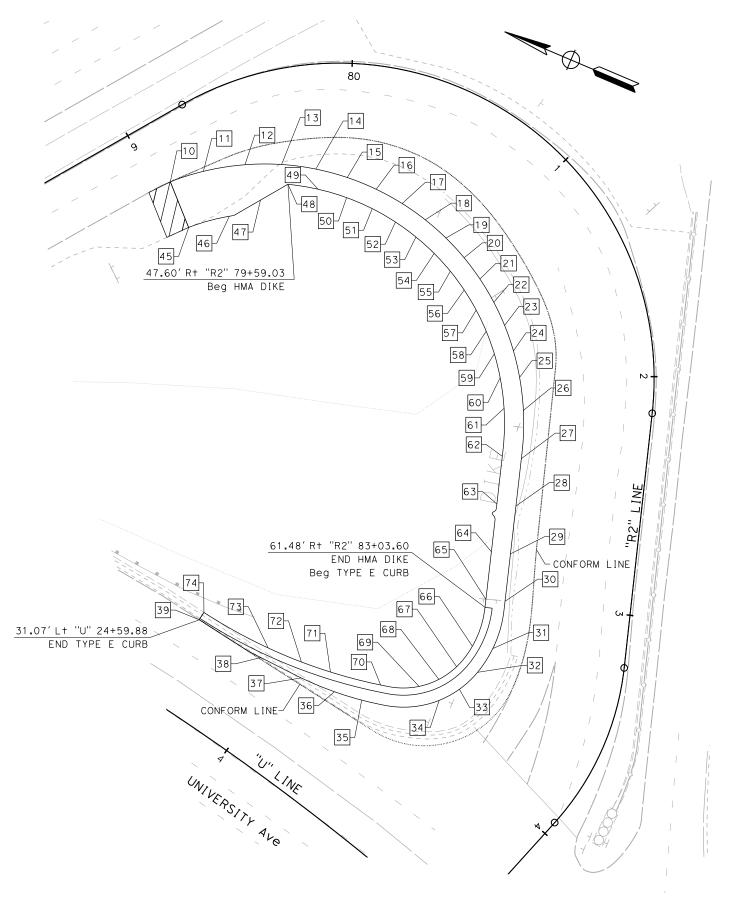
MICHAEL

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STATE OF CALIFORNIA et altars FOR ACCURATE RIGHT OF WAY DATA, CONTACT RIGHT OF WAY ENGINEERING AT THE DISTRICT OFFICE.

PAVEMENT ELEVATIONS

No.	LOCATION	ELEVATION
58	66.88′R+ "R2" 81+60	16.97
59	65.80' R+ "R2" 81+80	17.73
60	64.18' R† "R2" 82+00	18.37
61	61.62′R† "R2" 82+20	19.18
62	60.16′R† "R2" 82+40	20.6
63	60.23′ R† "R2" 82+60	22.39
64	60.30' R† "R2" 82+80	23.91
65	60.38′R+ "R2" 83+00	25.32
66	63.90' R+ "R2" 83+20	26.67
67	68.92′R† "R2" 83+40	27.60
68	74.05′R† "R2" 83+60	28.92
69	79.70′R† "R2" 83+80	29.81
70	92.27′R† "R2" 84+00	32.56
71	111.42'R+ "R2" 84+10	33.58
72	123.23′ R† "R2" 84+15	34.42
73	137.39' R+ "R2" 84+20	35.08
74	167.00' R† "R2" 84+27	35.58



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USERNAME => jose.corone! BORDER LAST REVISED 8/1/2016 DGN FILE => 04000007591ga004.dgn

UNIT 0703

PROJECT NUMBER & PHASE

04000007591

RELATIVE BORDER SCALE IS IN INCHES

RELATIVE BORDER SCALE
IS IN INCHES

UNIT 0703

PROJECT NUMBER & PHASE

BORDER LAST REVISED 8/1/2016

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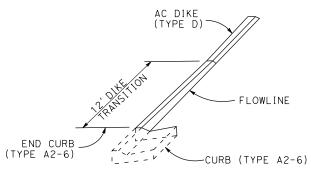
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136


CITY OF EAST PALO ALTO 1960 TATE STREET EAST PALO ALTO, CA 94303



TRANSITION FROM CURB (TYPE A2-6) TO AC DIKE (TYPE D)

CONSTRUCTION DETAILS

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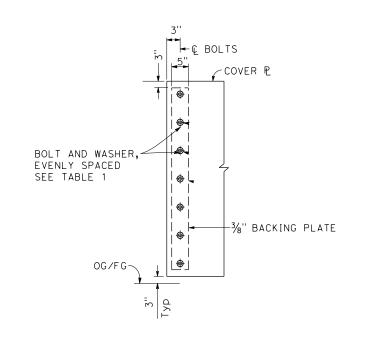

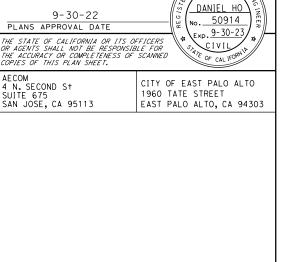
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POST MILES SHEET TOTAL TOTAL PROJECT No. SHEETS

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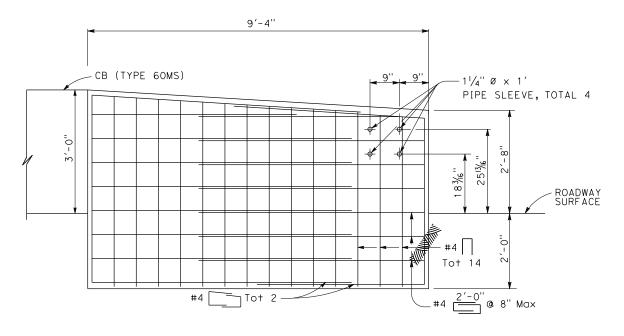
136



ELEVATION DETAIL 2

	TABLE 1	
L (f+)	PLATE * THICKNESS (in)	TOTAL NO. OF BOLTS
8'-6" Max	7∕8	10

PLATE STRUCTURAL STEEL SHALL BE ASTM A709 GRADE 50 UNLESS OTHERWISE NOTED.



-COVER PLATE FLUSH

-COLUMN

w/CONCRETE

-BACKING


PLATE

-SLOTTED

HOLE

ELEVATION CB (ANCHOR BLOCK) FOR TRANSITION RAILING CONNECTION

DETAIL A

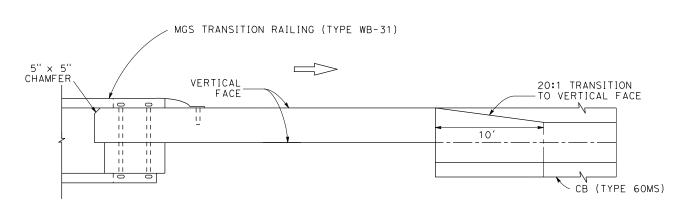

PLAN VIEW

NOTE:

- 1. FOR ADDITIONAL DETAILS OF A TYPICAL CONNECTION TO ANCHOR BLOCK SEE CONECTION DETAIL DD ON REVISED S+d PLAN RSP A77U3.
- 2. FOR ADDITIONAL DETAILS OF MGS TRANSITION RAILING (TYPE WB-31) SEE REVISED Std PLAN RSP A77U4.

CONSTRUCTION DETAILS

NO SCALE

APPROVED FOR PAVEMENT ELEVATION WORK ONLY

C-6

USERNAME => jose.corone! DGN FILE => 04000007591ga006.dgn

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BORDER LAST REVISED 8/1/2016

5%" Ø HEX HD BOLT AND WASHER, SEE TABLE 1

5/8" Ø × 31/2" LONG HEX HD BOLT

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1/2"± GAP

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EXPANDED

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PLAN

DETAIL 1

RELATIVE BORDER SCALE IS IN INCHES

UNIT 0703

PROJECT NUMBER & PHASE

REGISTERED CIVIL ENGINEER DATE


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Dist COUNTY

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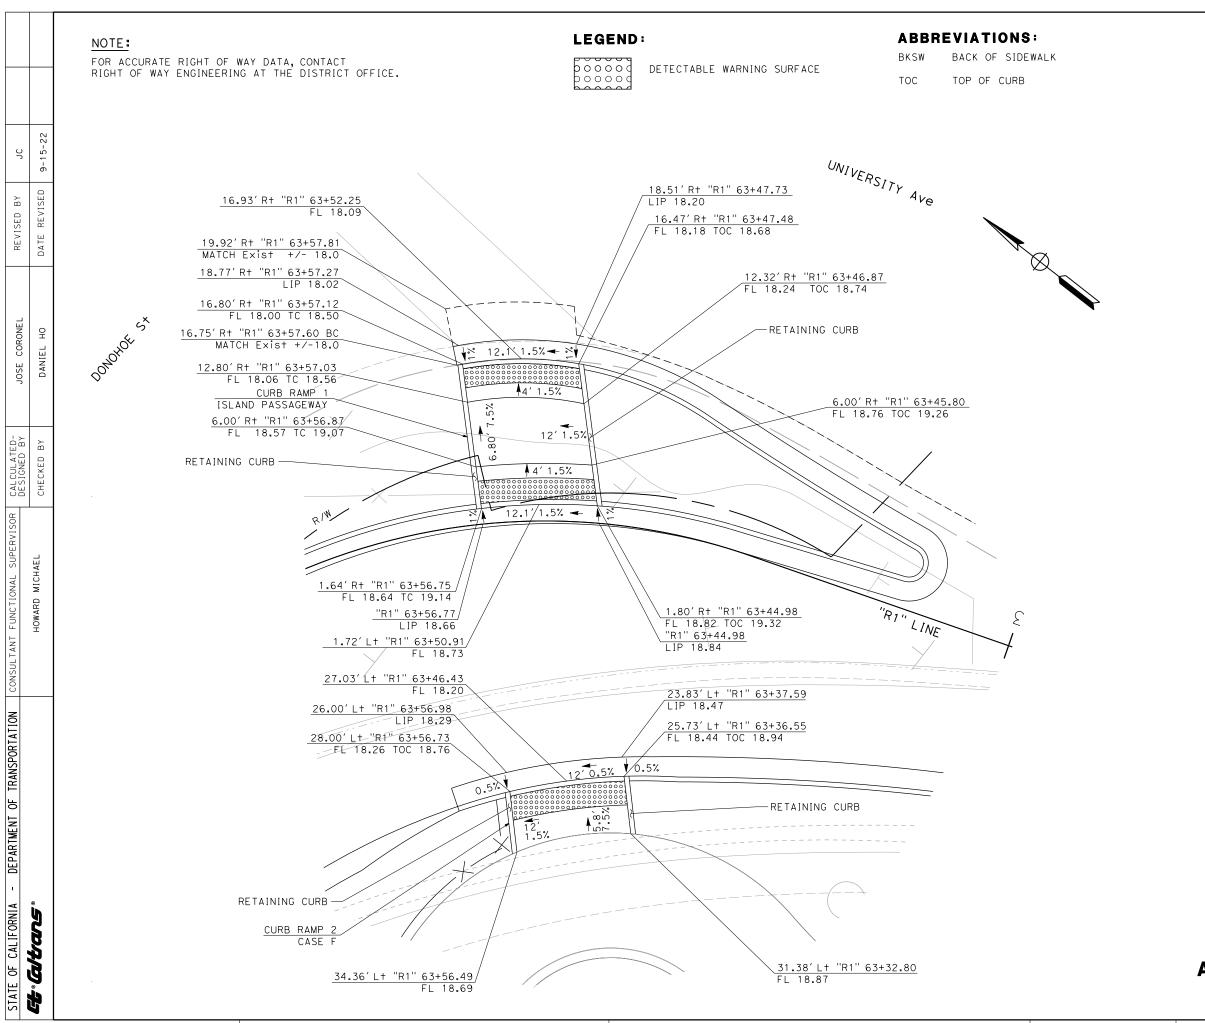
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RELATIVE BORDER SCALE IS IN INCHES

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POST MILES SHEET TOTAL TOTAL PROJECT No. SHEETS Dist COUNTY 17 04 136 SM 101 0.8/1.1 REGISTERED CIVIL ENGINEER DATE DANIEL HO 9-30-22 。. 50914 PLANS APPROVAL DATE Exp. 9-30-23 THE STATE OF CALIFORNIA OR ITS OFFICERS OR AGENTS SHALL NOT BE RESPONSIBLE FOR THE ACCURACY OR COMPLETENESS OF SCANNED COPIES OF THIS PLAN SHEET. CIVIL AECOM 4 N. SECOND S† SUITE 675 SAN JOSE, CA 95113 CITY OF EAST PALO ALTO 1960 TATE STREET EAST PALO ALTO, CA 94303

CONSTRUCTION DETAILS AND PAVEMENT ELEVATIONS

SCALE 1'' = 10'

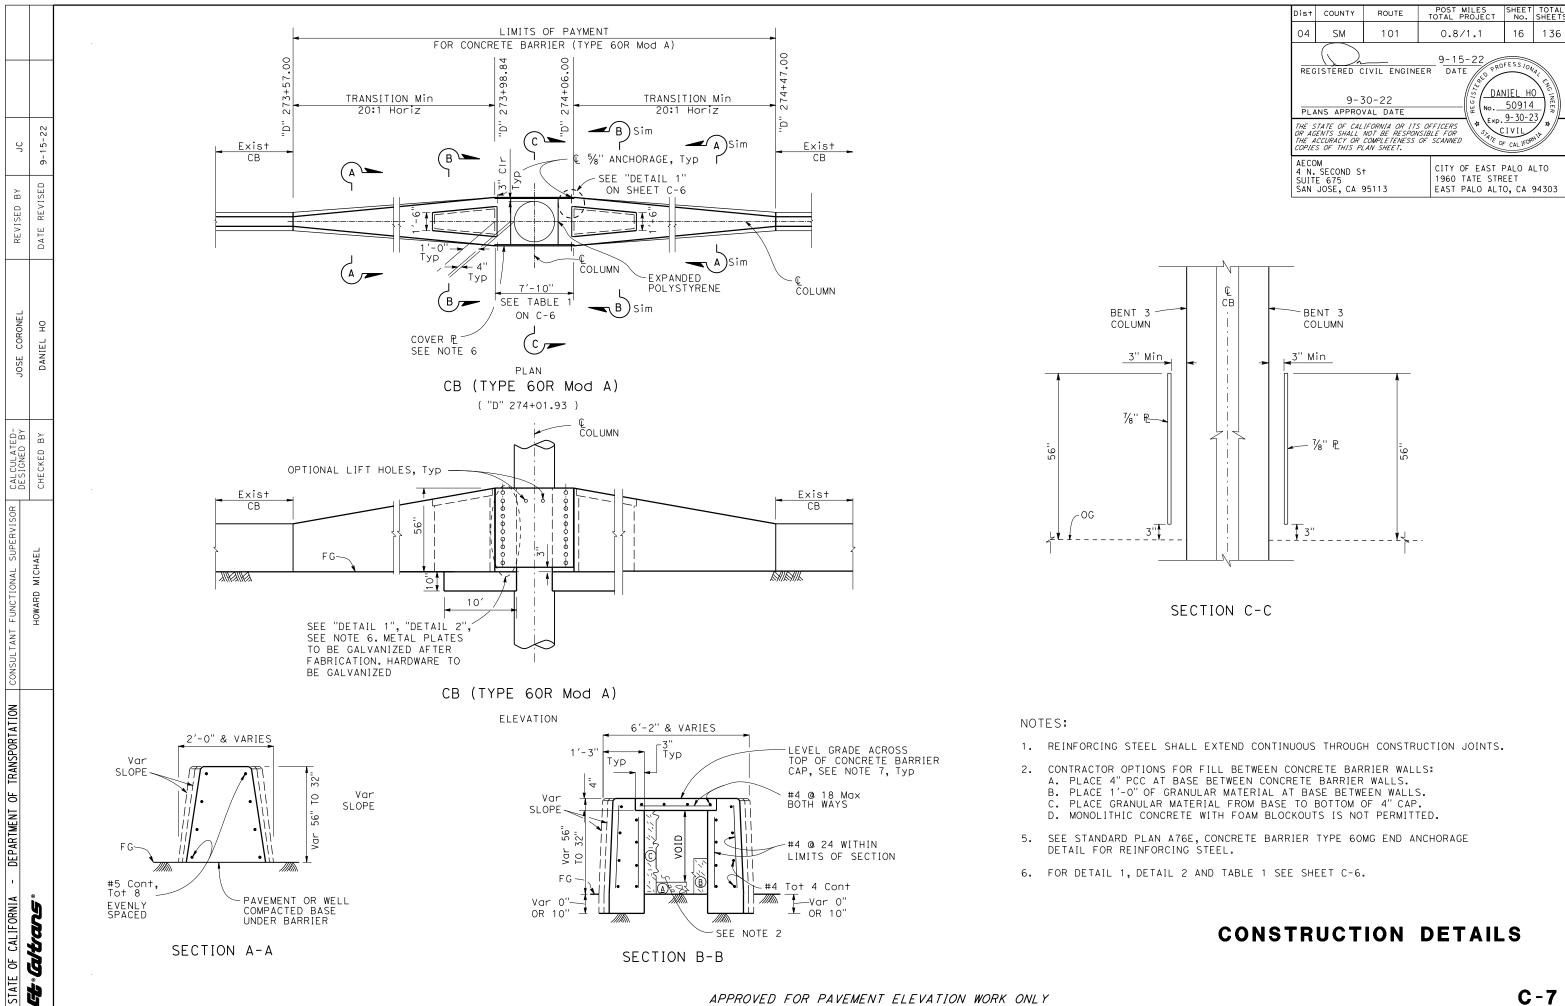
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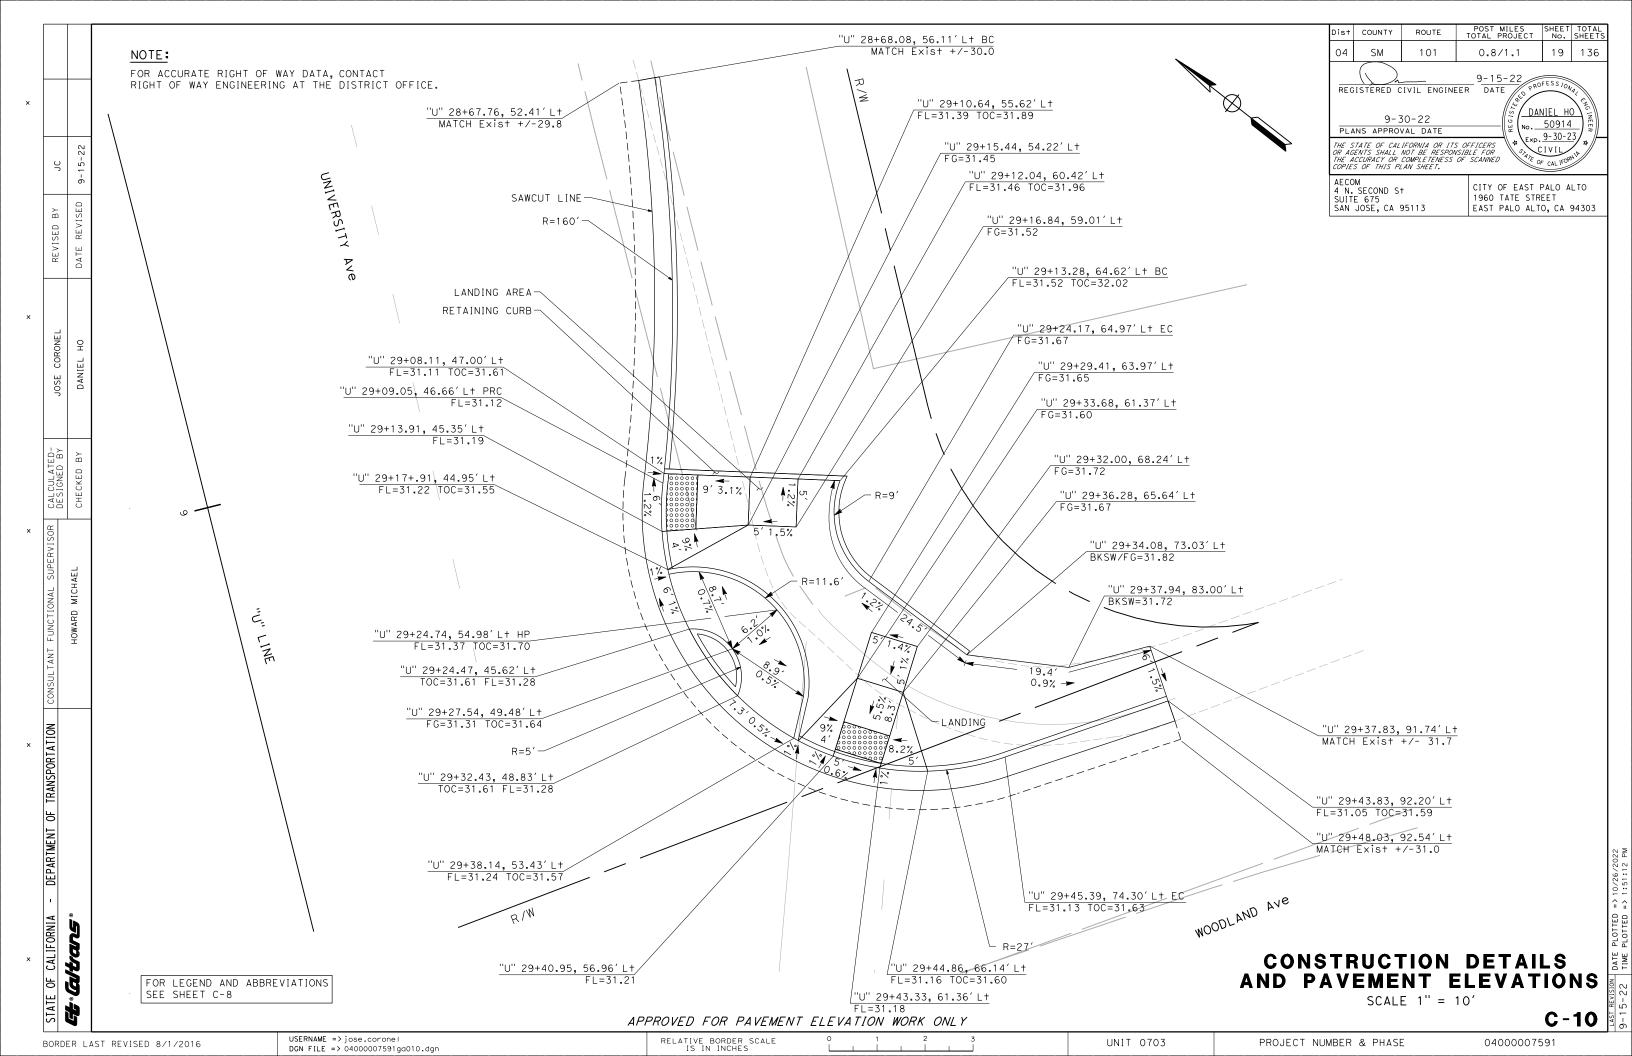
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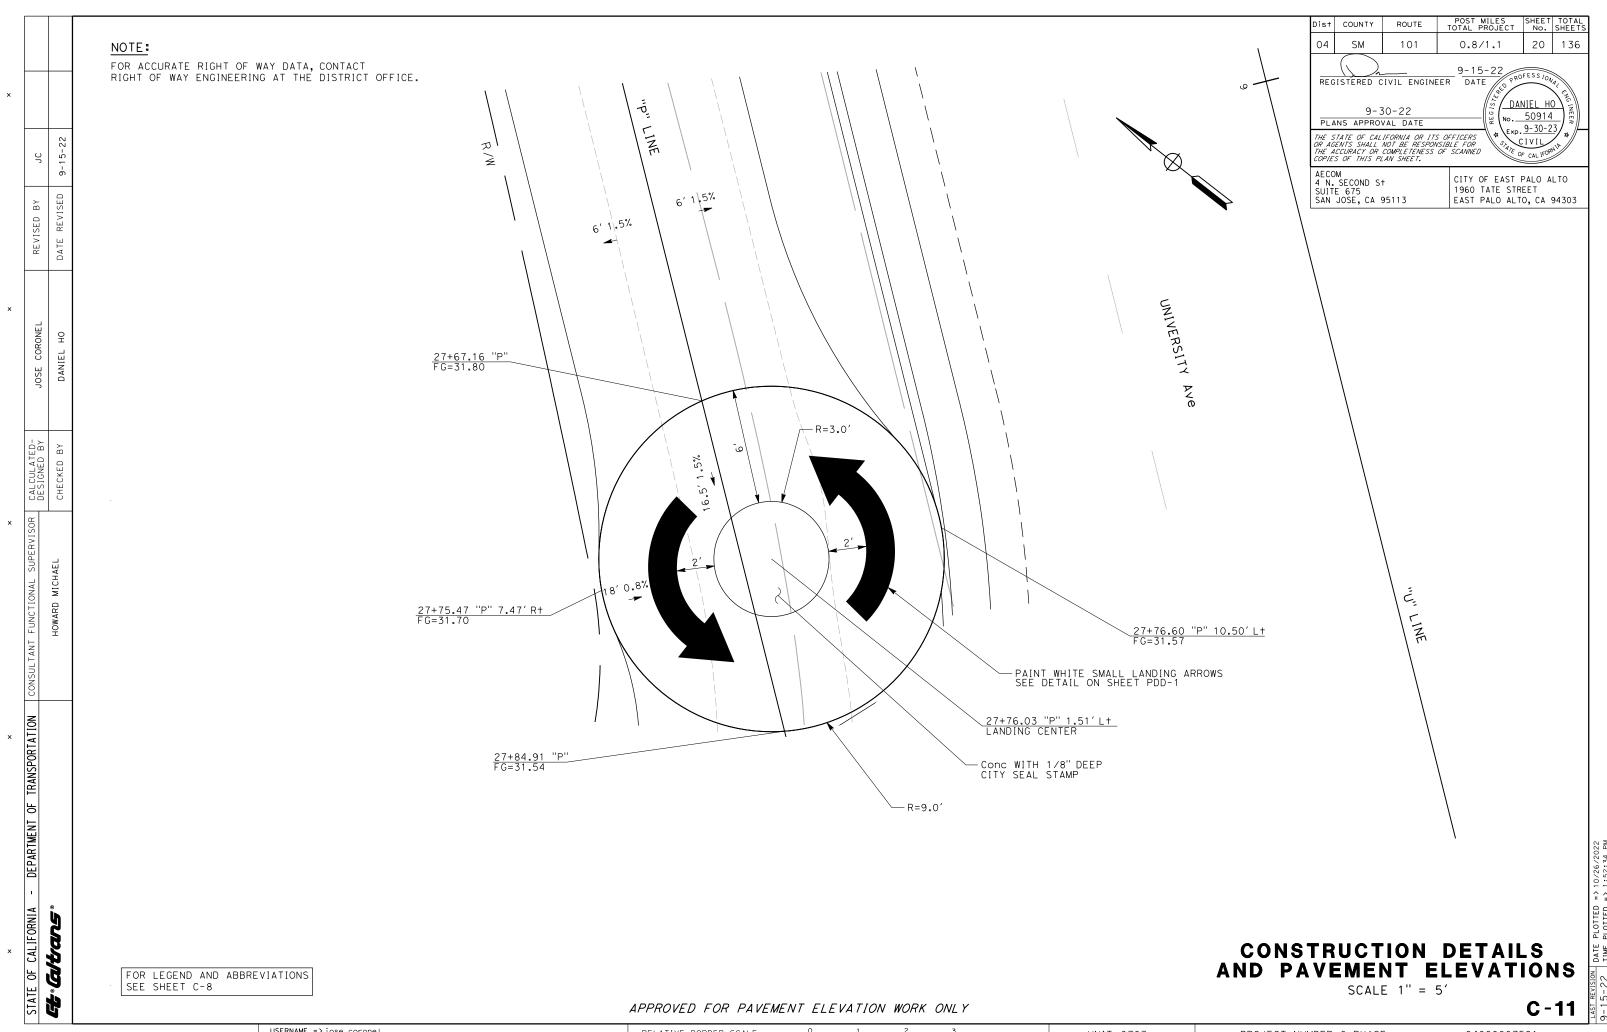
UNIT 0703

PROJECT NUMBER & PHASE

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UNIT 0703

PROJECT NUMBER & PHASE

FOR LEGEND AND ABBREVIATIONS SEE SHEET C-8
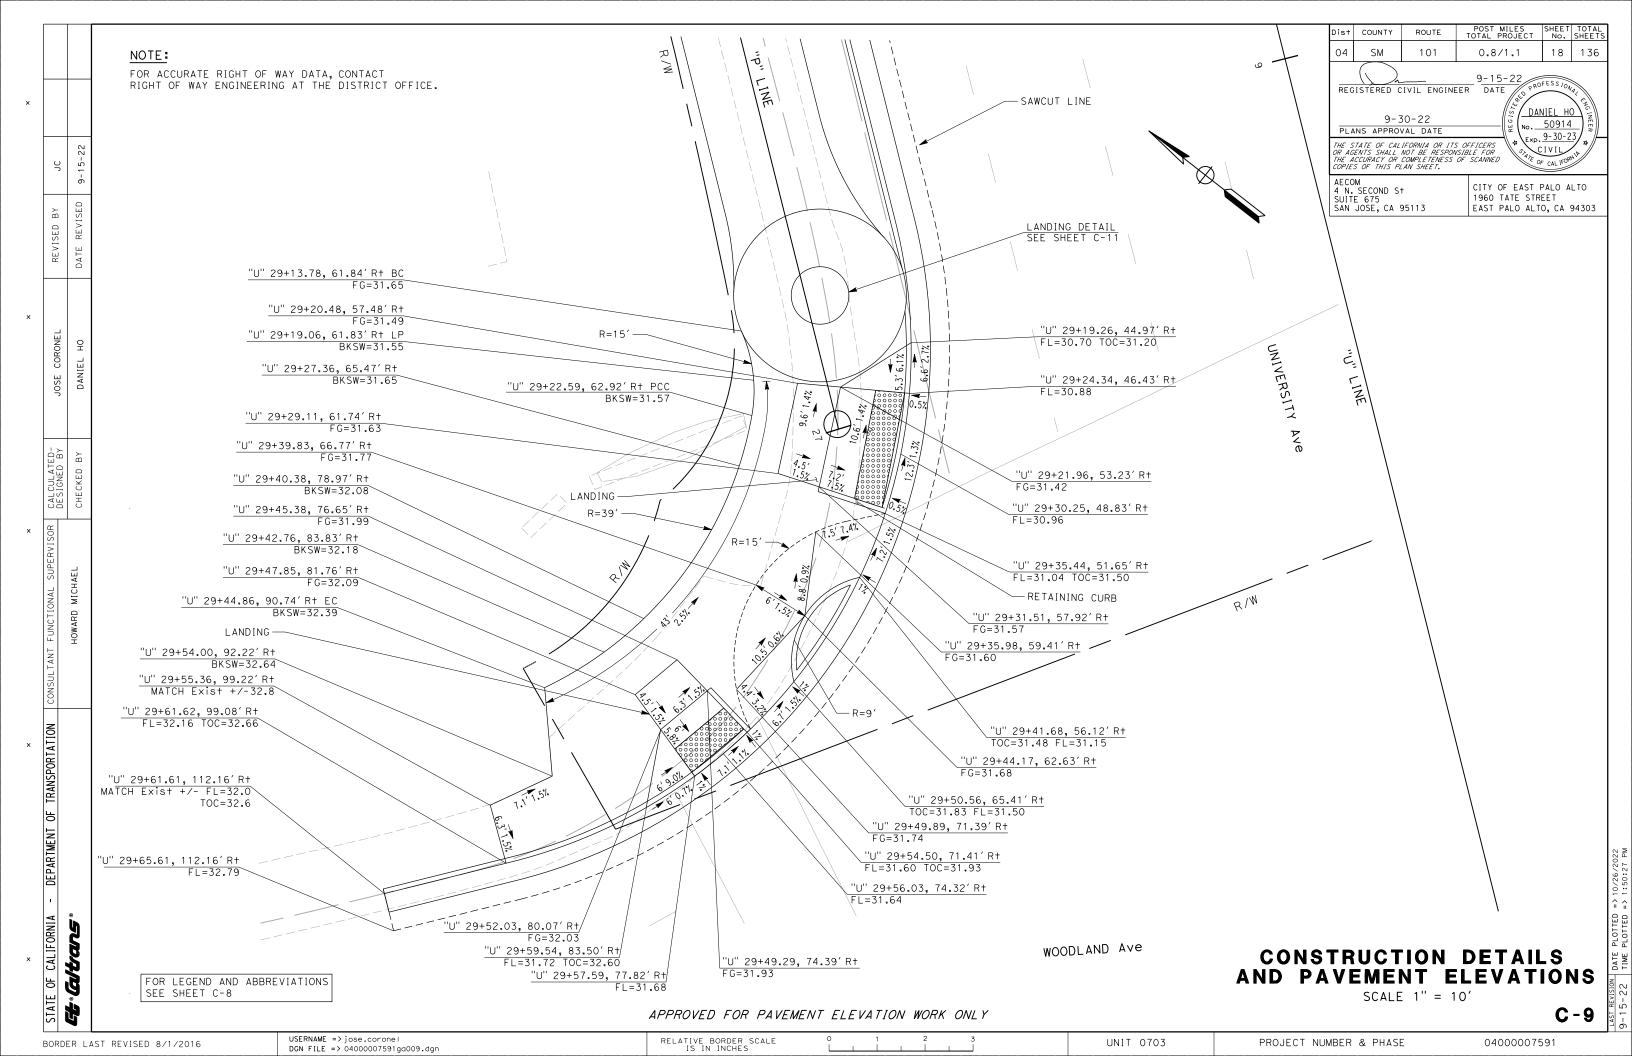
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CONSTRUCTION DETAILS AND PAVEMENT ELEVATIONS

SCALE 1'' = 5'

C-12

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BORDER LAST REVISED 8/1/2016

PROJECT NUMBER & PHASE

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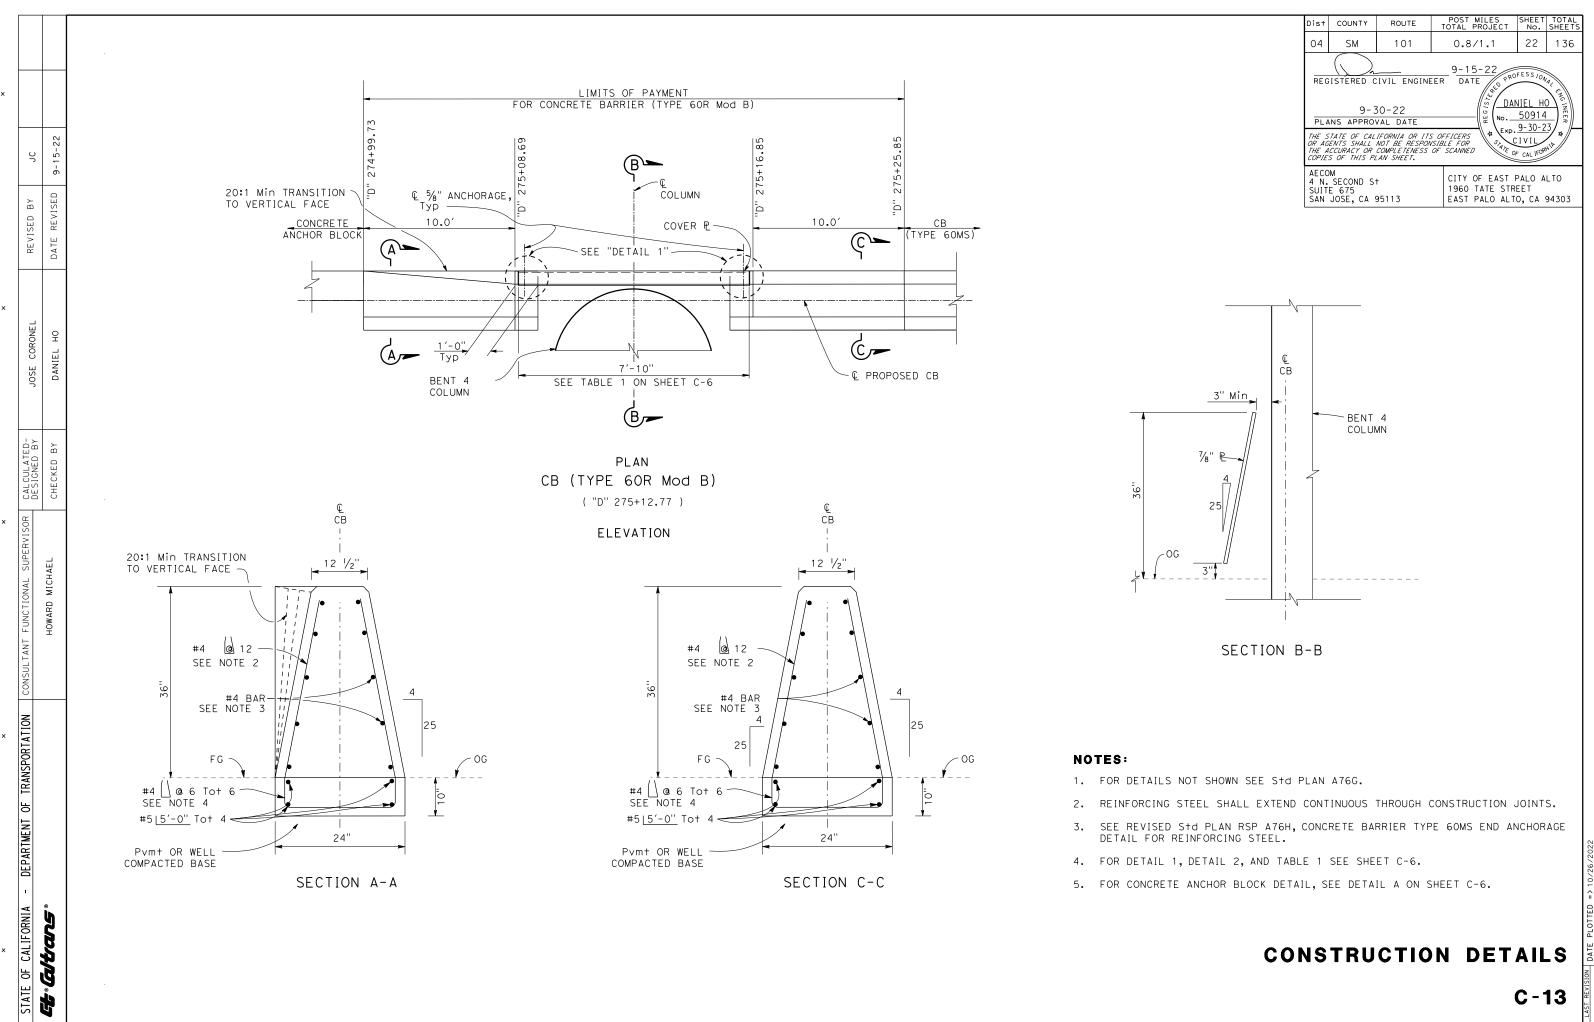
UNIT 0703

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DANIEL HO

ю.<u>50914</u> Exp. 9-30-23





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UNIT 0703

PROJECT NUMBER & PHASE



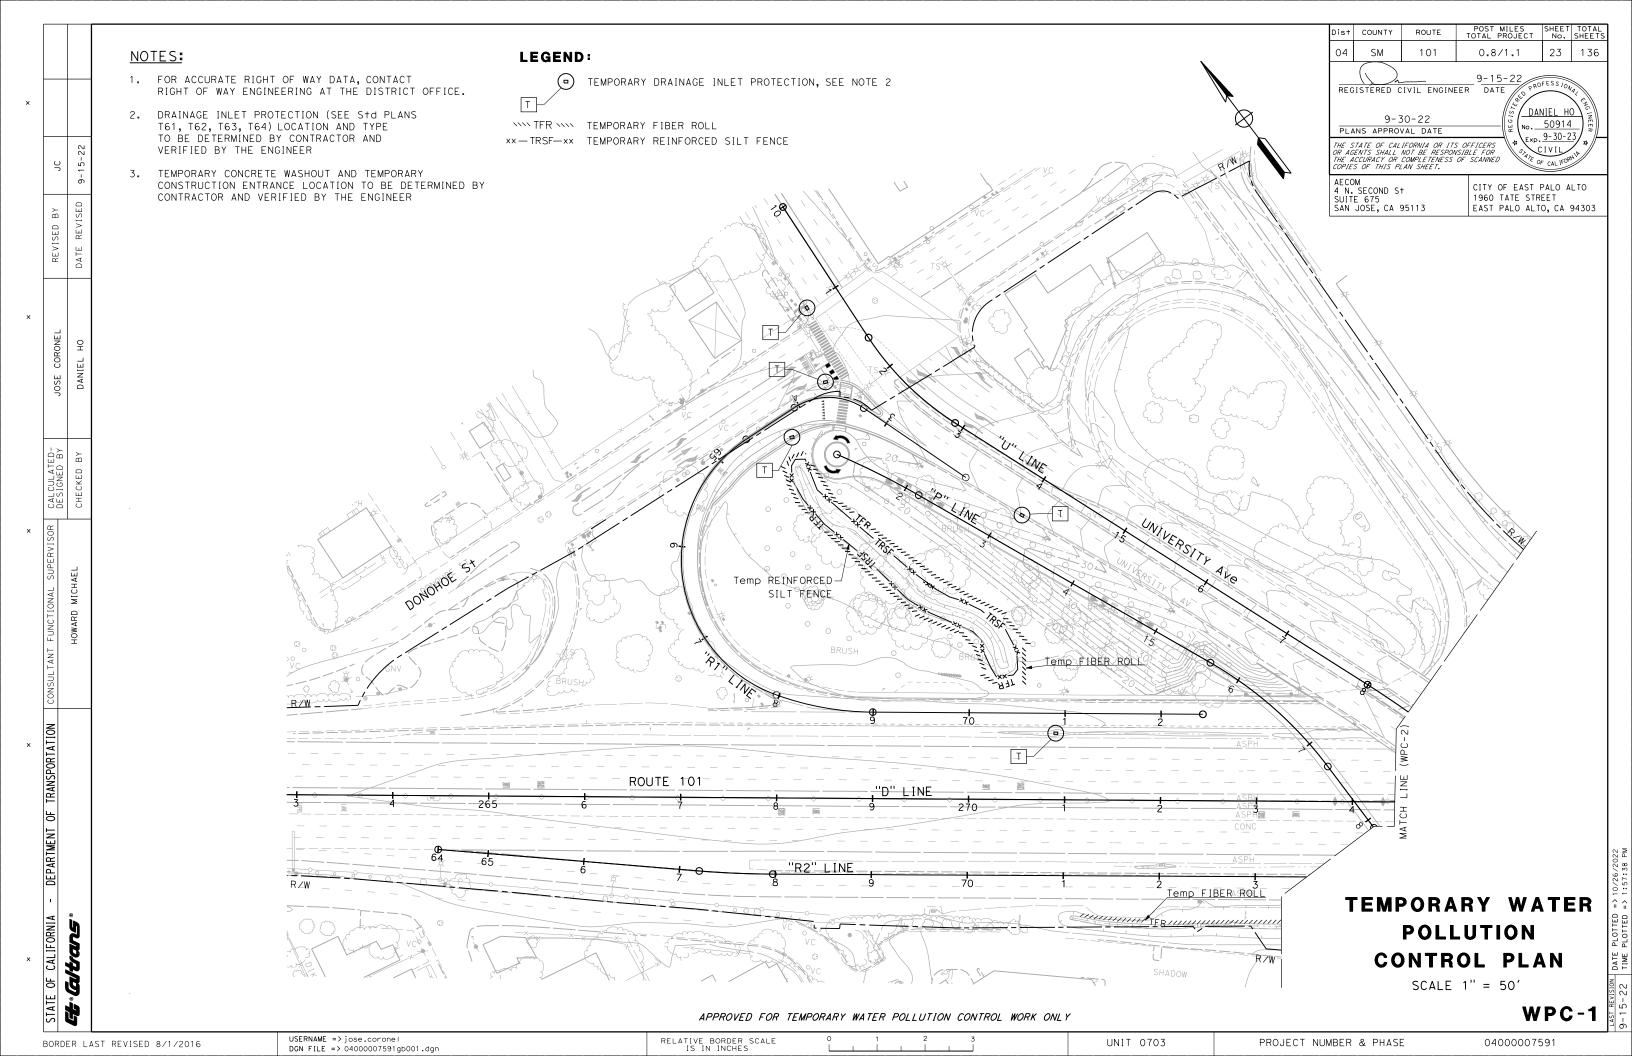

TEMPORARY WATER POLLUTION **CONTROL PLAN**

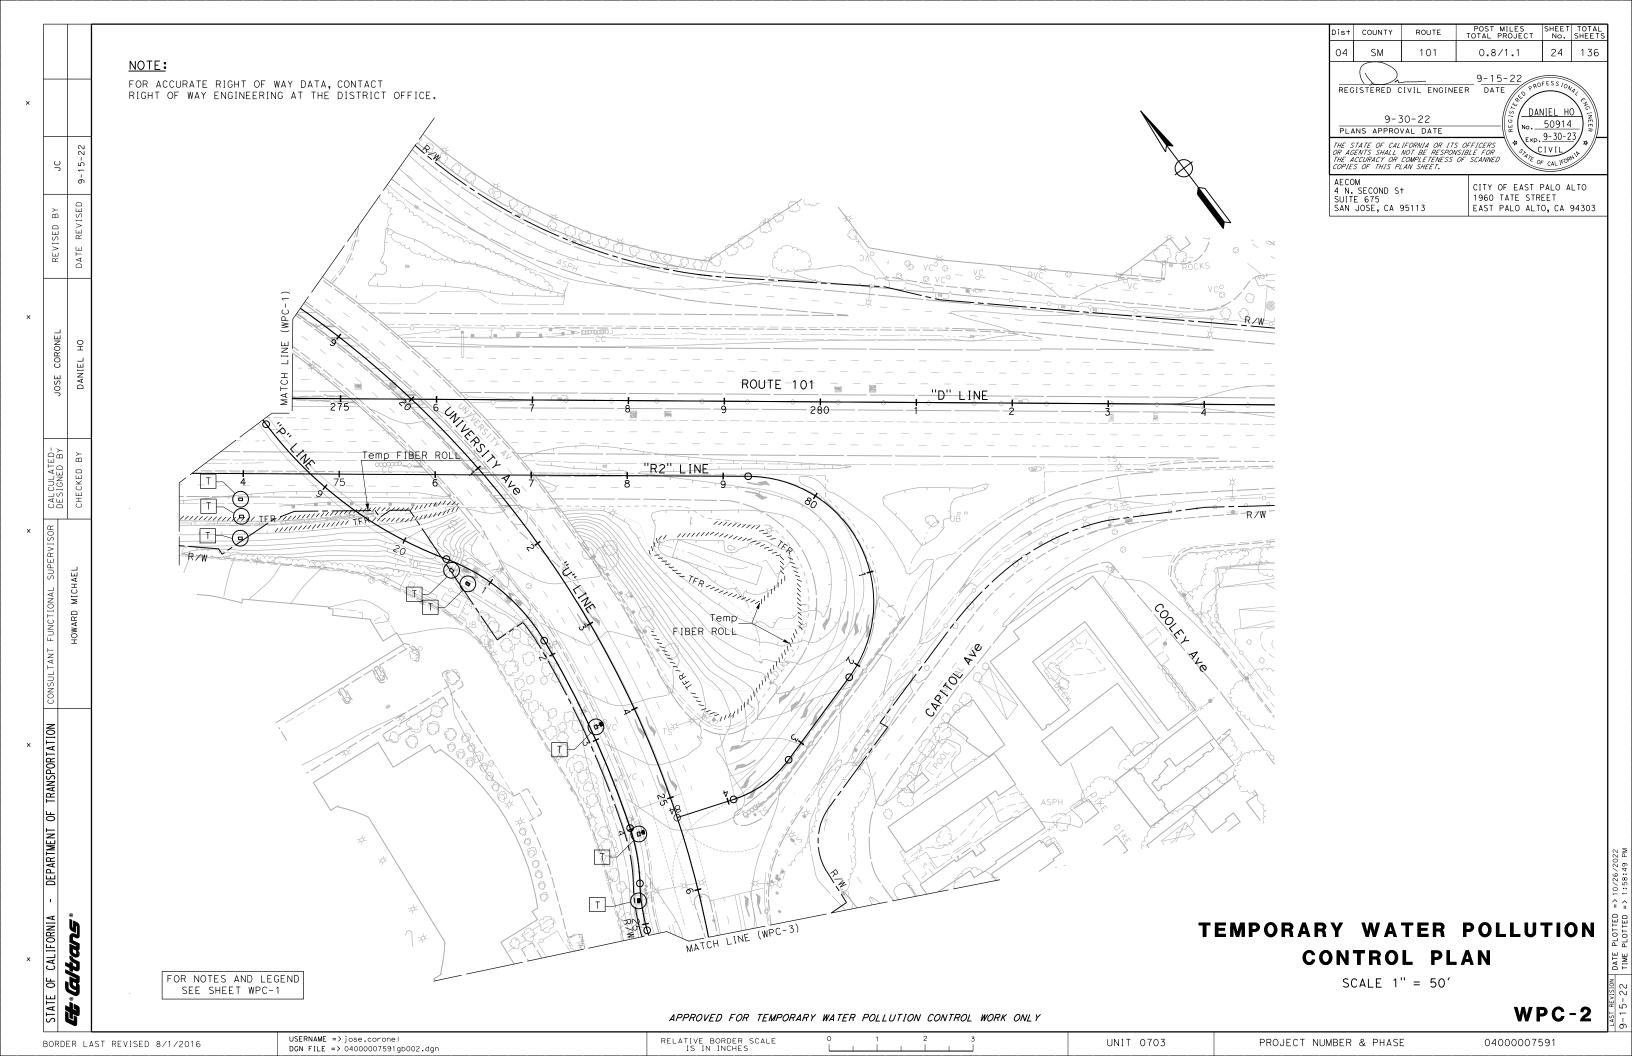SCALE 1" = 50'

WPC-3

APPROVED FOR TEMPORARY WATER POLLUTION CONTROL WORK ONLY

STATE OF CALIFORNIA altans

DEPARTMENT OF TRANSPORTATION | CONSULTANT

BORDER LAST REVISED 8/1/2016

USERNAME => jose.corone1 DGN FILE => 04000007591gb003.dgn

PROJECT NUMBER & PHASE

UNIT 0703

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CITY OF EAST PALO ALTO 1960 TATE STREET EAST PALO ALTO, CA 94303

POST MILES SHEET TOTAL TOTAL PROJECT No. SHEETS

DANIEL HO

ю.<u>50914</u>

Exp. 9-30-23

0.8/1.1

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FOR NOTES AND LEGEND SEE SHEET WPC-1

TE OF CALIFORNIA - DEPARTMENT OF TRANSPORTATION	CONSULTANT FUNCTIONAL SUPERVISOR	CALCULATED-	OSE COBONEL	REVISED BY	٢	
		DESIGNED BY	JOSE CONONEL))	
; <i>(ब/ťans</i> :	HOWARD MICHAEL	СНЕСКЕВ ВҮ	DANIEL HO	DATE REVISED 9-15-22	9-15-22	

Dist	COUNTY	ROUTE	POST MILES TOTAL PROJECT	SHEET No.	TOTAL SHEETS			
04 SM 101 0.8/1.1					136			
REGISTERED CIVIL ENGINEER 9-15-22 PLANS APPROVAL DATE THE STATE OF CALIFORNIA OR ITS OFFICERS OR AGENTS SHALL NOT BE RESPONSIBLE FOR THE ACCURACY OR COMPLETEESS OF SCANNED TOPIES OF THIS PLAN SHEFT.								
AECOM 4 N. SECOND S+ CITY OF EAST PALO ALTO								
SUIT	E 675 JOSE, CA S		1960 TATE STR EAST PALO ALT		94303			

TEMPORARY WATER POLLUTION **CONTORL QUANTITIES**

SHEET No.	TEMPORARY T FIBER ROLL	TEMPORARY TREINFORCED SILT FENCE	TEMPORARY CONSTRUCTION ENTRANCE	TEMPORARY DRAINAGE INLET PROTECTION	TEMPORARY CONCRETE WASHOUT
WPC-1	730	705	1	5	2
WPC-2	1242		1	8	2
WPC-3			1	3	1
TOTAL	1972	705	3	16	5


TEMPORARY WATER POLLUTION **CONTROL QUANTITIES**


WPCQ-1

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UNIT 0703


PROJECT NUMBER & PHASE



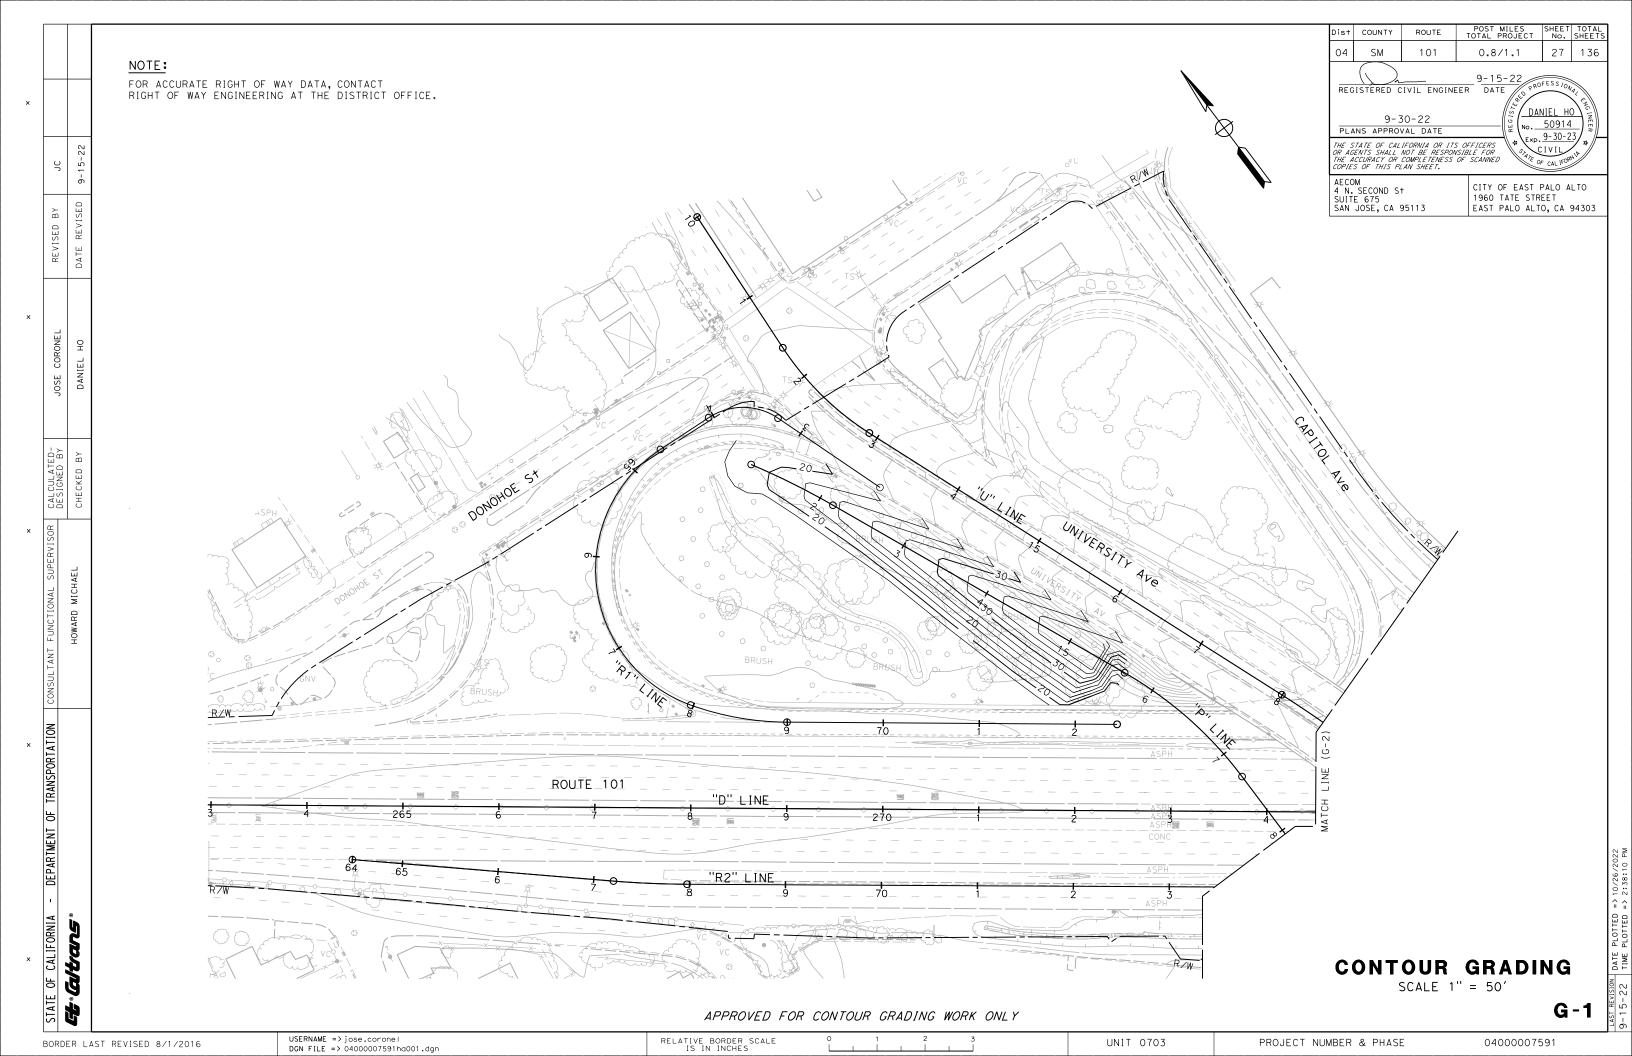

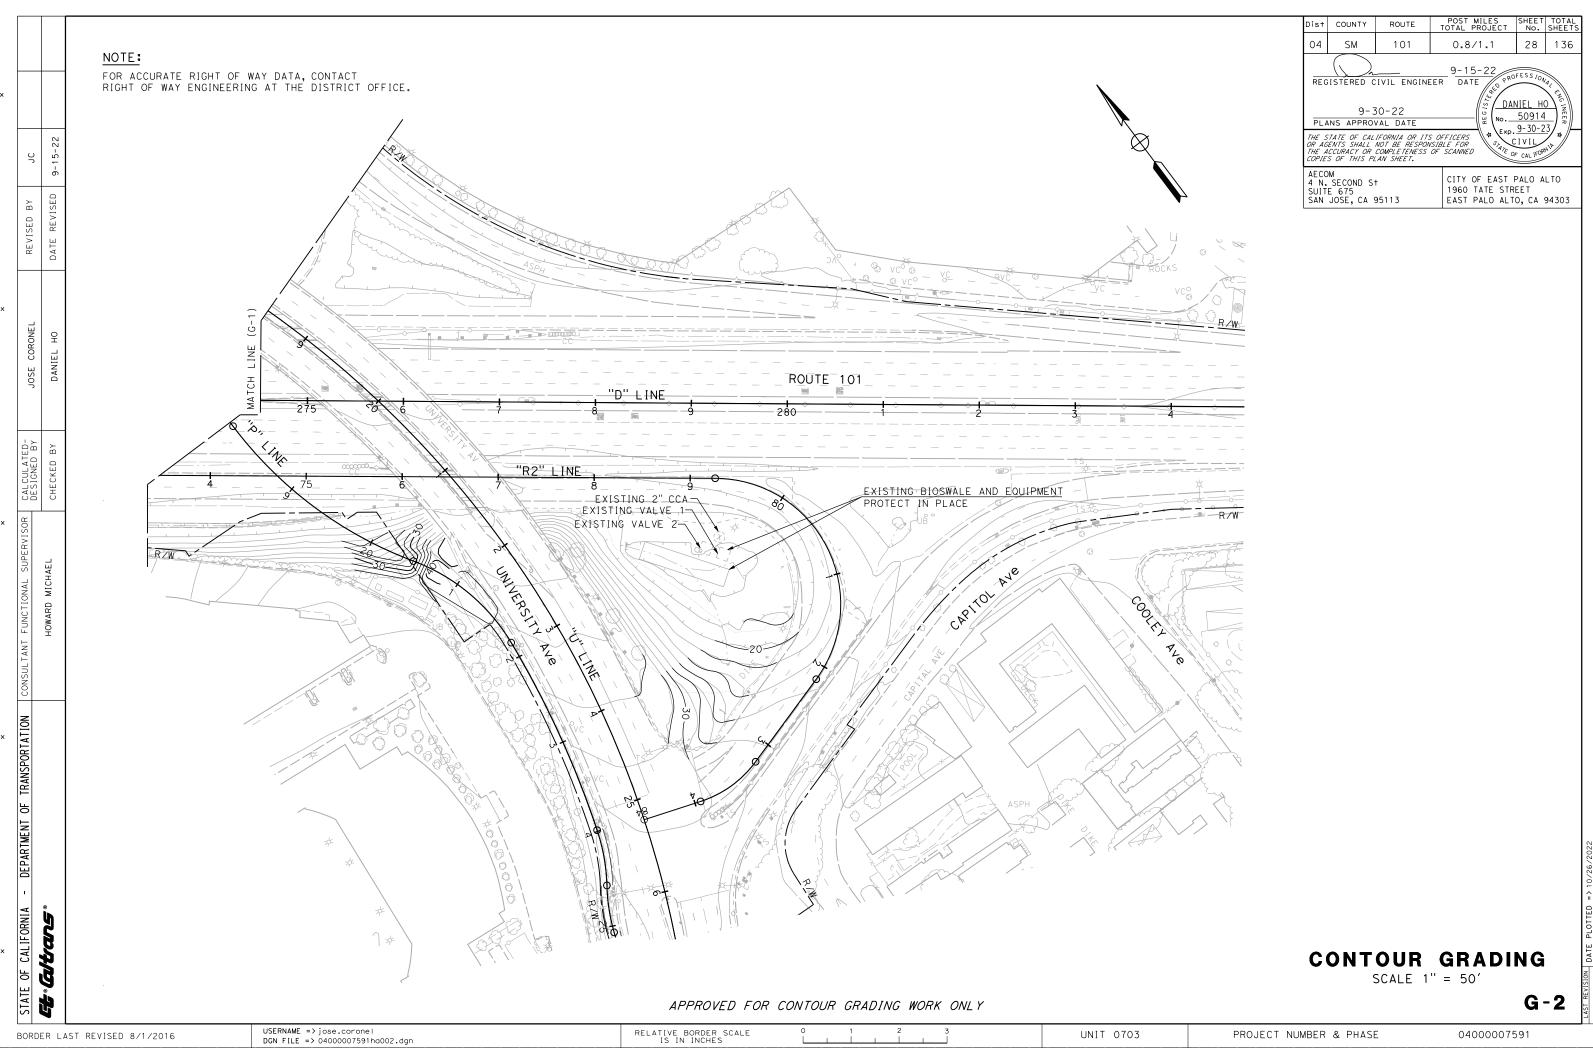
UNIT 0703

PROJECT NUMBER & PHASE

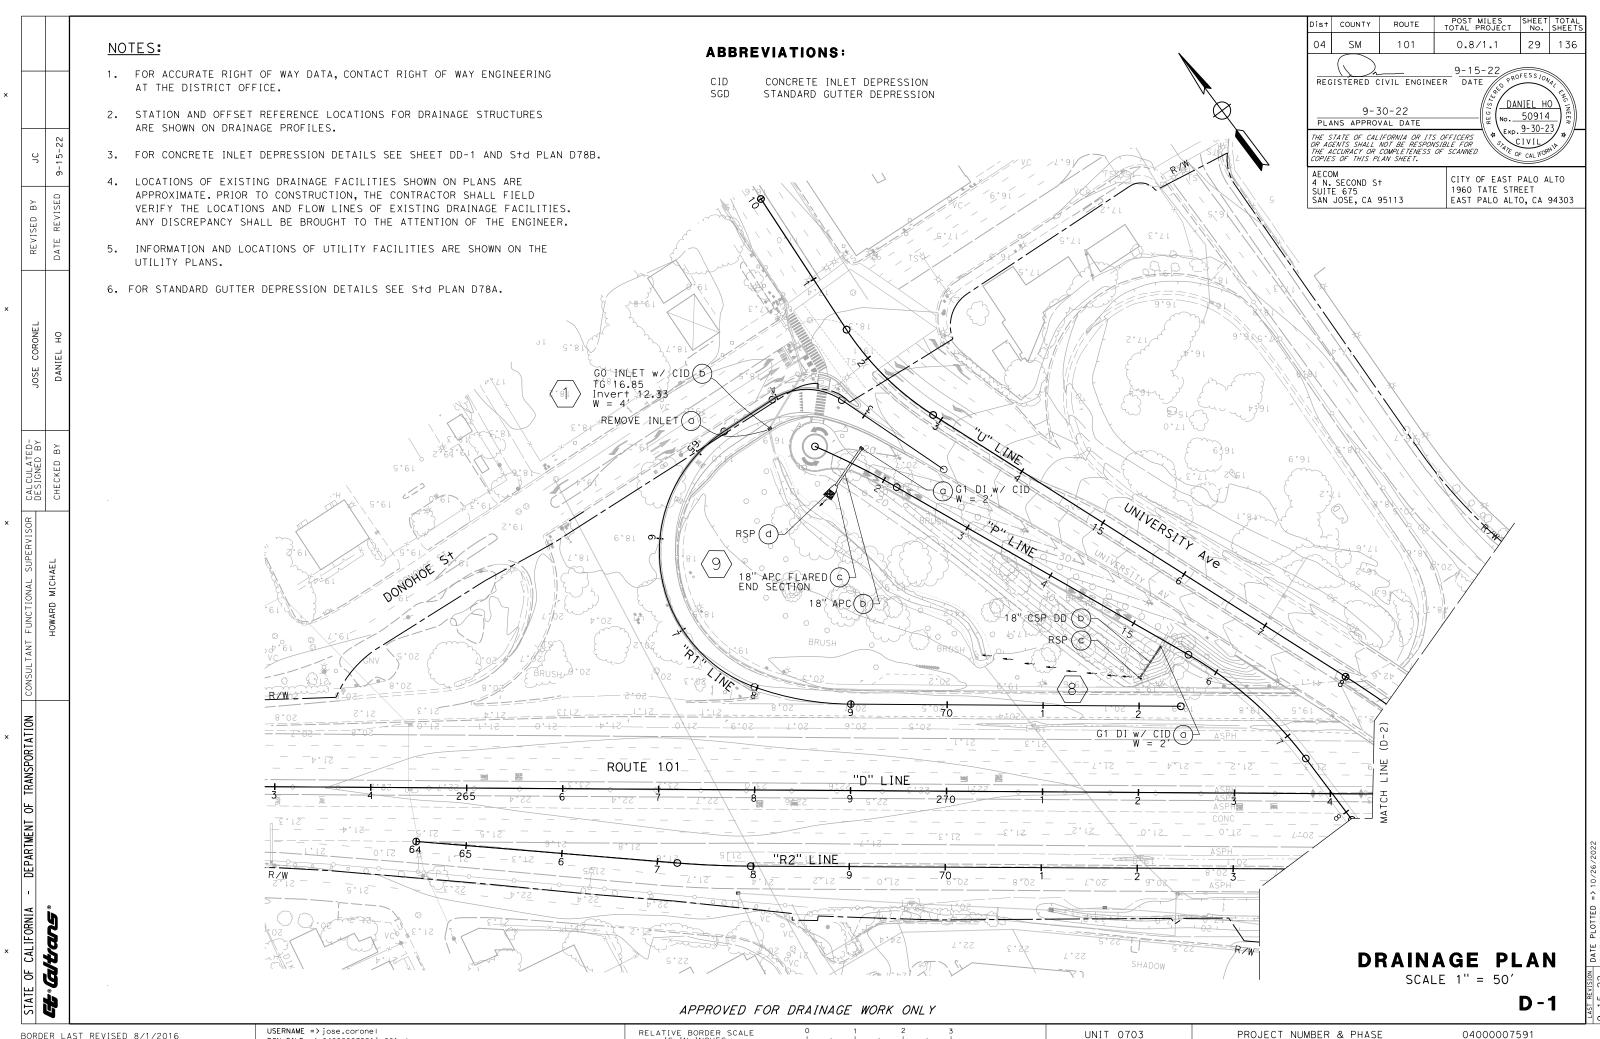

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RELATIVE BORDER SCALE IS IN INCHES

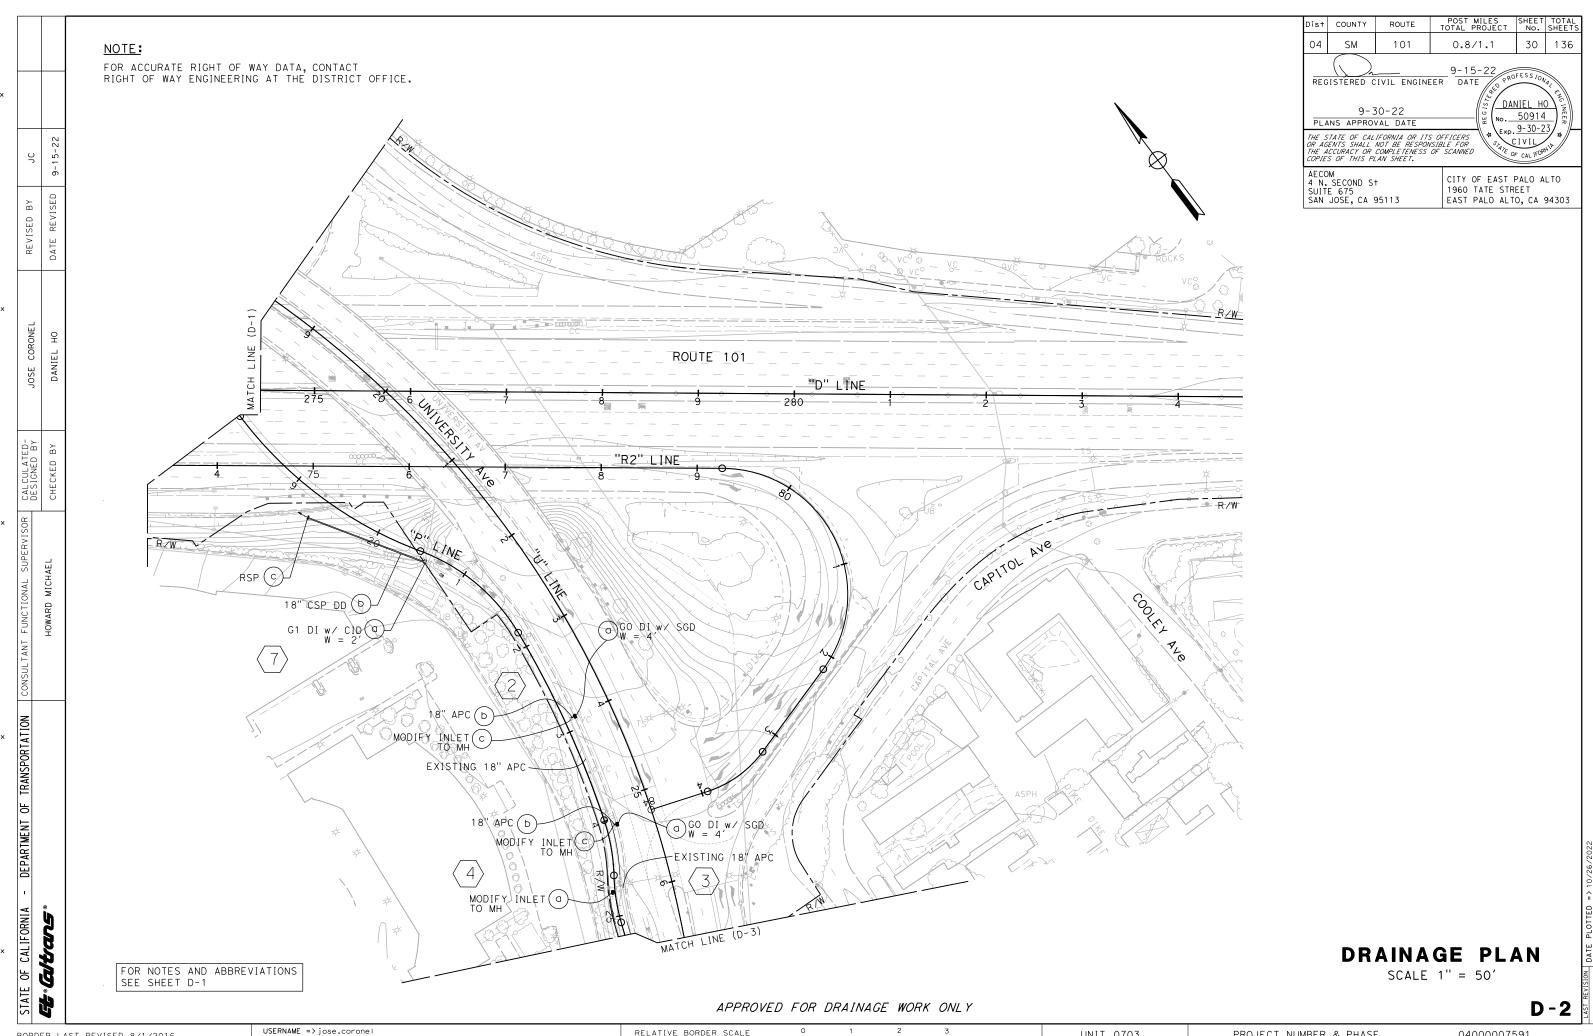

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RELATIVE BORDER SCALE IS IN INCHES


UNIT 0703

PROJECT NUMBER & PHASE

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FOR ACCURATE RIGHT OF WAY DATA, CONTACT RIGHT OF WAY ENGINEERING AT THE DISTRICT OFFICE.

POST MILES SHEET TOTAL TOTAL PROJECT No. SHEETS Dist COUNTY 31 04 136 SM 101 0.8/1.1 REGISTERED CIVIL ENGINEER 9-15-22
DATE DANIEL HO 9-30-22 ю.<u>50914</u> PLANS APPROVAL DATE Exp. 9-30-23 THE STATE OF CALIFORNIA OR ITS OFFICERS
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DRAINAGE PLAN

SCALE 1" = 50'

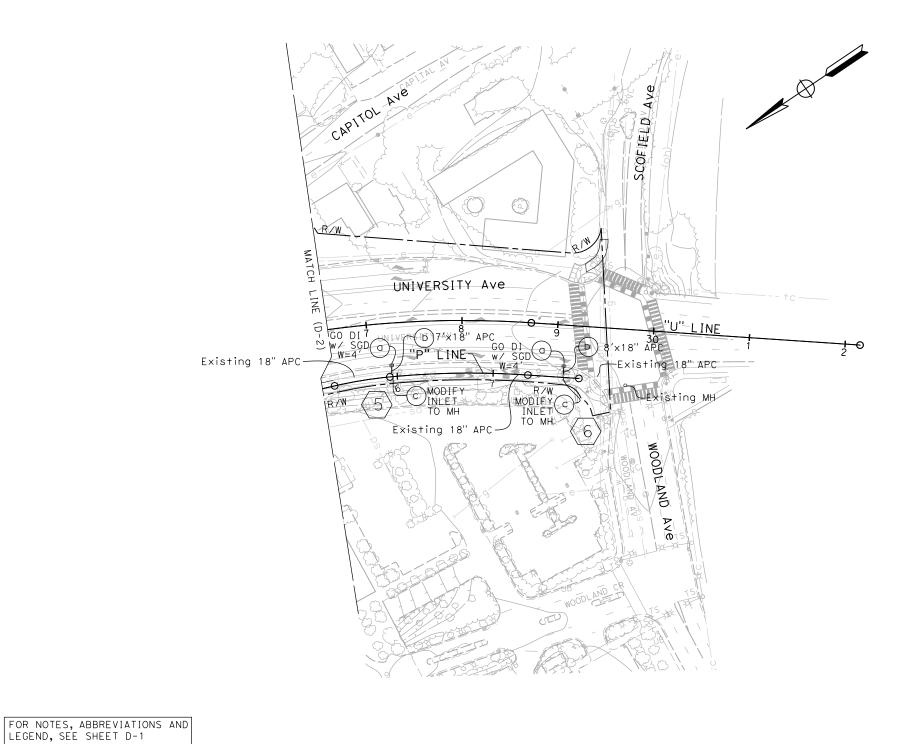
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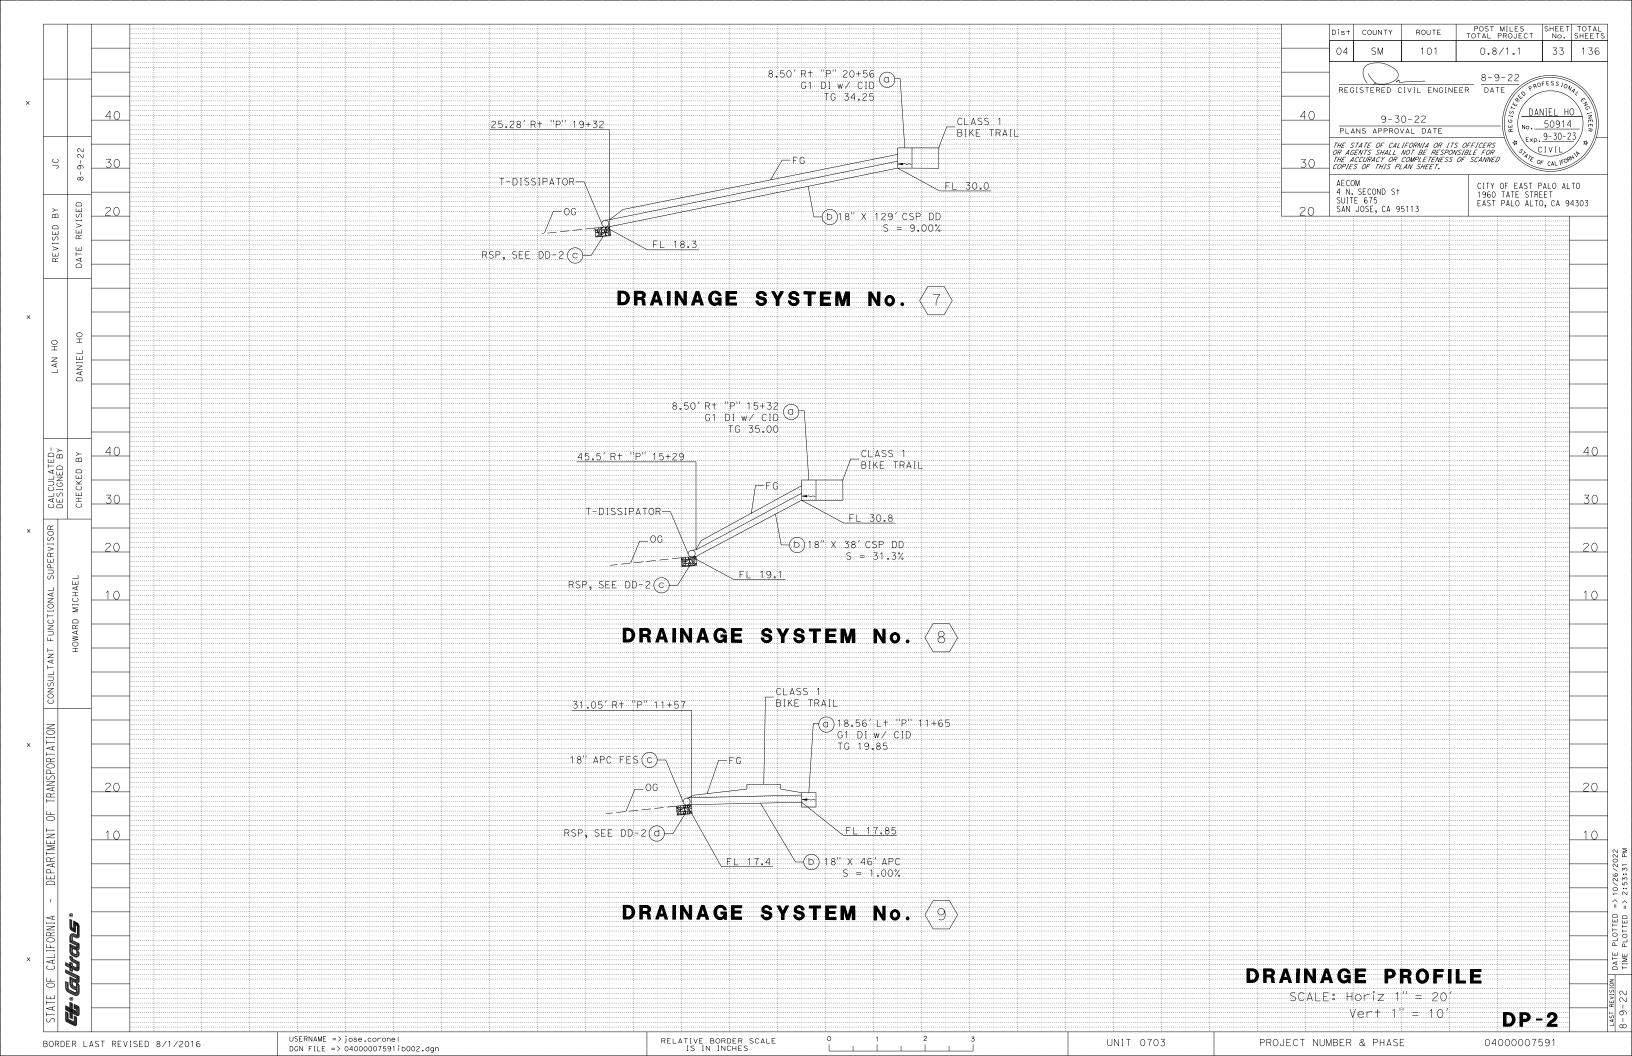
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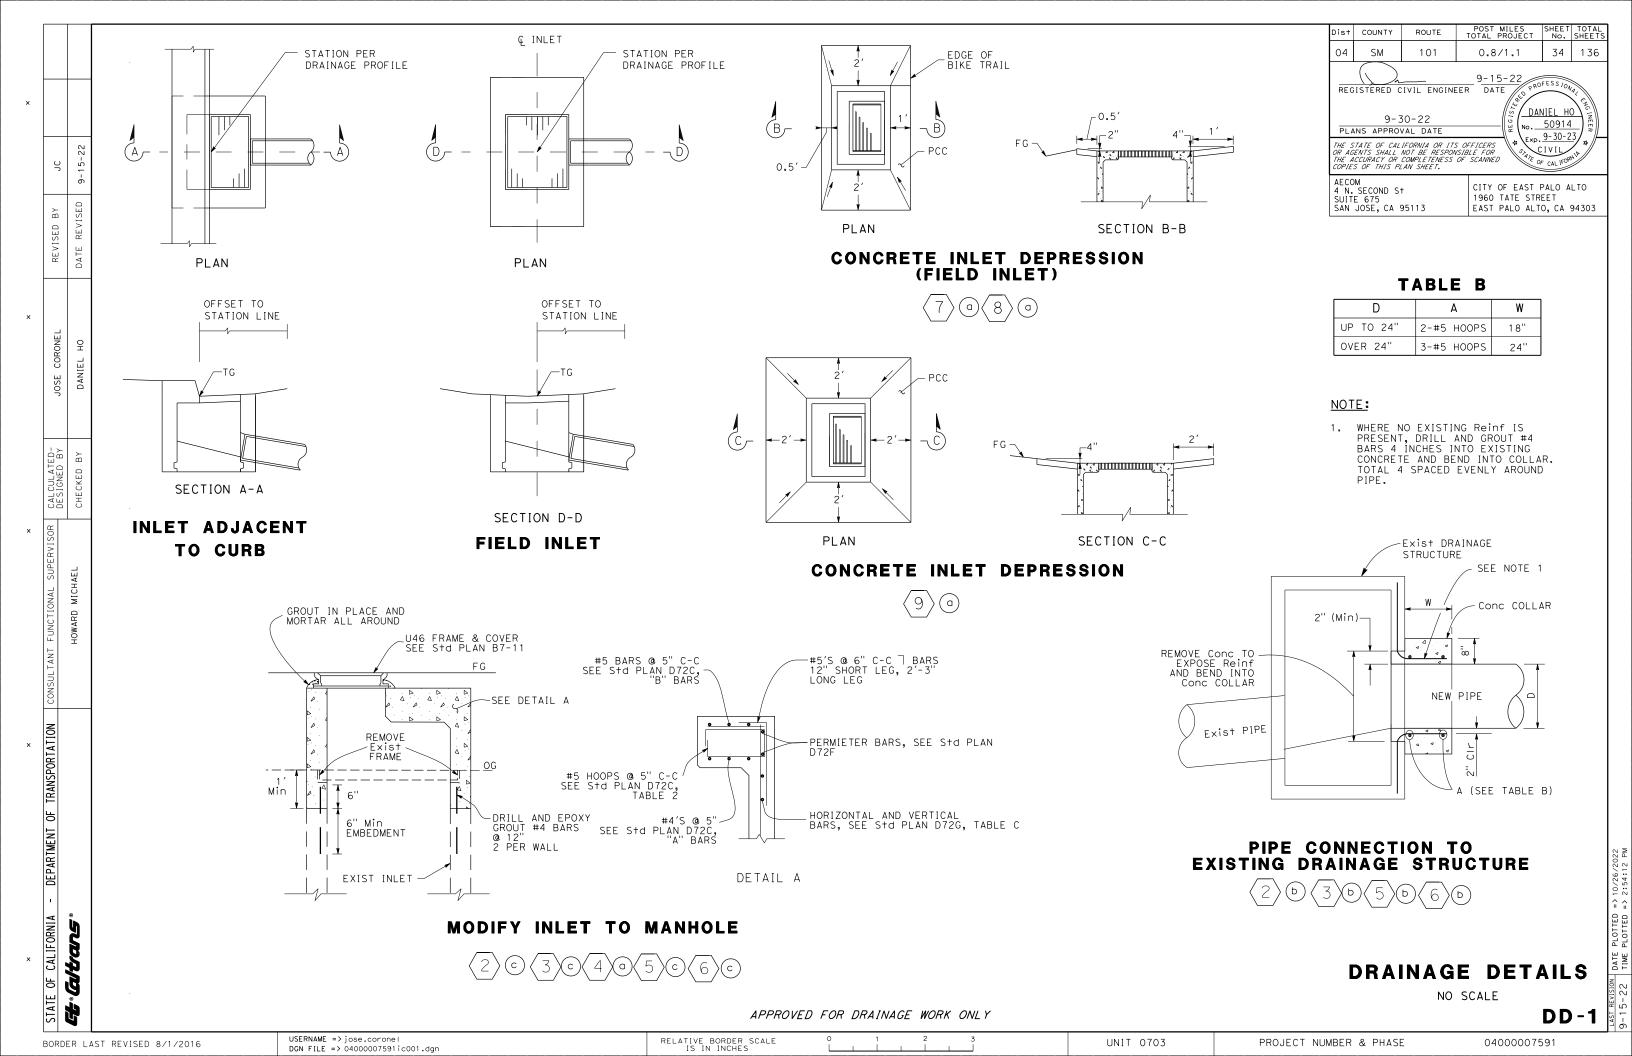
UNIT 0703 PROJECT NUMBER & PHASE


BORDER LAST REVISED 8/1/2016

USERNAME => jose.corone| DGN FILE => 04000007591ia003.dgn RELATIVE BORDER SCALE IS IN INCHES





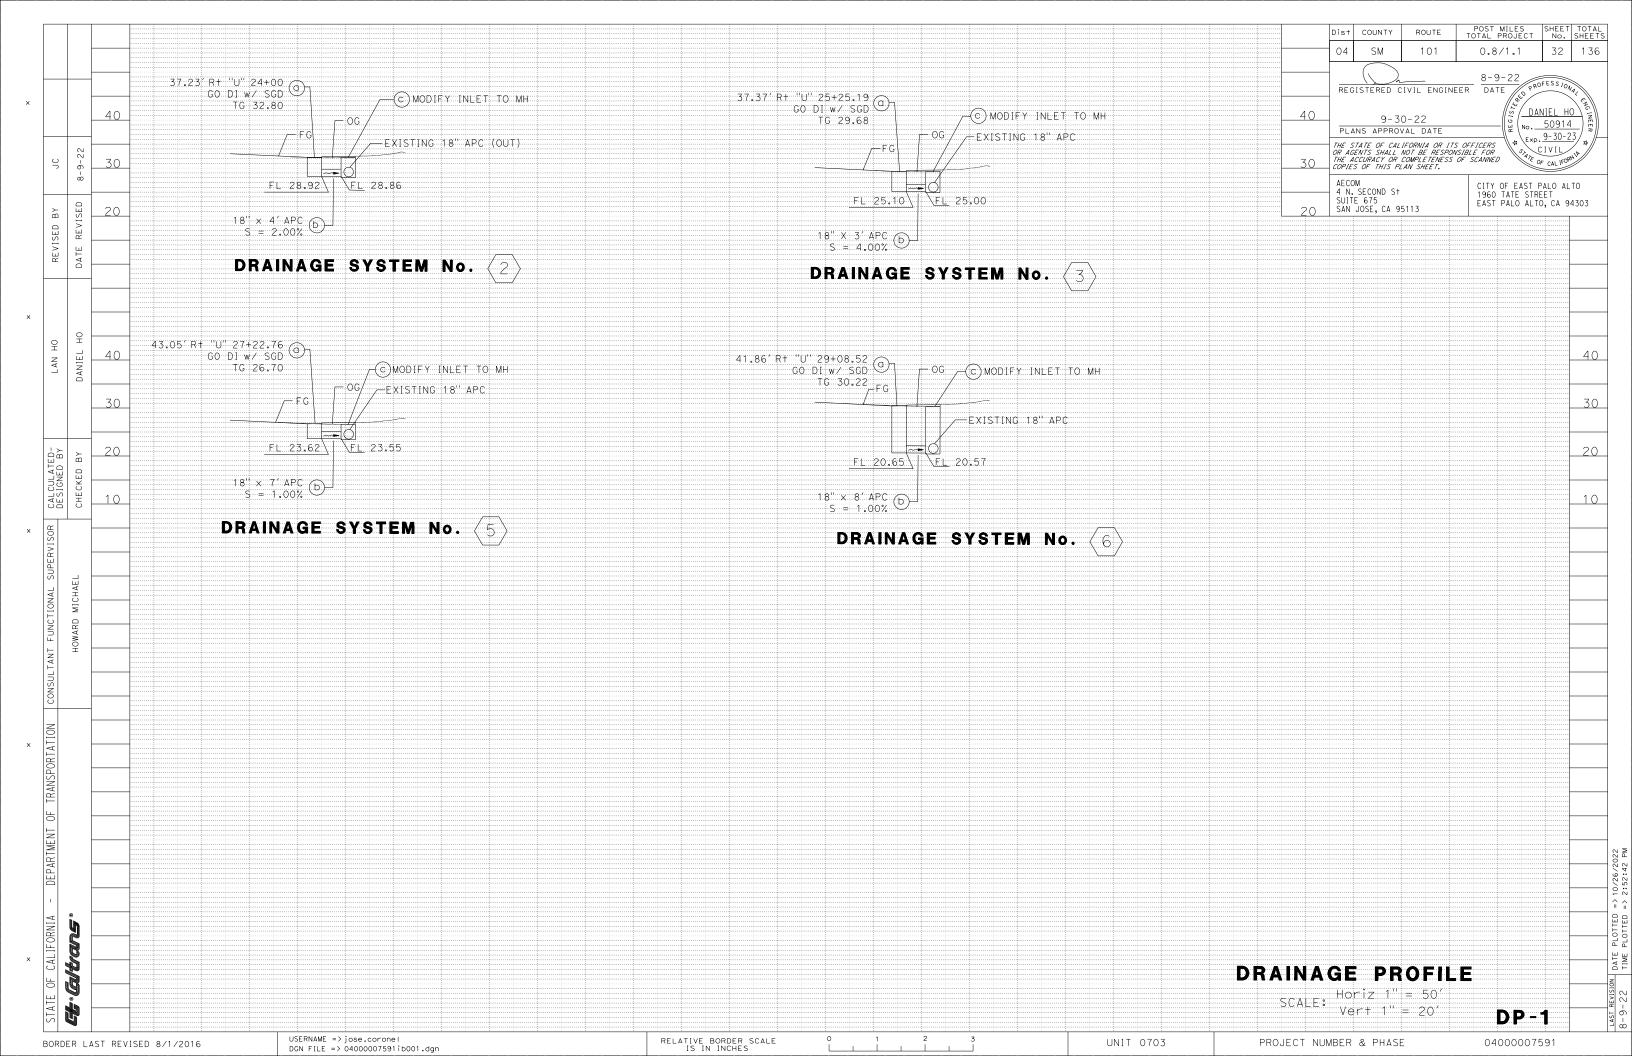

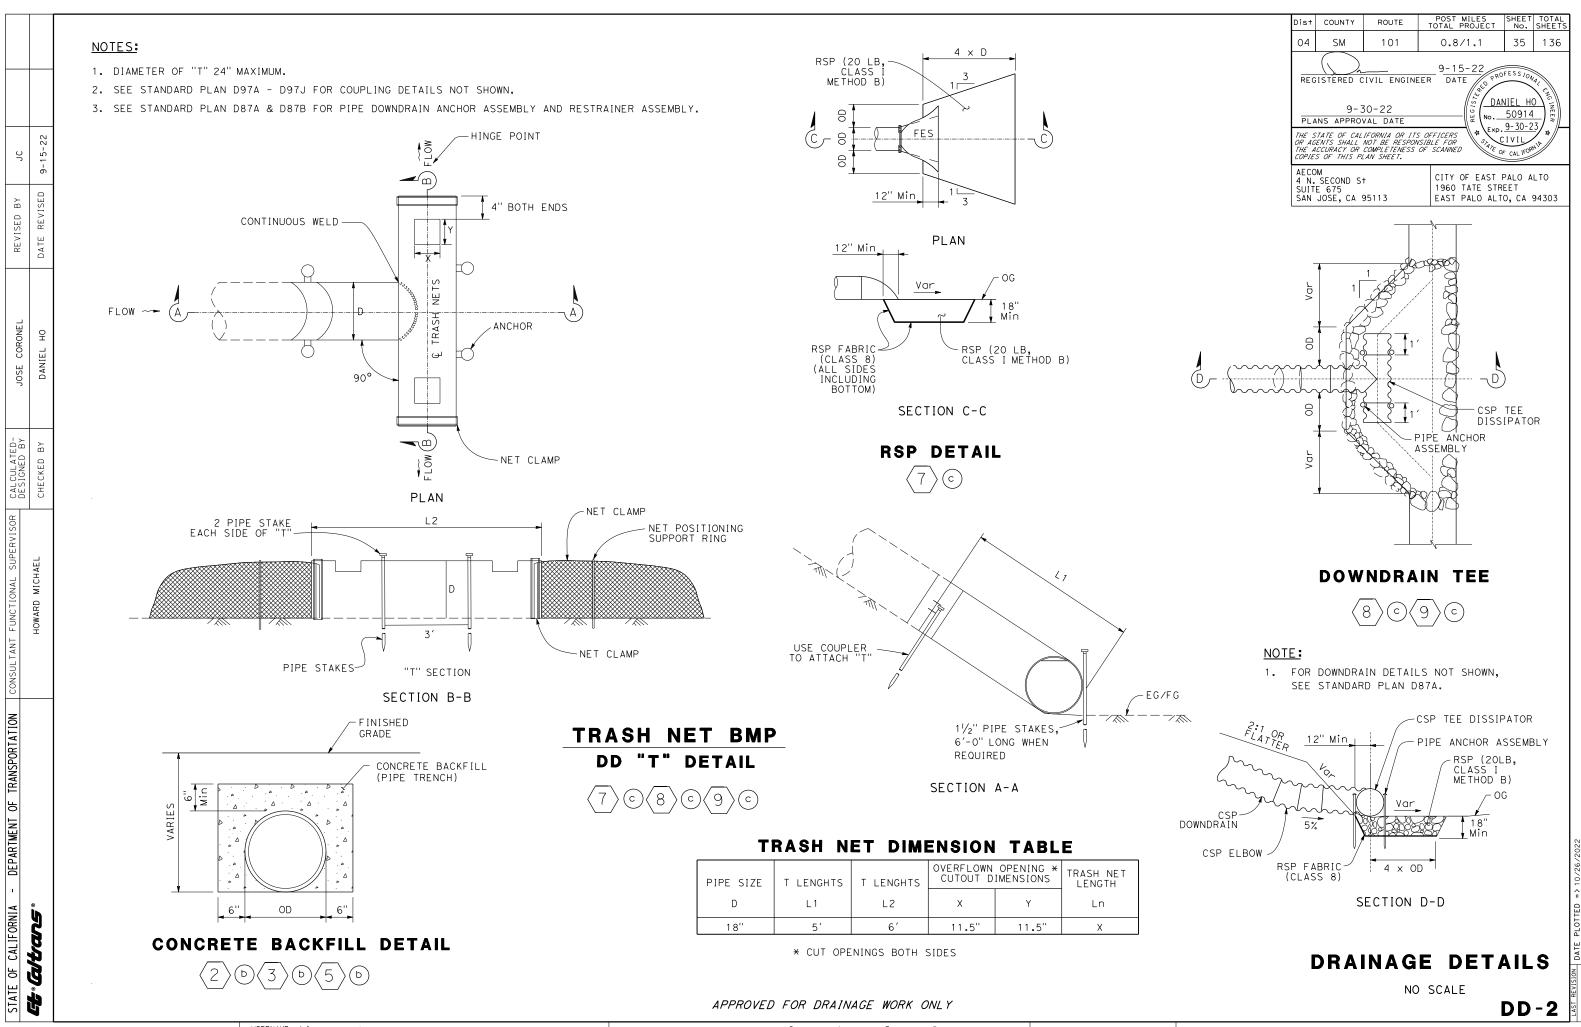

USERNAME => jose.corone! DGN FILE => 04000007591ic002.dgn

04000007591

RELATIVE BORDER SCALE IS IN INCHES UNIT 0703 PROJECT NUMBER & PHASE

WATERTIGHT JOINT

Dist	COUNTY	ROUTE	POST MILES TOTAL PROJECT	SHEET No.	TOTAL SHEET							
04	SM	101	0.8/1.1	36	136							
REG	TOTAL PROJECT No. SHEET											

DANIEL HO
No. 50914
Exp. 9-30-23
CIVIL 9-30-22 THE STATE OF CALIFORNIA OR ITS OFFICERS OR AGENTS SHALL NOT BE RESPONSIBLE FOR THE ACCURACY OR COMPLETENESS OF SCANNED COPIES OF THIS PLAN SHEET.

PLANS APPROVAL DATE

AECOM 4 N. SECOND S+ SUITE 675 SAN JOSE, CA 95113

CITY OF EAST PALO ALTO 1960 TATE STREET EAST PALO ALTO, CA 94303

APC ALLOWABLE PIPE MATERIAL AND PROTECTION

		CSP	HDPE PIPE	PVC			
DESIGNATION	RCP	(0.109" THICK) BITUMINOUS COATING AND PAVED INVER+		CORRUGATED w/SMOOTH INTERIOR			
18" APC	YES	YES	YES	YES			

DRAINAGE QUANTITIES

DRAINAGE PLAN SHEET NO.	DRAINAGE L	NAGE INL		റ MINOR CONCRETE ≺ (GUTTER DEPRESSION)	(N)FRAME GRATE E A	교 MAXIMUM HEIGHT OF COVER (N)	다 HEIGHT OF INLET/MANHOLE (N)	ALTERNATIVE PIPE CULVERT	ALTERNATIVE FLARED END SECTION	다 18" CORRUGATED STEEL 다 PIPE DOWNDRAIN	REM	MODIFY INLET TO MH	STRUCTURAL CONCRETE, MINOR STRUCTURE	MISCELLANEOUS IRON AND STEEL	CSP TEE DISSIPATOR	⊋ RSP (20LB, CLASS I METHOD B)	TRASH NET (N)	T LENGTH OF NET (N)	WT JOINT (N)	DESCRIPTION	STATION	DRAINAGE PLAN SHEET No.	DRAINAGE SYSTEM No.	DRAINAGE UNIT
	а										1									REMOVE INLET	22.44′R+ "R1" LINE 64+24.93		1	а
	b	1	1	1	1		4.9							239						GO DI w/CID	22.44'Rt "R1" LINE 64+24.93 TG = 16.85', Invert FL = 12.33'			Ь
	а	1	1	1	1		4.0						2.56	239						G1 DI w/CID	8.50'R+ "P" LINE 15+32			а
8	Ь					2.5				38										18" CSP	8.50' TO 45.5' R+ "P" LINE 15+29		8	b
D-1	С														1	0.75	1	4	1	RSP	28.65'L+ "R1" LINE 72+00	D-1		С
	а	1	1	1	1								2.56	239						G1 DI w/CID	66'R+ "U" LINE 12+54			а
	Ь							46												18" APC	73.2'R+ "U" LINE 12+54 TO 119'R+ "U" LINE 12+57		9	b
	С								1										FL	_ARED END SECTION	119' "U" LINE 12+57		•	С
	d														1	1.50	1	8		RSP	126.23′ "U" LINE 12+57			d
	а	1	1	1	1		4.0						2.56	239						GO DI w/SGD	37.23' R+ "U" LINE 24+00			а
	ь					2.5		4												18" APC	37.23' to 41.23' Rt "U" LINE 24+00		2	b
	С											1							M	DDIFY INLET TO MH	41.23' R† "U" LINE 24+00			С
	а	1	1	1	1		4.2						2.69	239						GO DI w/SGD	37.37'R+ "U" LINE 25+25.19	\Box		а
D-2 3	b					2.7		3												18" APC	37.37' to 40.37' Rt "U" LINE 25+25.19	D-2	3	b
	С											1								ODIFY INLET TO MH	40.37′ R+ "U" LINE 25+25.19			С
												1	L						M	ODIFY INLET TO MH	61.50' R+ "U" LINE 25+95.58		4	а
_	а	1	1	1	1		4.0						2.56	239						G1 DI w/CID	8.50' R+ "P" LINE 20+56			а
	Ь					2.5				129									1	18" CSP	8.50′ TO 25.28′ R+ "P" LINE 20+56		7	b
	С														1	0.75	1	4		RSP	132.06′ R+ "D" LINE 274+94			С
	а	1	1	1	1		3.2						2.05	239						GO DI w/SGD	43.05′ R+ "U" LINE 27+22.76		_	a
5	⊢					1.7		7												18" APC	43.05′ to 50.05′ Rt "U" LINE 27+22.76		5	b
D-3	С			_			0.0					1	6 75	070					M	ODIFY INLET TO MH	50.05' R+ "U" LINE 27+22.76	− р-з	_	С
	<u>a</u>	1 1	1	1	1		9.9	8					6.35	239						GO DI w/SGD	41.86′ R† "U" LINE 29+08.52	- T		b
'	<u> </u>	+	-+			8.4						1		-						18" APC	41.86' to 48.86' Rt "U" LINE 29+08.52 48.86' Rt "U" LINE 29+08.52		6	C
T.	<u> </u>	8	0	8	9			68	1	167	1	5	25 4	1912	7	7			I IMC	ODIFY INLET TO MH	40.00 KI U LINE 29TU0.32			


(N) - NOT A SEPARATE BID ITEM.


DRAINAGE QUANTITIES

REVISED

- DEPARTMENT OF TRANSPORTATION | CONSULTANT FUNCTIONAL


STATE OF CALIFORNIA

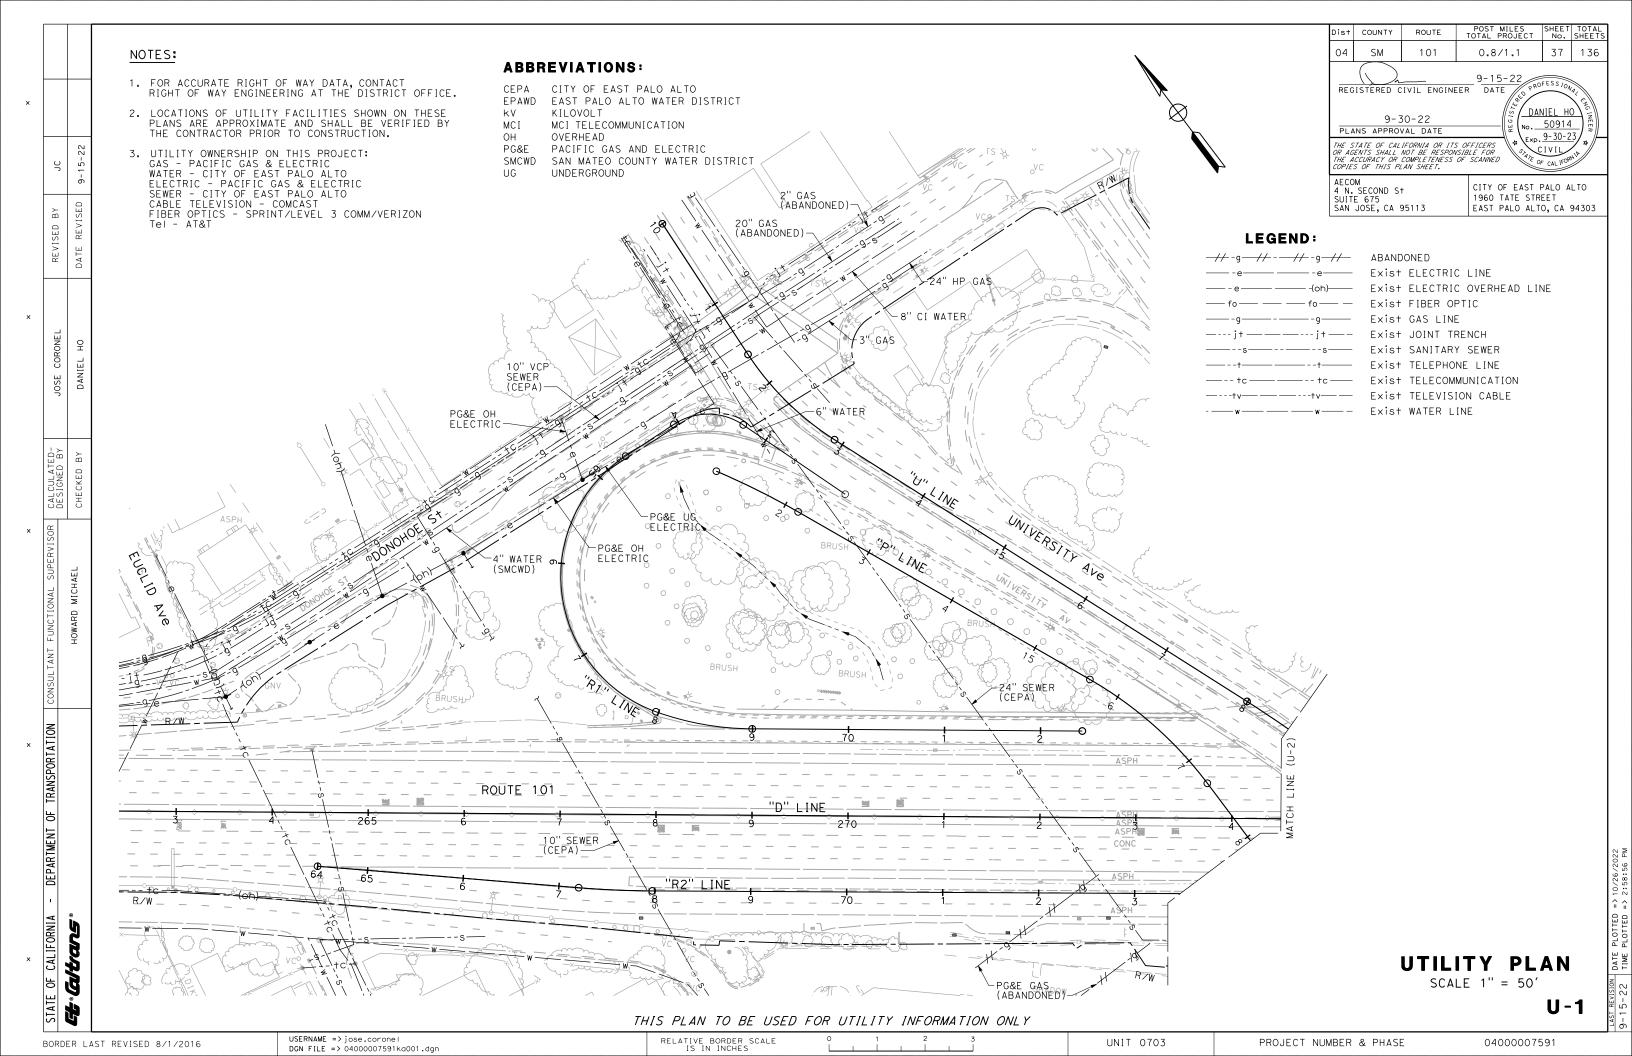

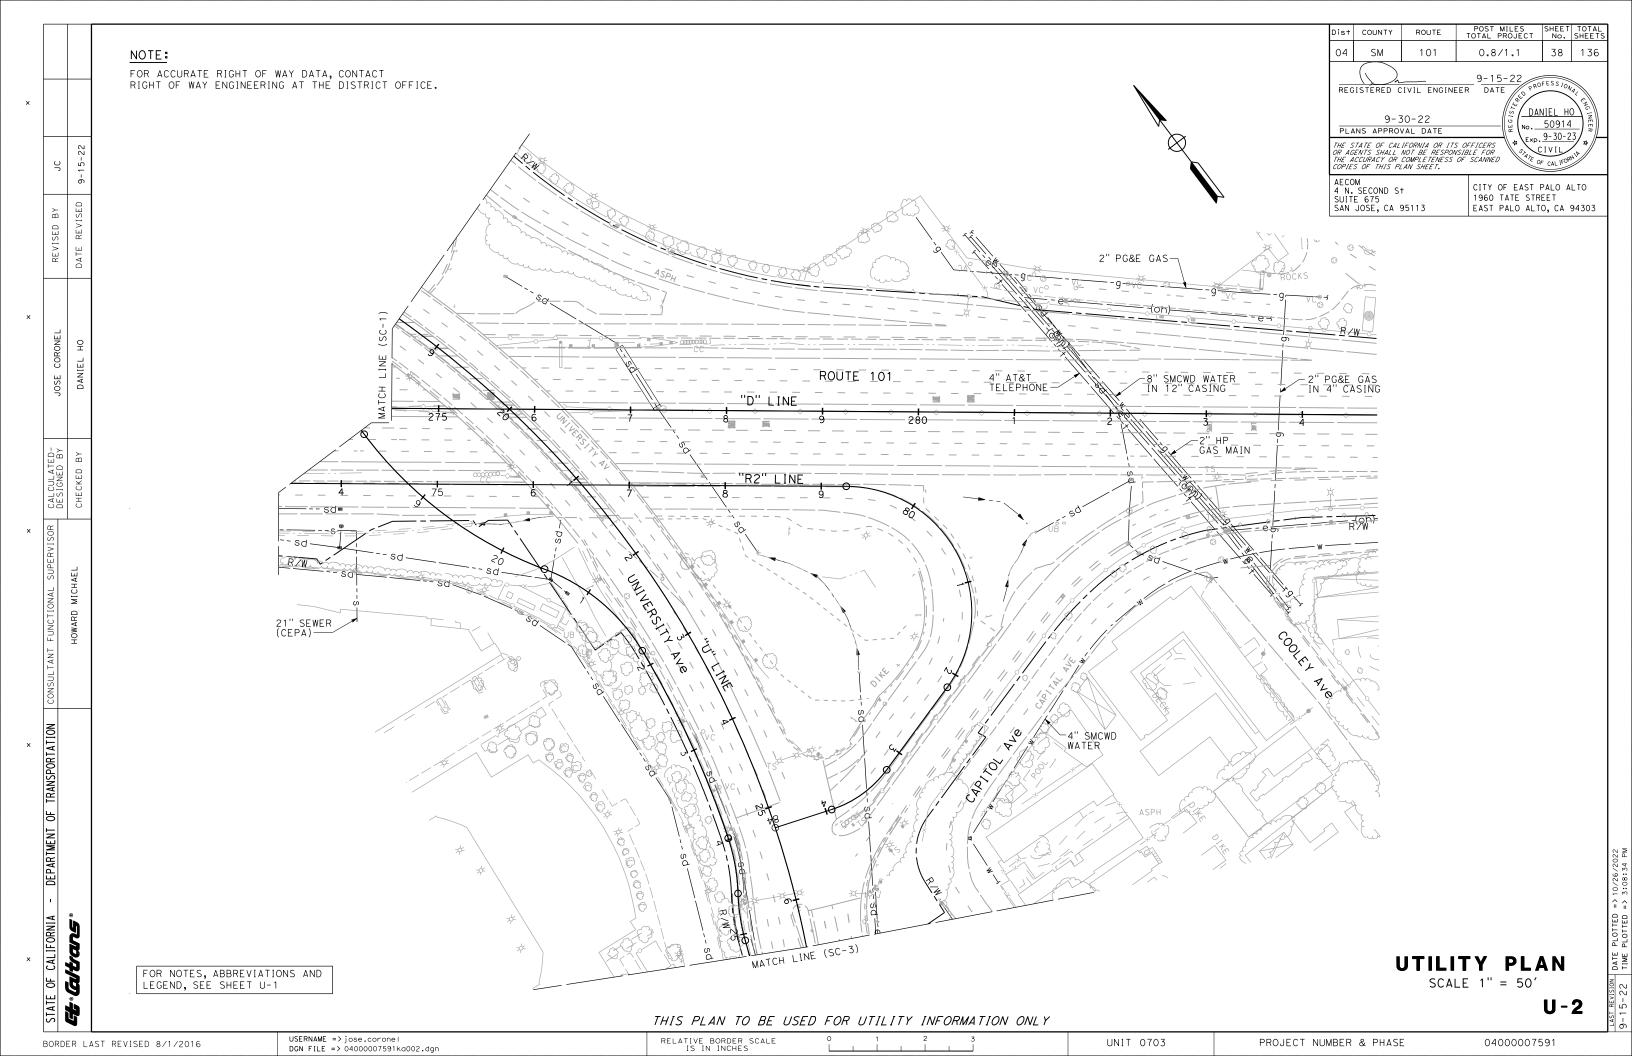

FOR ACCURATE RIGHT OF WAY DATA, CONTACT RIGHT OF WAY ENGINEERING AT THE DISTRICT OFFICE.

POST MILES SHEET TOTAL TOTAL PROJECT No. SHEETS Dist COUNTY 39 136 04 SM 101 0.8/1.1 REGISTERED CIVIL ENGINEER DATE DANIEL HO 9-30-22 ю. 50914 PLANS APPROVAL DATE Exp. 9-30-23 THE STATE OF CALIFORNIA OR ITS OFFICERS
OR AGENTS SHALL NOT BE RESPONSIBLE FOR
THE ACCURACY OR COMPLETENESS OF SCANNED
COPIES OF THIS PLAN SHEET. AECOM 4 N. SECOND S† SUITE 675 SAN JOSE, CA 95113 CITY OF EAST PALO ALTO 1960 TATE STREET EAST PALO ALTO, CA 94303

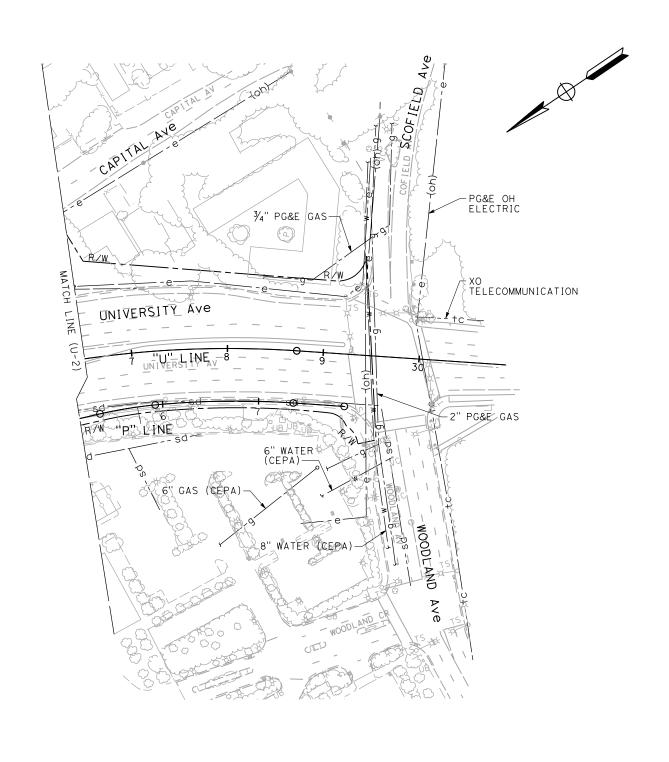

FOR NOTES, ABBREVIATIONS AND LEGEND, SEE SHEET U-1

UTILITY PLAN

SCALE 1'' = 50'

U-3


THIS PLAN TO BE USED FOR UTILITY INFORMATION ONLY

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DGN FILE => 04000007591ka003.dgn

RELATIVE BORDER SCALE IS IN INCHES

UNIT 0703

PROJECT NUMBER & PHASE

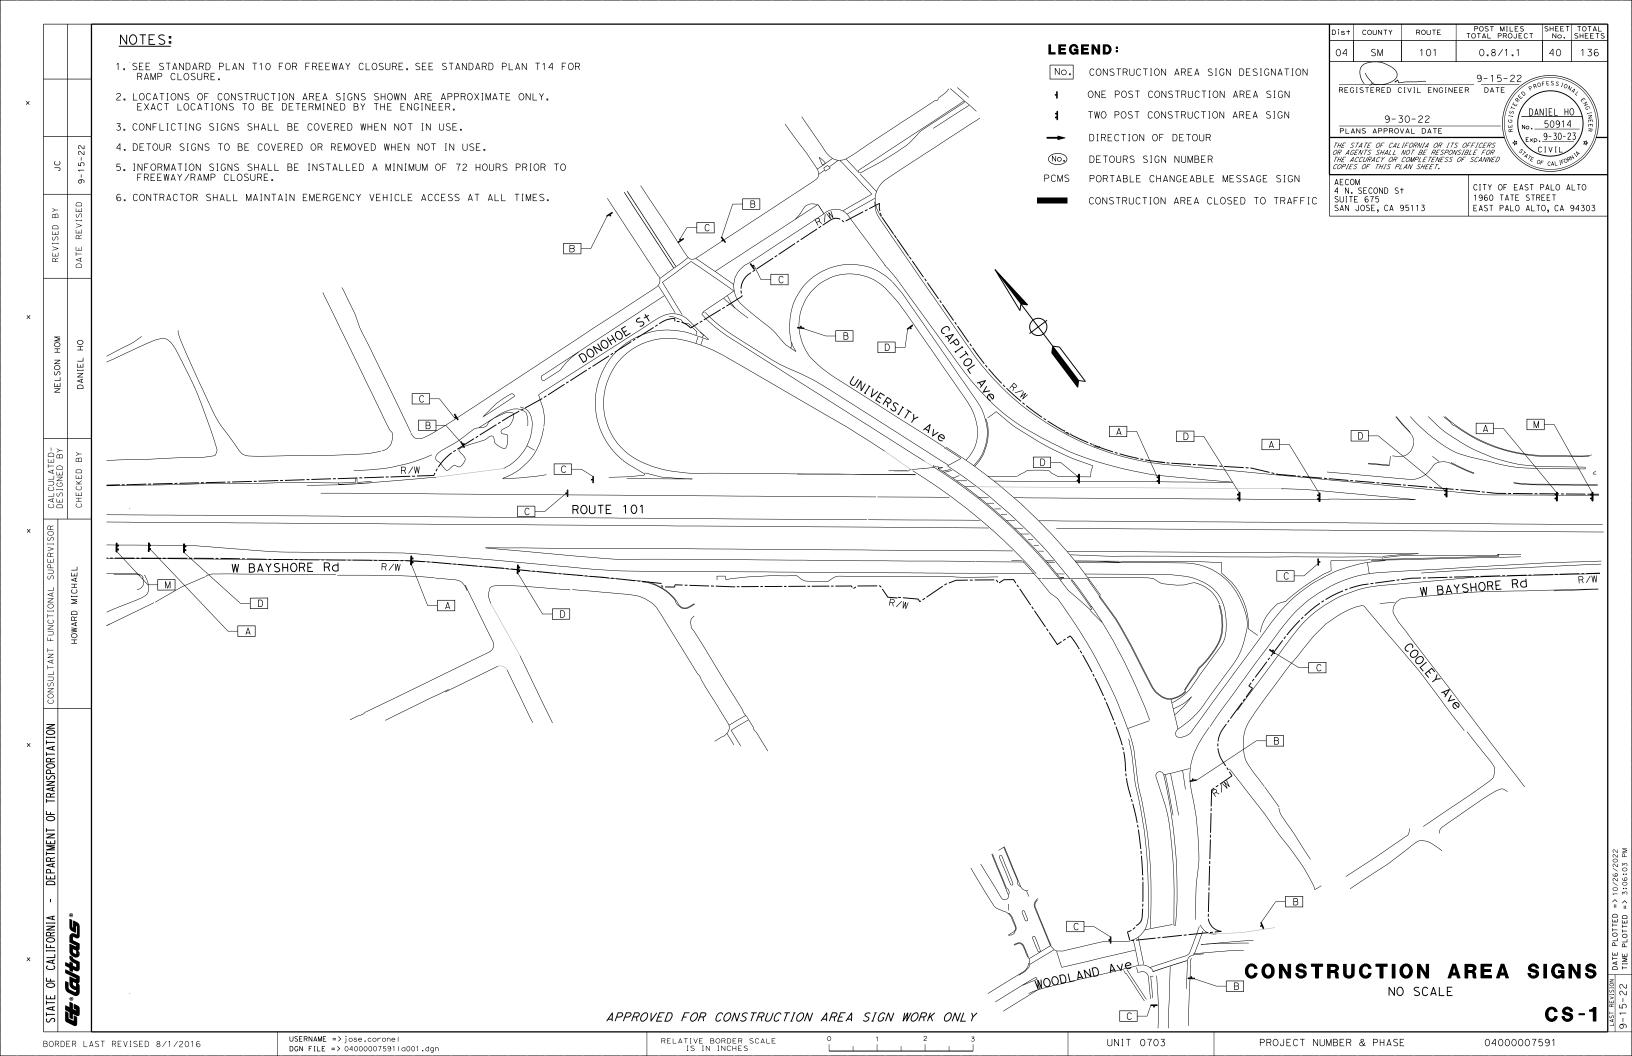


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			04 SM 101 0.8/1.1 41 136
			9-15-22
			REGISTERED CIVIL ENGINEER DATE OF PROFESS 10 NATE
			DANIEL HO
			9-30-22 PLANS APPROVAL DATE WE SELECT STATE OF THE SELECT STATE
	-22		THE STATE OF CALIFORNIA OR ITS OFFICERS OR AGENTS SHALL NOT BE RESPONSIBLE FOR THE ACCURACY OR COMPLETENESS OF SCANNED COPIES OF THIS PLAN SHEET.
၁	15-		THE ACCURACY OR COMPLETENESS OF SCANNED COPIES OF THIS PLAN SHEET.
	-6		AECOM 4 N. SECOND ST CITY OF EAST PALO ALTO
>	ED		SUITE 675 1960 TATE STREET SAN JOSE, CA 95113 EAST PALO ALTO, CA 94303
REVISED BY	E V I S		
VISE	E E		
Æ	DATE	STATIONARY MOUNTED CONSTRUCTION AREA SIGNS	
		CUEET SIGN NO CONTRACTOR PANEL NO. OF SIGNS	


SHEET No.	SIGN No.	SIGN CODE	PANEL SIZE in x in	SIGN MESSAGE	No. OF POST AND SIZE	No. OF SIGNS (N) (EA)
CS-1	Α	W20-1	60 × 60	ROAD WORK AHEAD	2 - 4" × 6"	5
CS-1	В	W20-1	48 × 48	ROAD WORK AHEAD	1 - 4" × 6"	6
CS-1	С	G20-2	36 × 18	END ROAD WORK	1 - 4" × 4"	7
CS-1	D	C40 (CA)	72 × 36	TRAFFIC FINES DOUBLED IN CONSTRUCTION ZONES	2 - 4" × 6"	5
CS-1	М	SPECIAL	90 × 60	CONSTRUCTION PROJECT FUNDING SIGNS	2 - 6" × 6"	2
					TOTAL	25

(N): NOT A SEPARATE BID ITEM.

CONSTRUCTION AREA SIGNS
QUANTITIES

CS-2

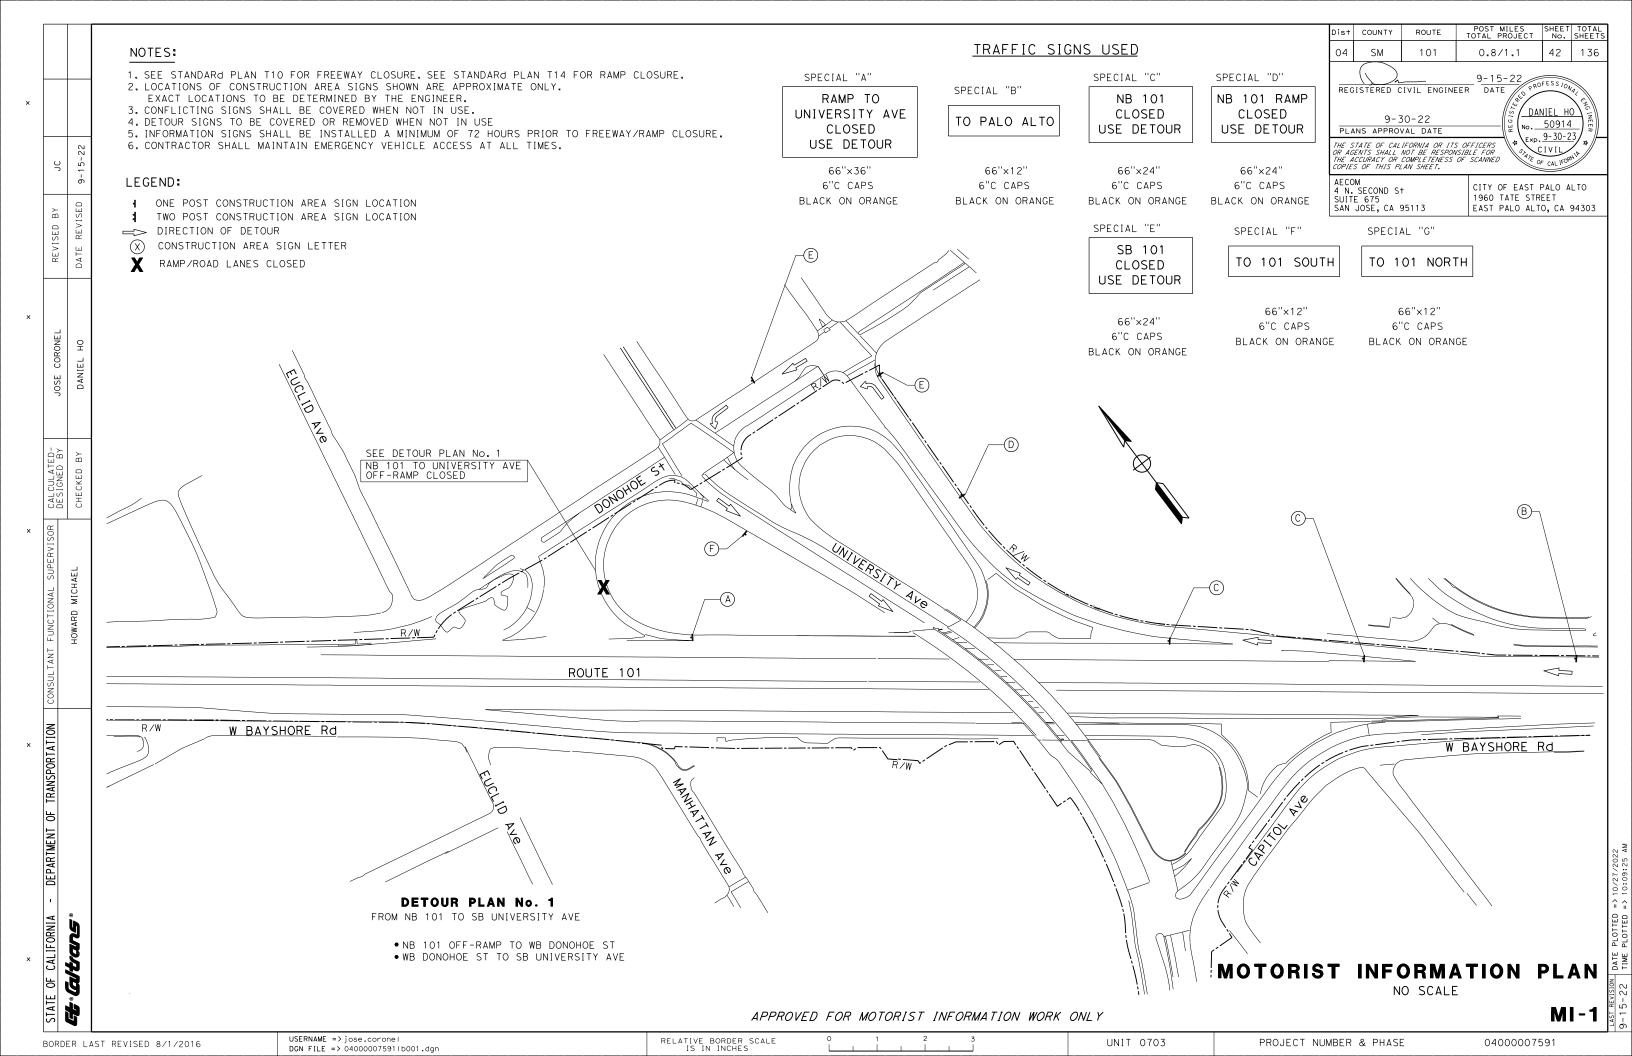

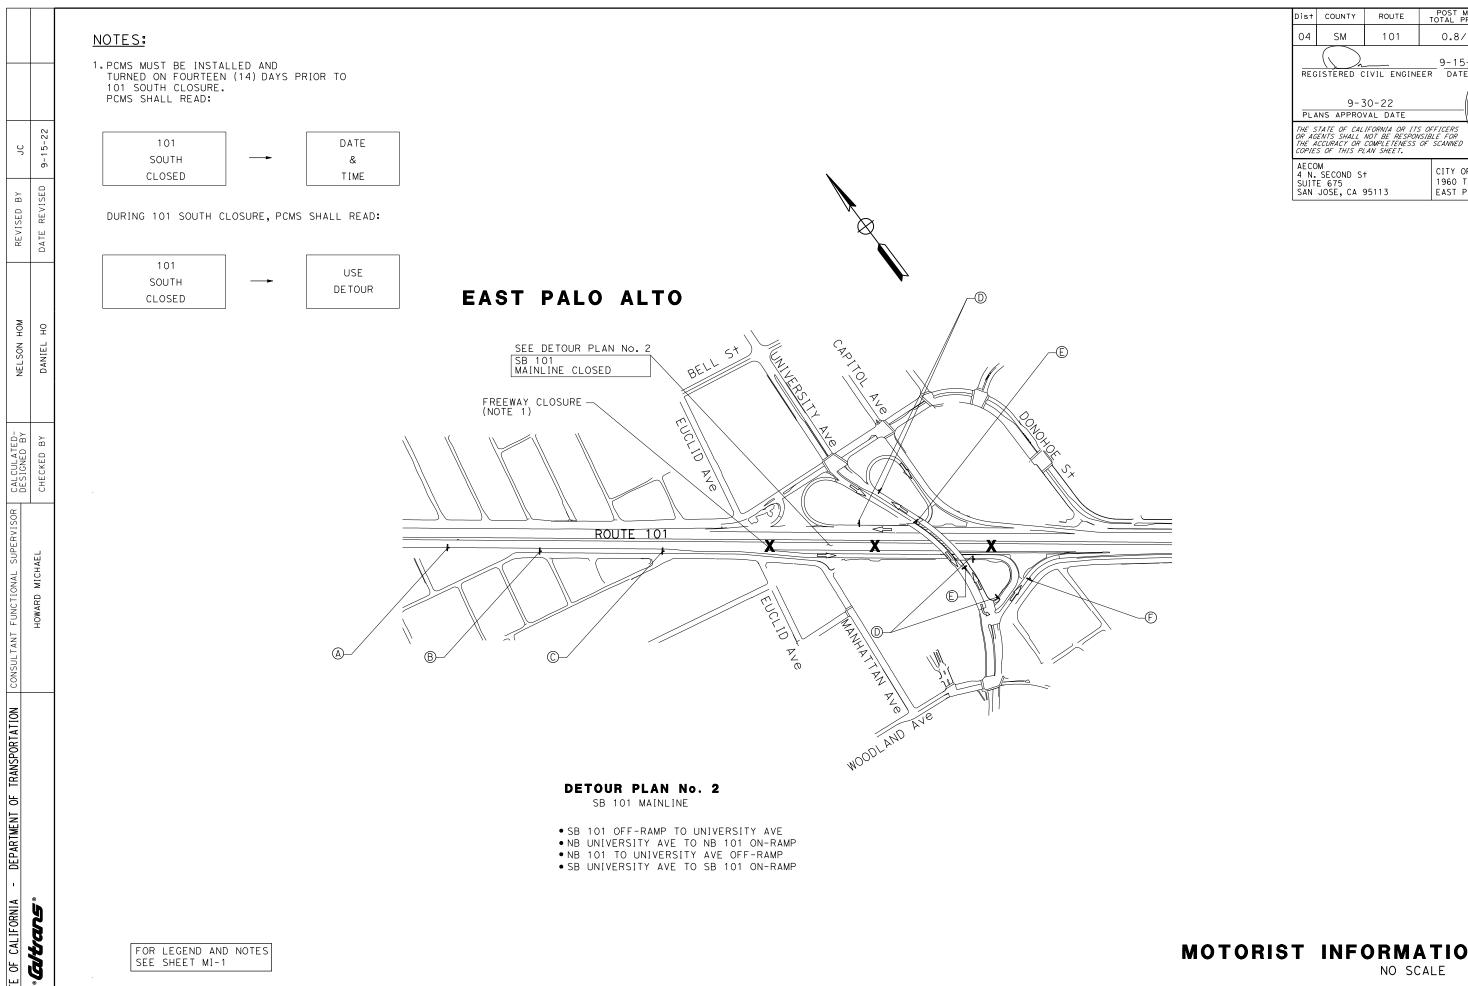

MOTORIST INFORMATION PLAN

NO SCALE

MI-2

APPROVED FOR MOTORIST INFORMATION WORK ONLY

BORDER LAST REVISED 8/1/2016

USERNAME => jose.corone! DGN FILE => 040000075911b002.dgn RELATIVE BORDER SCALE IS IN INCHES

UNIT 0703

PROJECT NUMBER & PHASE

POST MILES SHEET TOTAL TOTAL PROJECT No. SHEETS

0.8/1.1

04

 SM

101

REGISTERED CIVIL ENGINEER DATE

9-30-22

PLANS APPROVAL DATE

43

DANIEL HO


vo. 50914


Exp. 9-30-23

CITY OF EAST PALO ALTO

1960 TATE STREET EAST PALO ALTO, CA 94303

136

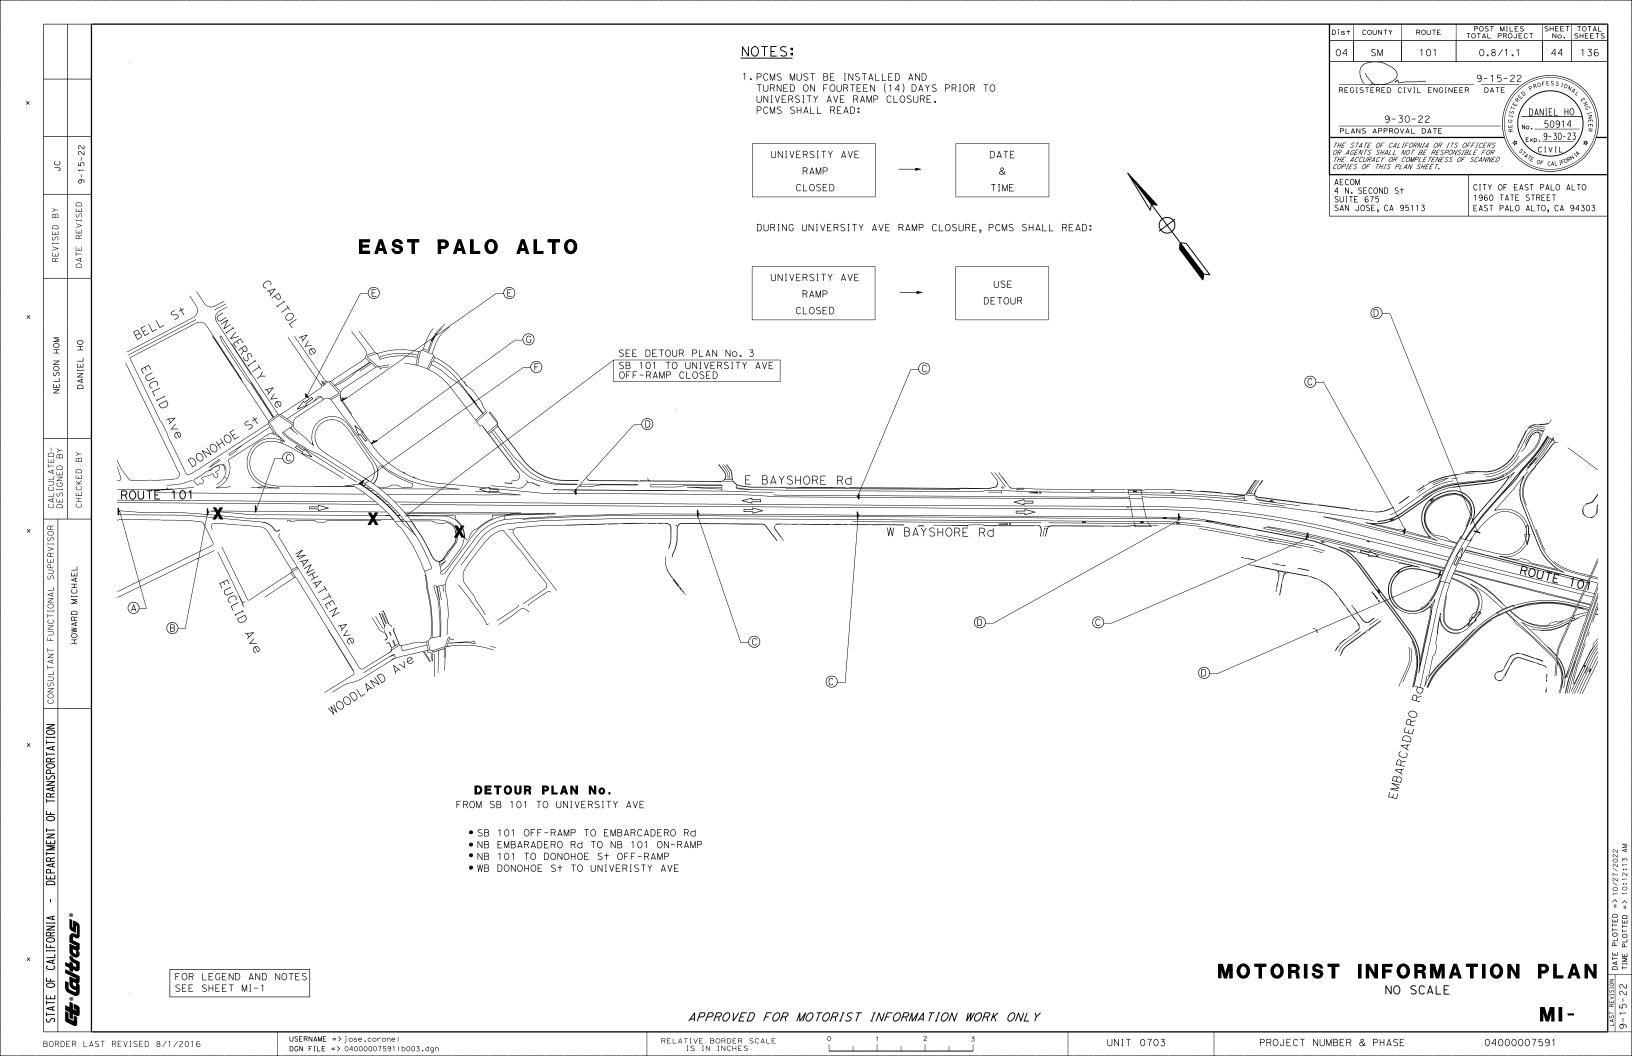

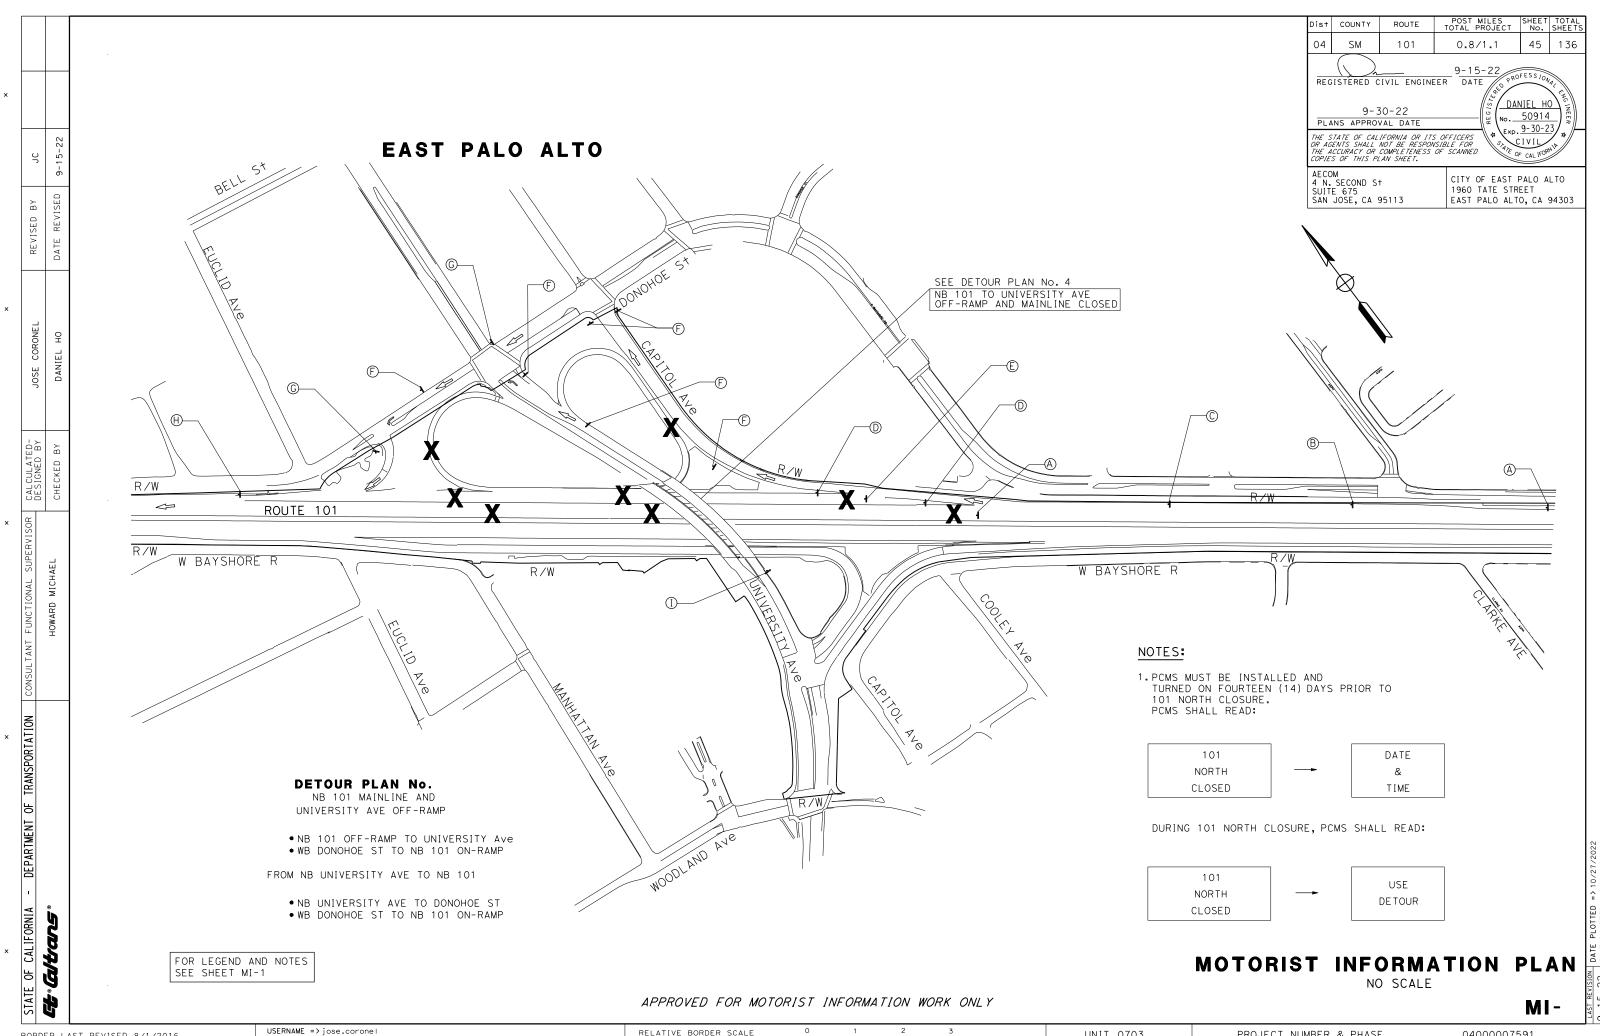

USERNAME => jose.corone| DGN FILE => 04000007591|b004.dgn

RELATIVE BORDER SCALE IS IN INCHES

PROJECT NUMBER & PHASE

04000007591

UNIT 0703

STATIONARY MOUNTED CONSTRUCTION AREA SIGNS


SHEET	SIGN	SIGN	PANEL	POST SIZE	ROADSIDE SIGN WOOD (N)	No. o SIGNS	No. o PCMS	SIGN MESSAGE
No.	No.	DESIGNATION	SIZE		ONE_POST	(N)	(N)	
				4" × 4"	EΑ	EΑ		
	А	SC6-4 (CA)	48" × 18"	X	X	1		"RAMP CLOSED"
	В	SPECIAL "A"	66" × 36"	X	X	1		"RAMP TO UNIVERSITY AVE CLOSED USE DETOUR"
	С	SC18(CA)	48" × 18"	X	x	2		" (◄) EXIT"
M I – 1		SPECIAL "B"	66" x 12"		^	۷.		"TO PALO ALTO"
IVII	D	M4-9L	48" × 18"	X	X	1		" ←) DETOUR"
	E	M4-9L	48" × 18"	X	×	2		" ←) DETOUR"
	_	SPECIAL "B"	66" x 12"	^	^	۷		"TO PALO ALTO"
	F	M4-8a	48" × 18"	Χ	X	1		"END DETOUR"
	А	PCMS					1	"SB 101 CLOSED"
	В	SPECIAL "E"	66" × 24"	Χ	X	1		"SB 101 CLOSED USE DETOUR"
	С	SC18(CA)	48" × 18"	V	V	1		" (◄) EXIT"
	C	SPECIAL "F"	66" × 12"	X	X	1		"TO 101 SOUTH"
MI-2	D	M4-9R	48" × 18"	V	V			" (→) DETOUR"
	D	SPECIAL "B"	66" x 12"	X	X	2		"TO 101 SOUTH"
	E	M4-9L	48" × 18"	V	V	_		" (←) DETOUR"
	E	SPECIAL "B"	66" x 12"	X	X	2		"TO 101 SOUTH"
	F	M4-8a	24" × 18"	X	X	1		"END DETOUR"
	А	PCMS					1	"UNIVERSITY AVE RAMP CLOSED"
	В	SPECIAL "A"	66" × 36"	X	X	1		"RAMP TO UNIVERSITY AVE CLOSED USE DETOUR"
	С	SC3 (CA)	48" x 18"	V	V	6		" (1) DETOUR"
		SPECIAL "B"	66" x 12"	X	X	6		"TO PALO ALTO "
		M4-8	24" × 18"					"DE TOUR"
MI - 3	D	SPECIAL "B"	66" x 12"	Χ	X	4		"TO PALO ALTO"
		M6-2	21" x 15"	^	^			"(╭)" ARROW
		M4-9L	48" × 18"			_		" (←) DE TOUR"
	E	SPECIAL "B"	66" x 12"	X	X	2		"TO PALO ALTO"
	F	M4-8a	24" x 18"	X	X	1		"END DETOUR"
	G	M4-9L	48" × 18"	X	X	1		" (+) DETOUR"
	A	PCMS	70 10	^	^	1	2	"NB 101 CLOSED"
	В	SPECIAL "C"	66" × 24"	X	X	1		"NB 101 CLOSED USE DETOUR"
	_	SC18(CA)	48" x 18"					" (*) EXIT"
	С	SPECIAL "G"	66" × 12"	X	X	1		"TO 101 NORTH"
	_	M4-9R	48" × 18"		, , , , , , , , , , , , , , , , , , ,			" (→) DETOUR"
	D	SPECIAL "G"	66" x 12"	X	X	2		"TO 101 NORTH"
MI - 4	E	SC6-4 (CA)	48" x 18"	X	X	1		"RAMP CLOSED"
		M4-9L	48" × 18"					" (+) DETOUR"
	F	SPECIAL "G"	66" x 12"	X	X	6		"TO 101 NORTH"
		SC3 (CA)	48" x 18"					" (1) DETOUR"
	G	SPECIAL "B"	66" x 12"	Χ	X	2		"TO 101 NORTH"
		M4-8a	48" × 18"	X	X	1		"END DETOUR"
	Н	I M4-60						

N - NOT A SEPARATE BID ITEM.

POST MILES SHEET TOTAL TOTAL PROJECT No. SHEETS Dist COUNTY 04 46 136 SM 0.8/1.1 101 REGISTERED CIVIL ENGINEER 9-15-22 DANIEL HO 9-30-22 No. 50914 PLANS APPROVAL DATE Exp. 9-30-23 THE STATE OF CALIFORNIA OR ITS OFFICERS OR AGENTS SHALL NOT BE RESPONSIBLE FOR THE ACCURACY OR COMPLETENESS OF SCANNED COPIES OF THIS PLAN SHEET. AECOM 4 N. SECOND S+ SUITE 675 SAN JOSE, CA 95113 CITY OF EAST PALO ALTO 1960 TATE STREET EAST PALO ALTO, CA 94303


MOTORIST INFORMATION **QUANTITES**

MIQ-1

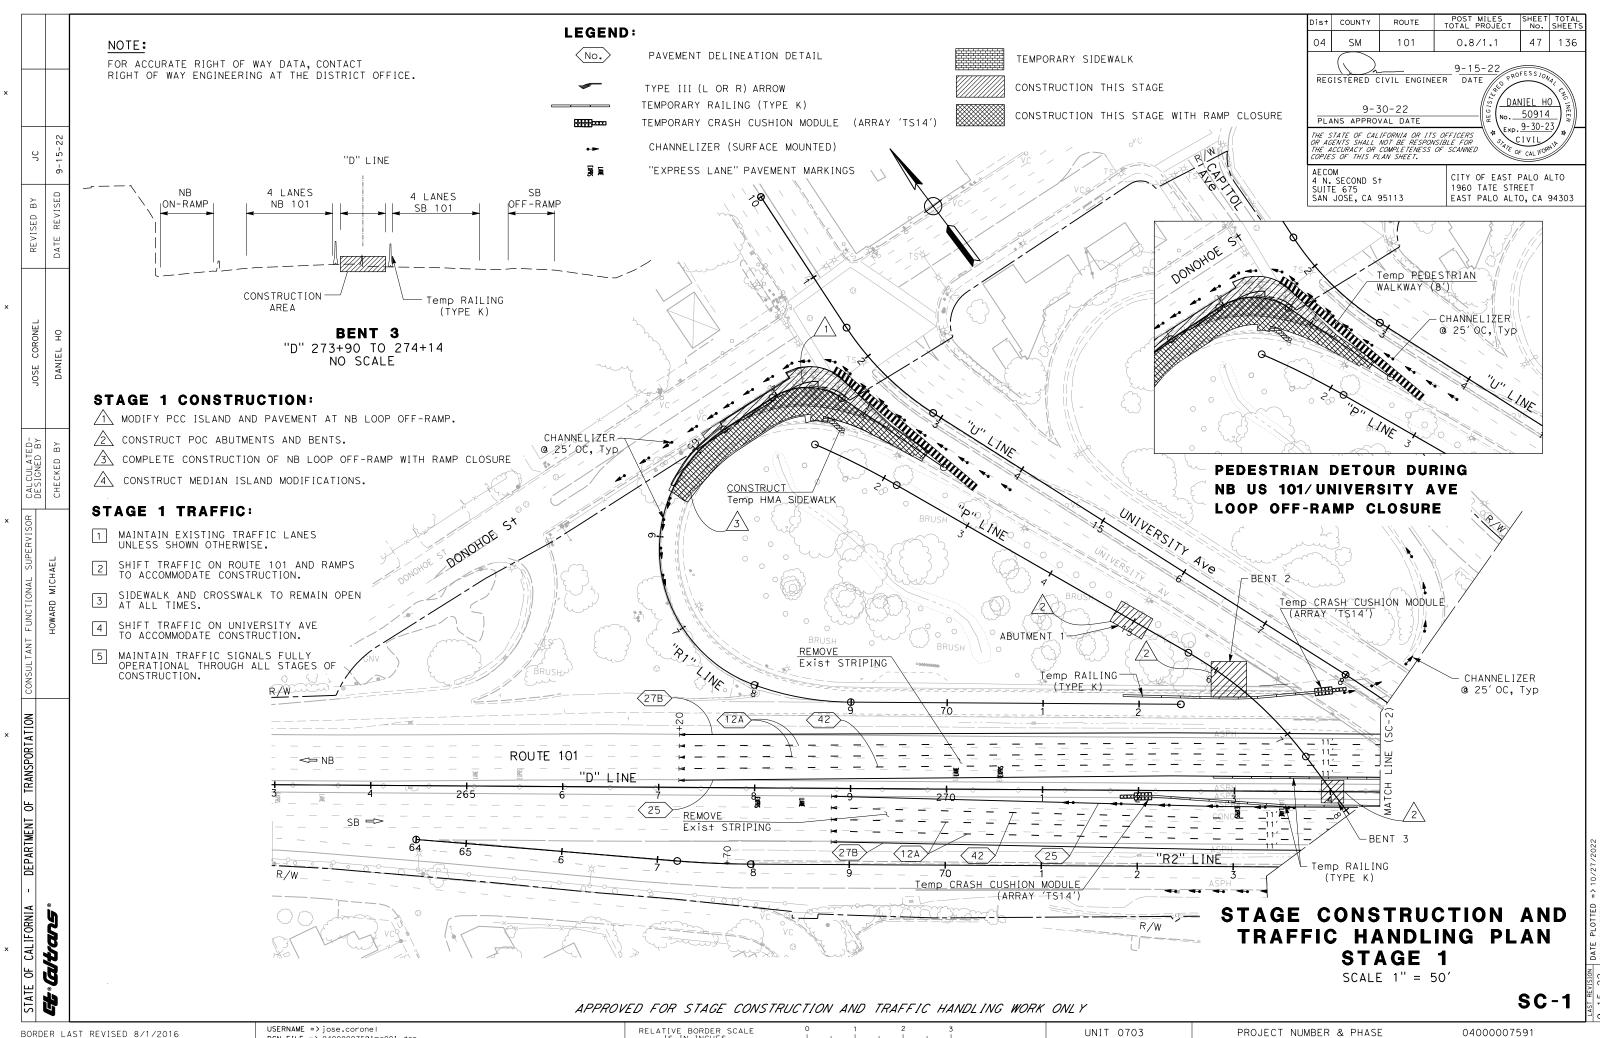


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RELATIVE BORDER SCALE
IS IN INCHES

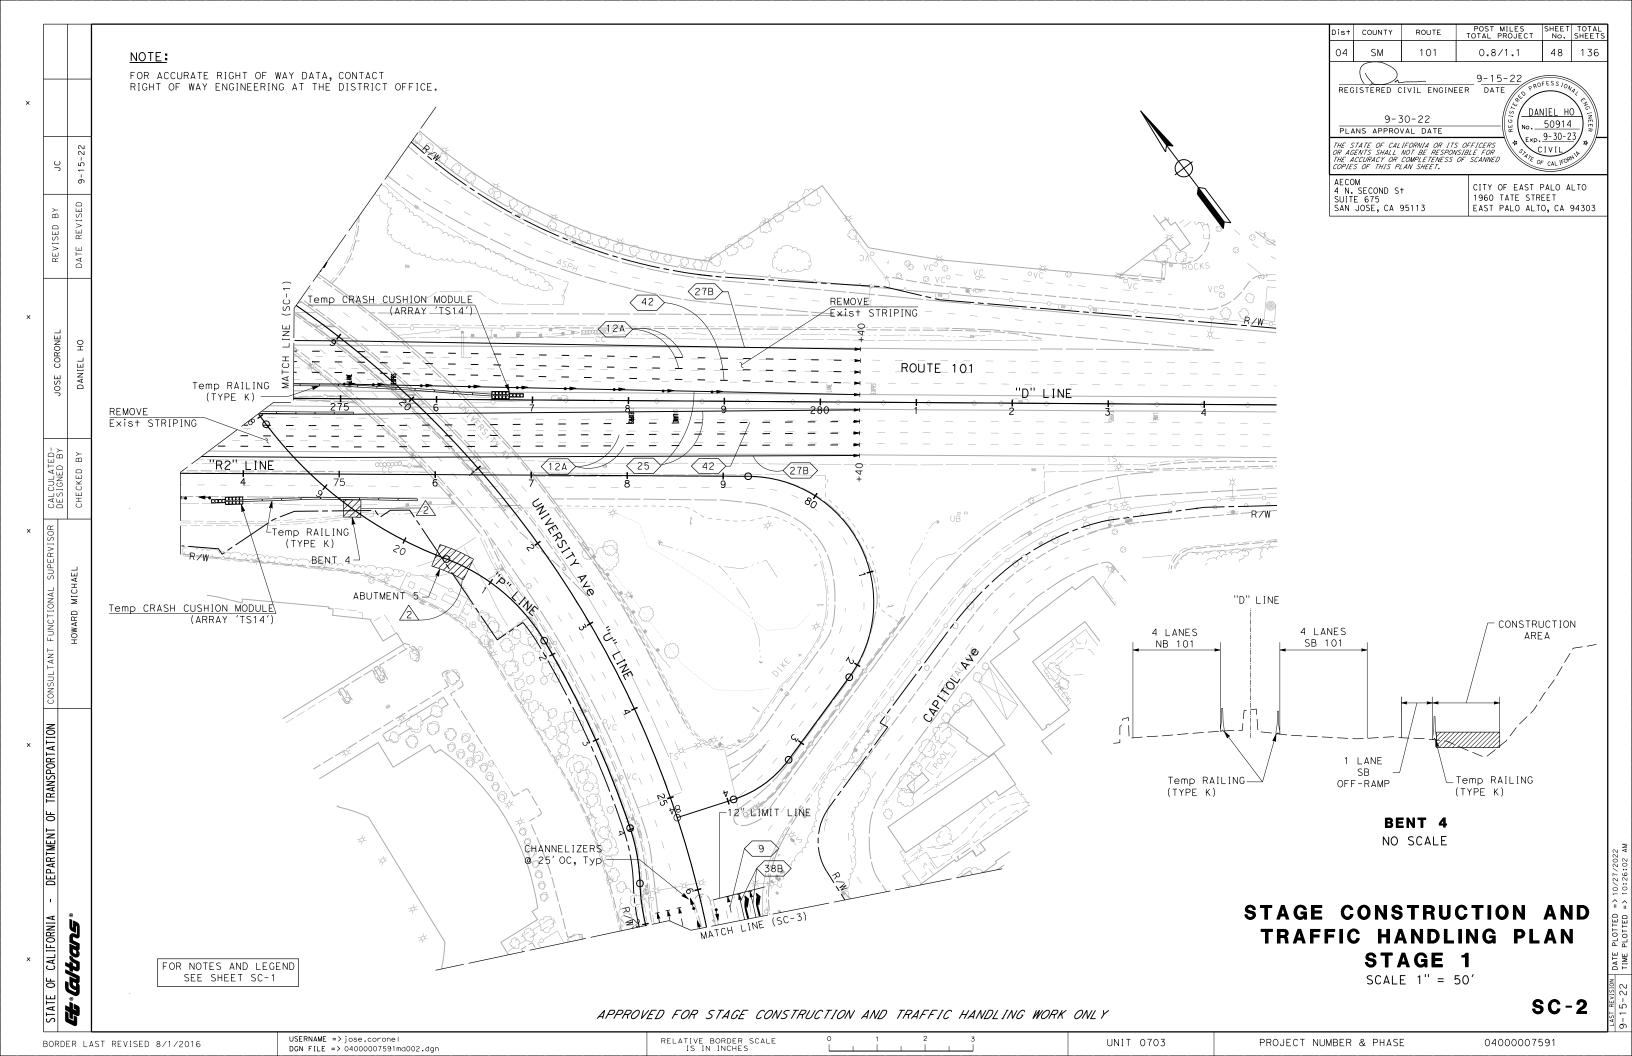

FOR ACCURATE RIGHT OF WAY DATA, CONTACT RIGHT OF WAY ENGINEERING AT THE DISTRICT OFFICE.

POST MILES SHEET TOTAL TOTAL PROJECT No. SHEETS Dist COUNTY 49 | 136 04 0.8/1.1 SM 101 REGISTERED CIVIL ENGINEER DATE DANIEL HO 9-30-22 o. <u>50914</u> PLANS APPROVAL DATE Exp. 9-30-23 THE STATE OF CALIFORNIA OR ITS OFFICERS
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COPIES OF THIS PLAN SHEET. AECOM 4 N. SECOND S+ SUITE 675 SAN JOSE, CA 95113 CITY OF EAST PALO ALTO 1960 TATE STREET EAST PALO ALTO, CA 94303

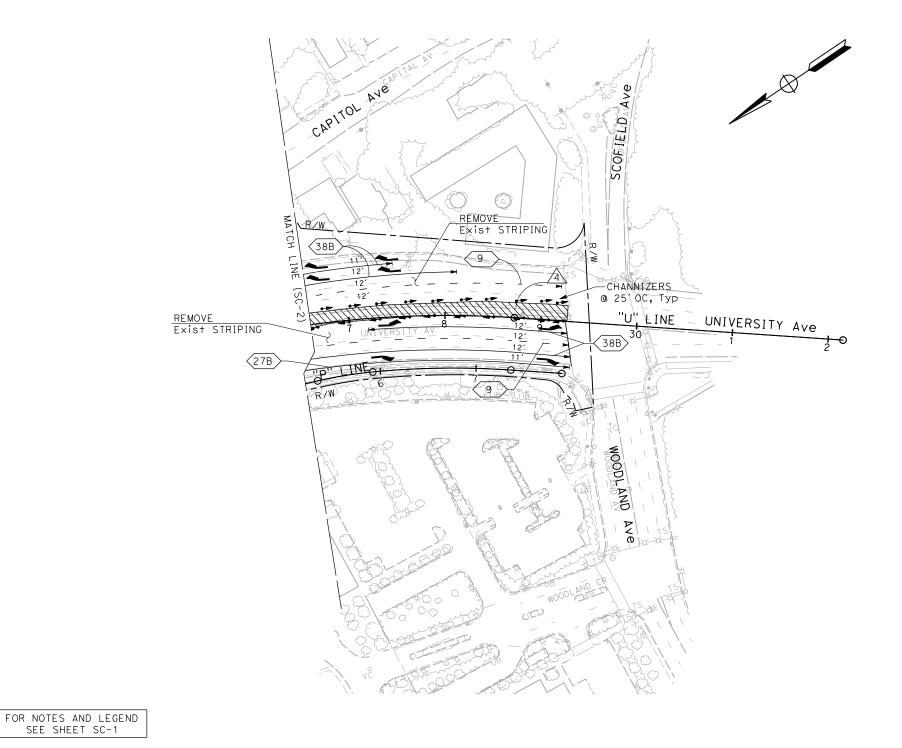

STAGE CONSTRUCTION AND TRAFFIC HANDLING PLAN STAGE 1

SCALE 1'' = 50'

SC-3

APPROVED FOR STAGE CONSTRUCTION AND TRAFFIC HANDLING WORK ONLY

BORDER LAST REVISED 8/1/2016


USERNAME => jose.corone! DGN FILE => 04000007591ma003.dgn RELATIVE BORDER SCALE IS IN INCHES

UNIT 0703

PROJECT NUMBER & PHASE

04000007591

SEE SHEET SC-1

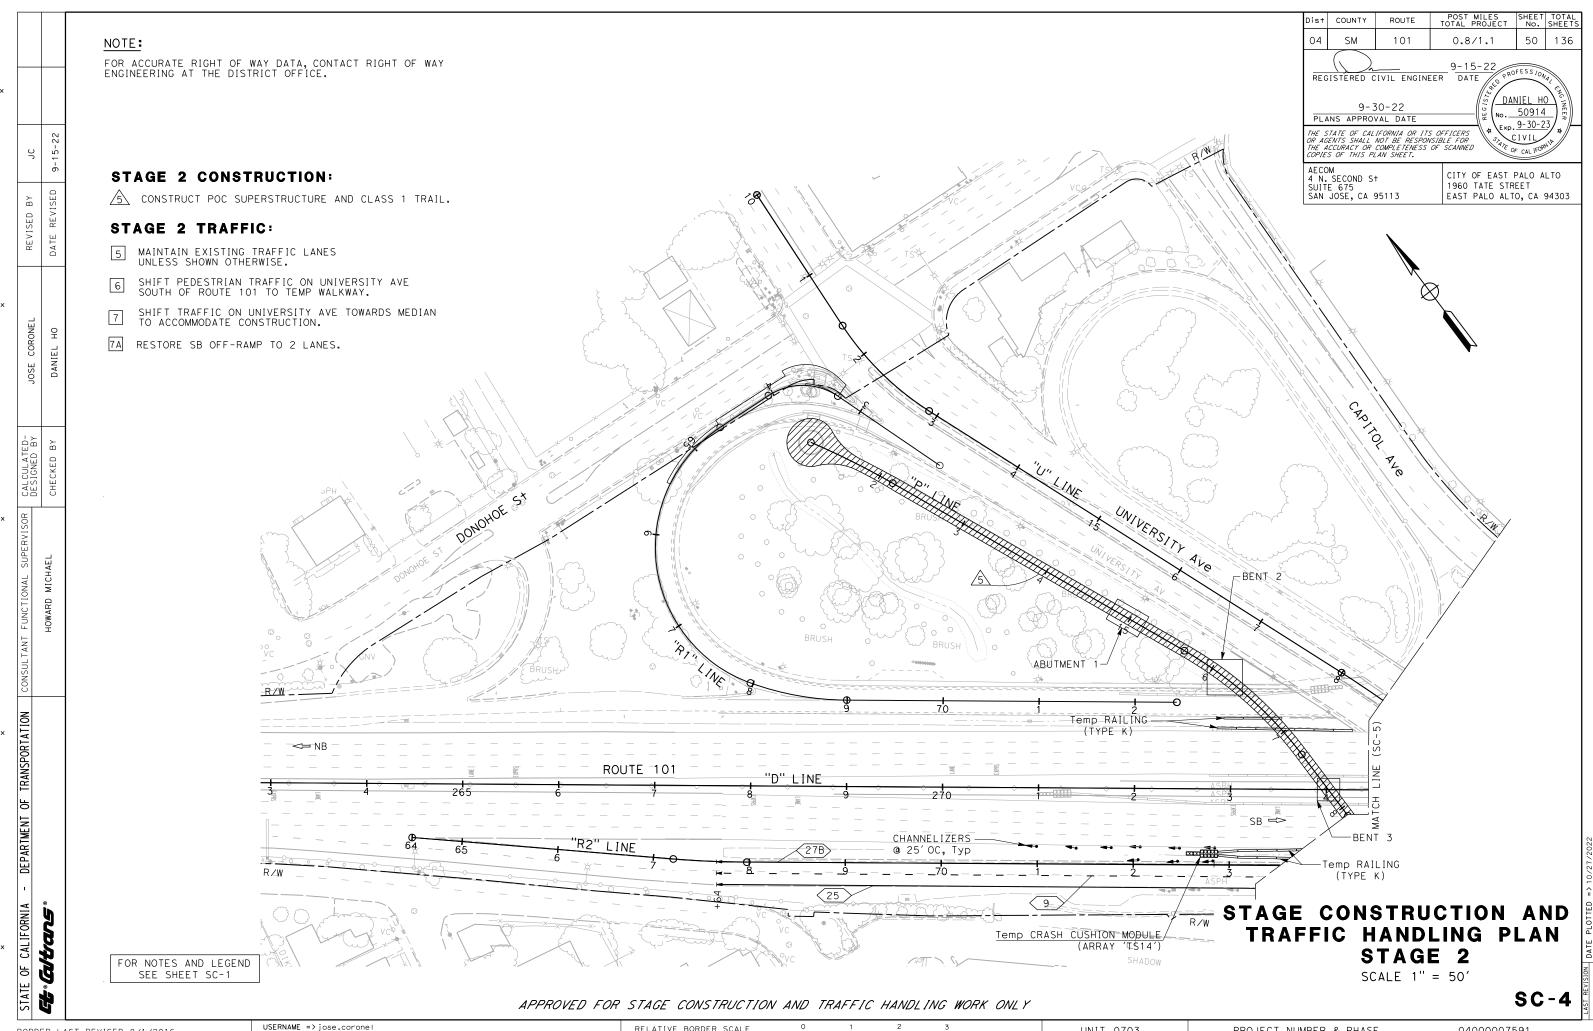


BORDER LAST REVISED 8/1/2016 DGN FILE => 04000007591ma004.dgn

RELATIVE BORDER SCALE IS IN INCHES

UNIT 0703

PROJECT NUMBER & PHASE

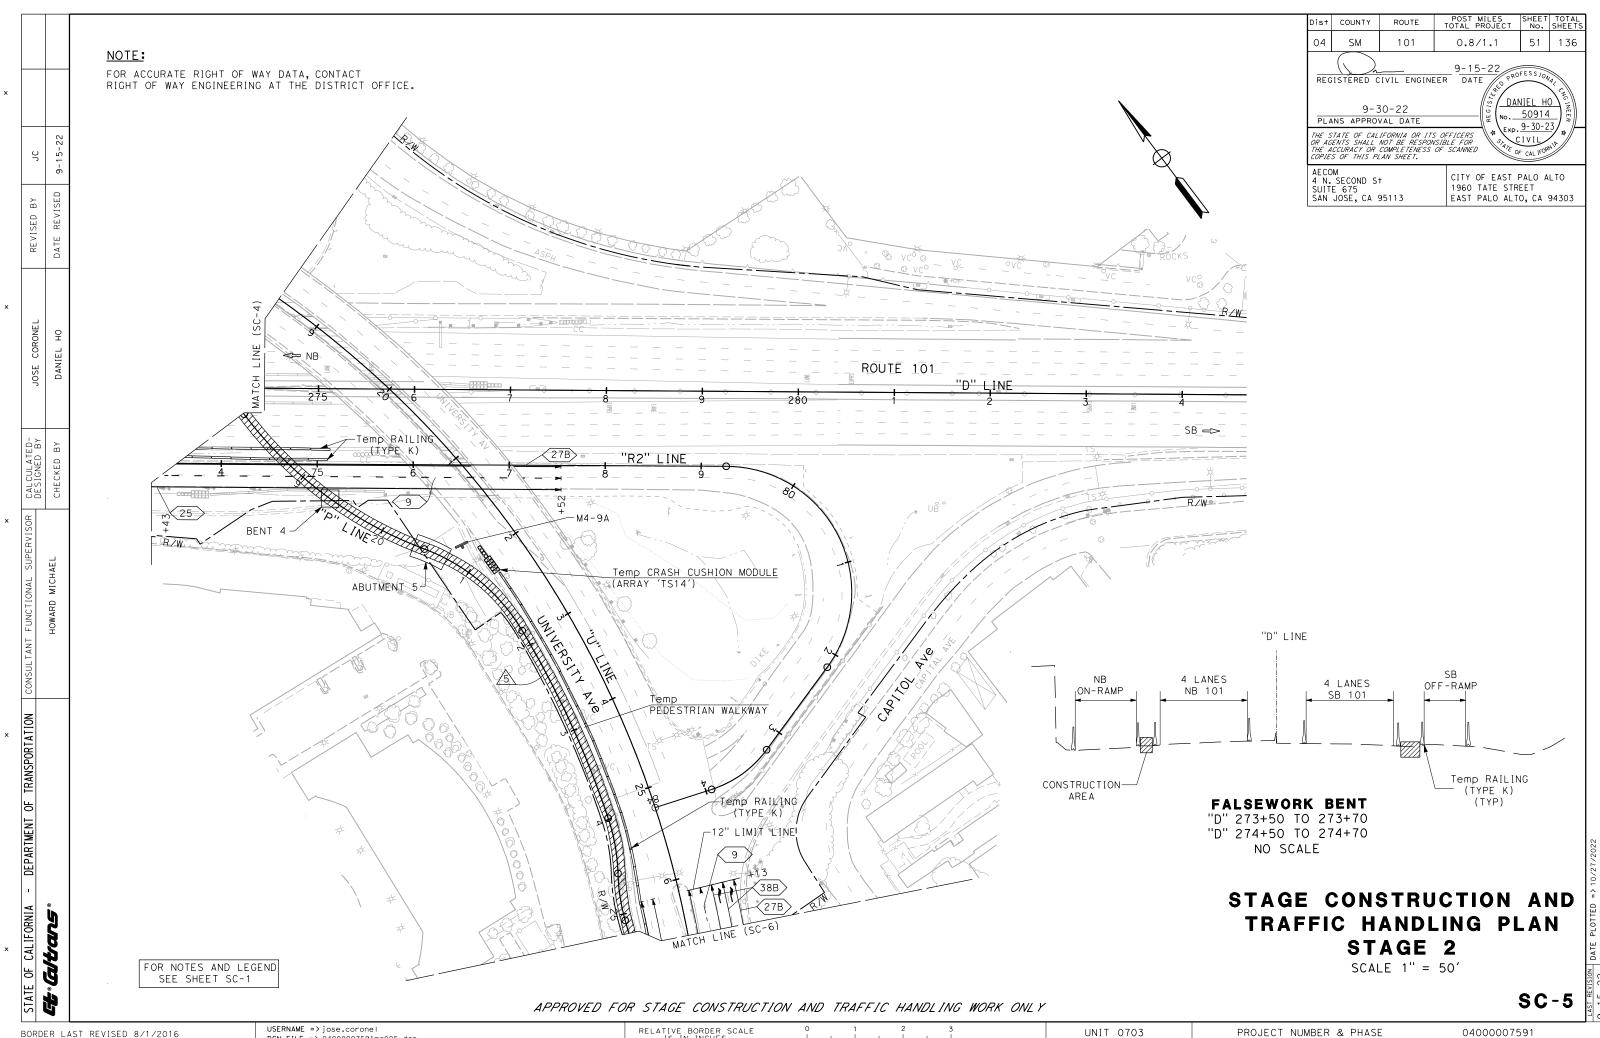

DGN FILE => 04000007591ma005.dgn

RELATIVE BORDER SCALE IS IN INCHES


REVISED


DEPARTMENT OF TRANSPORTATION | CONSULTANT

CALIFORNIA

P

FOR ACCURATE RIGHT OF WAY DATA, CONTACT RIGHT OF WAY ENGINEERING AT THE DISTRICT OFFICE.

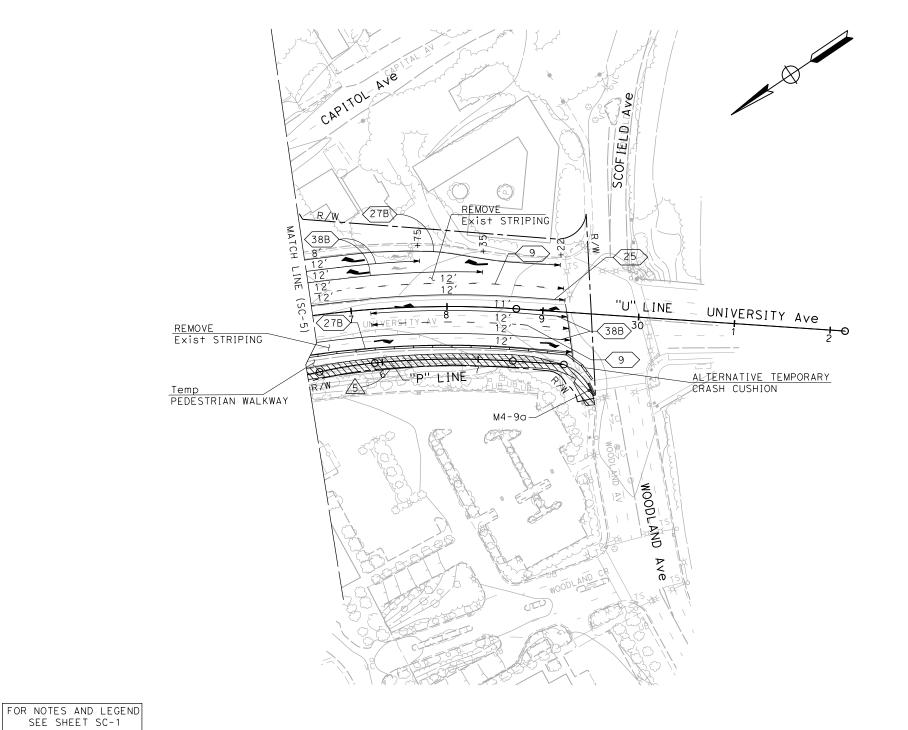

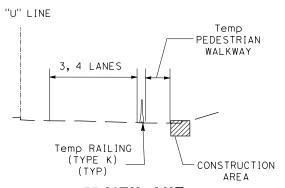

UNIVERSITY AVE

"D" 23+50 TO 27+90 NO SCALE

STAGE CONSTRUCTION AND TRAFFIC HANDLING PLAN STAGE 2

SCALE 1" = 50'

SC-6

APPROVED FOR STAGE CONSTRUCTION AND TRAFFIC HANDLING WORK ONLY


BORDER LAST REVISED 8/1/2016

SEE SHEET SC-1

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UNIT 0703

PROJECT NUMBER & PHASE

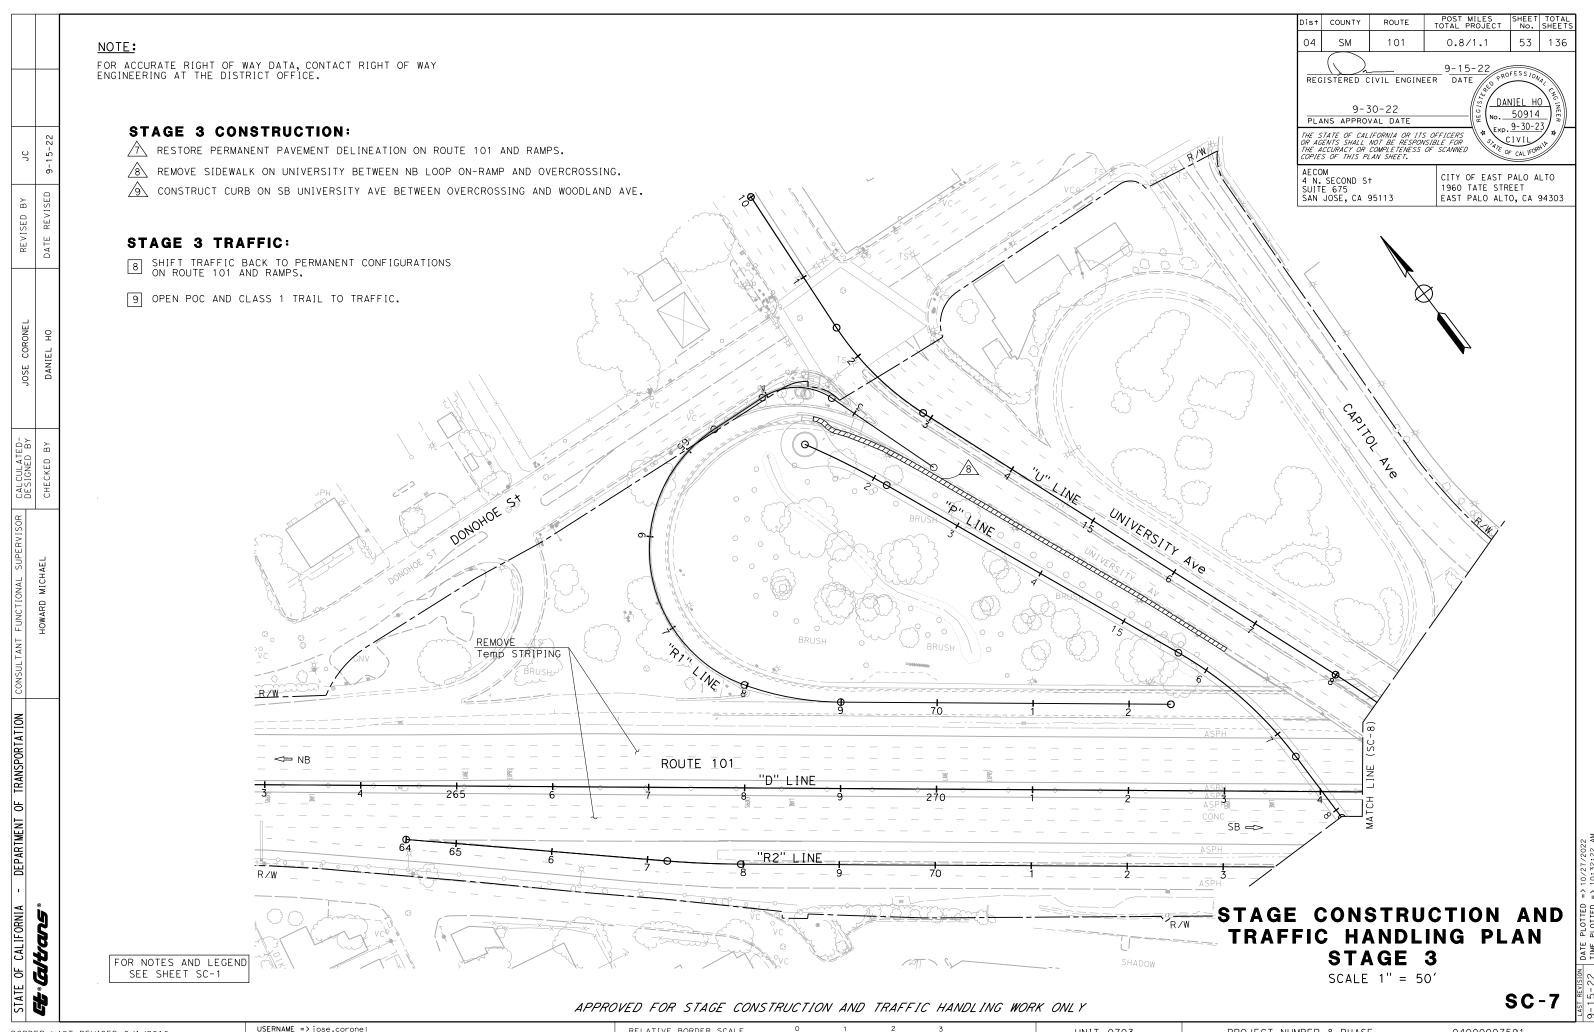


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RELATIVE BORDER SCALE IS IN INCHES

UNIT 0703

PROJECT NUMBER & PHASE

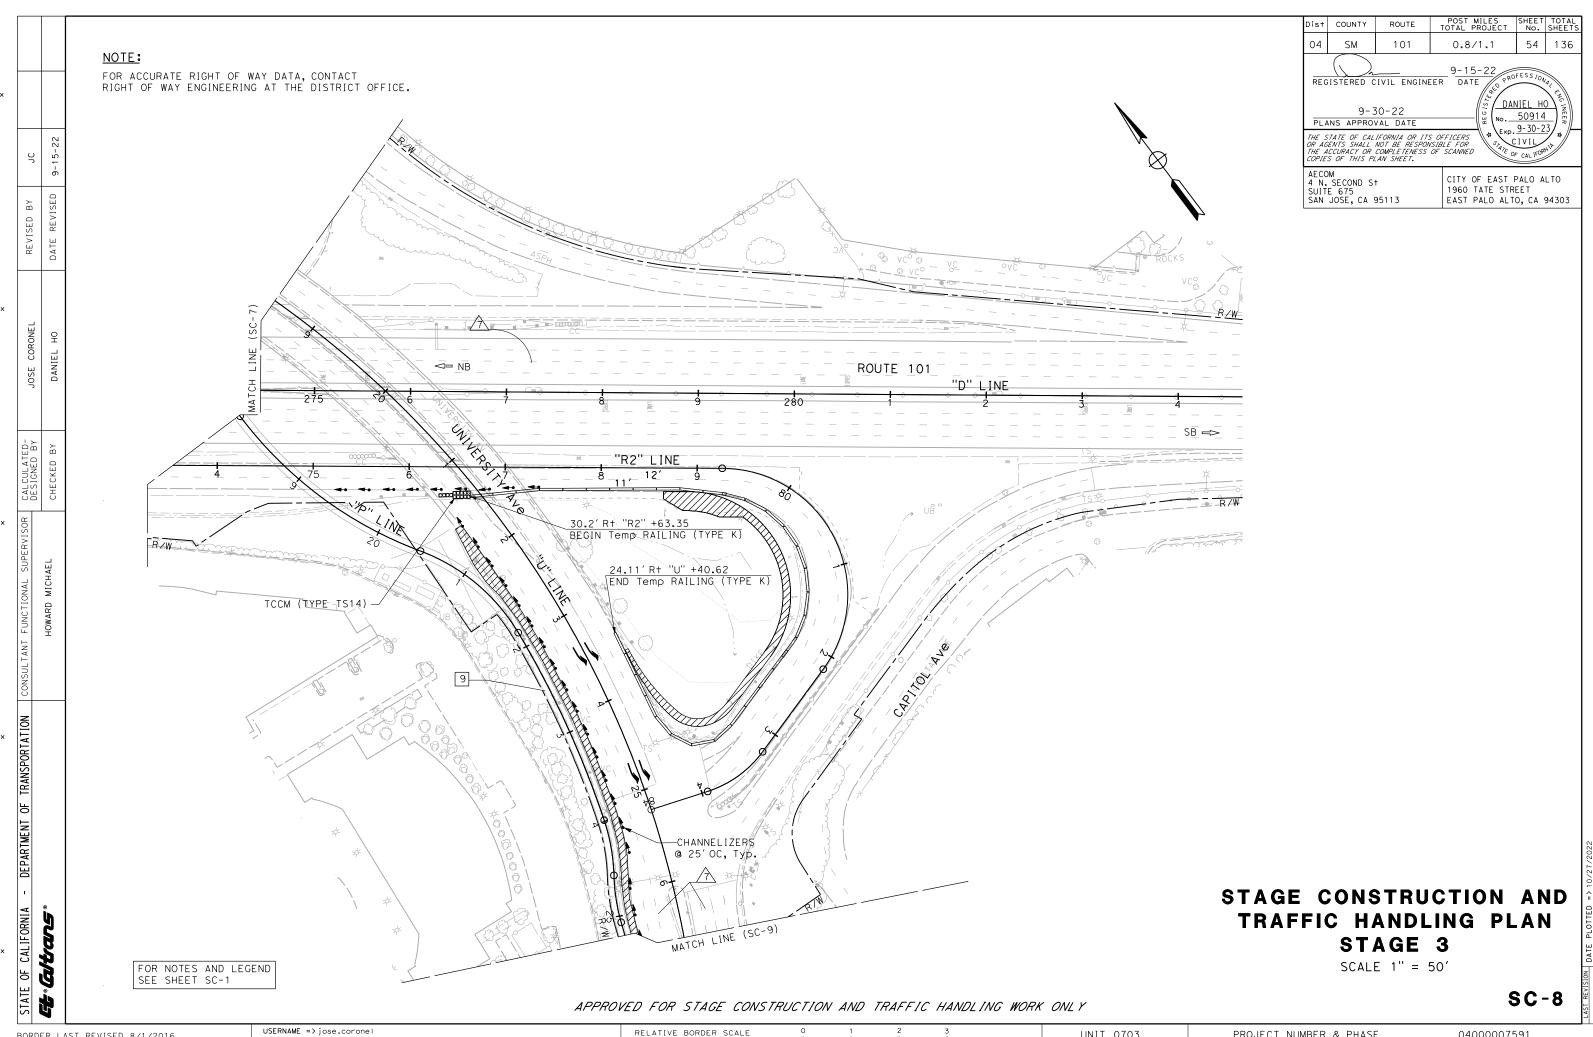

DGN FILE => 04000007591ma008.dgn

RELATIVE BORDER SCALE IS IN INCHES

UNIT 0703

PROJECT NUMBER & PHASE

04000007591


BORDER LAST REVISED 8/1/2016

REVISED

DEPARTMENT OF TRANSPORTATION | CONSULTANT

STATE OF CALIFORNIA

FOR ACCURATE RIGHT OF WAY DATA, CONTACT RIGHT OF WAY ENGINEERING AT THE DISTRICT OFFICE.

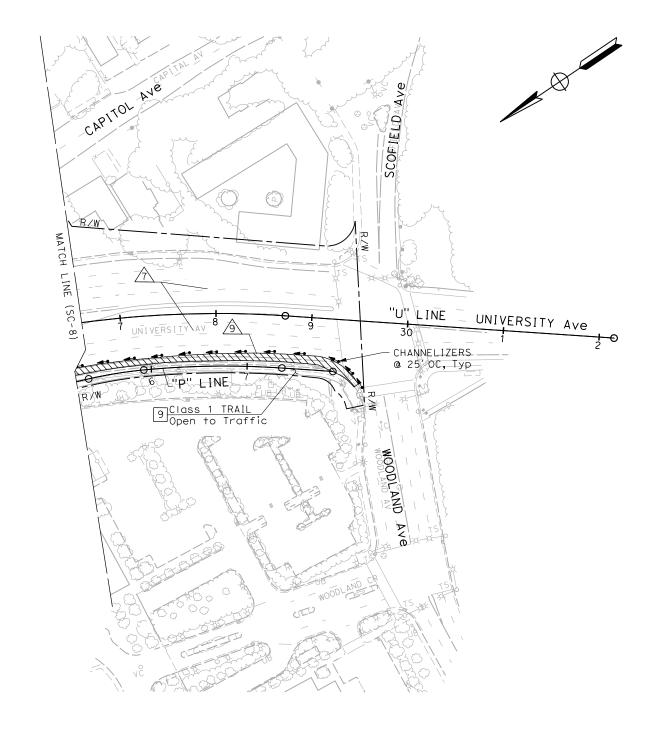

STAGE CONSTRUCTION AND TRAFFIC HANDLING PLAN STAGE 3

SCALE 1'' = 50'

SC-9

APPROVED FOR STAGE CONSTRUCTION AND TRAFFIC HANDLING WORK ONLY

BORDER LAST REVISED 8/1/2016

FOR NOTES AND LEGEND SEE SHEET SC-1

USERNAME => jose.corone! DGN FILE => 04000007591ma009.dgn RELATIVE BORDER SCALE IS IN INCHES

PROJECT NUMBER & PHASE

04000007591

UNIT 0703

Exp. 9-30-23 THE STATE OF CALIFORNIA OR ITS OFFICERS OR AGENTS SHALL NOT BE RESPONSIBLE FOR THE ACCURACY OR COMPLETENESS OF SCANNED COPIES OF THIS PLAN SHEET. AECOM 4 N. SECOND S+ SUITE 675 SAN JOSE, CA 95113

9-30-22

PLANS APPROVAL DATE

CITY OF EAST PALO ALTO 1960 TATE STREET EAST PALO ALTO, CA 94303

vo. 50914

TEMPORARY PAVEMENT DELINEATION QUANTITIES

SHEET No.	LOCATION	DETAIL No.	(2-COAT)	PAVEMENT MARKER (RETRO- REFLECTIVE)	PAINT PAV MARKING (2	COAT)	[N]	REMOVE THERMOPLASTIC PAVEMENT MARKING	REMOVE THERMOPLASTIC TRAFFIC STRIPE	REMOVE YELLOW THERMOPLASTIC TRAFFIC STRIPE (HAZARDOUS WASTE)	REMOVE PAVEMENT MARKER
			LF	EA	DESCRIPTION	EA[N]SQFT	SQFT	LF	LF	EA
		27B	1320								
		12A	2640	58					1320		58
	NB ROUTE 101	25	1320	29						1320	29
		42	1320	29					1320		29
SC-1.					EXPRS LANE	2	54	108			
SC-1, SC-2		27B	1162								
	CD DOUTE 101	12A	2324	56					1162		56
	SB ROUTE 101	25	1162	28						1162	29
		42	1162	28					1162		28
			700		EXPRES LANE	3	54	162			
		9	320	8							_
		10	700						320		8
		27B	320						320		
	SB UNIVERSITY Ave	37B							100		10
		38 38B	500	46					420		28
		388	520	46	TYPE III (I) APPOW		0.4	0.4			
					TYPE III (L) ARROW	2	84	84			
SC-2, SC-3		9	320	8	TYPE III (R) ARROW	2	84	84			
SC-3		10	320	0			+		320		8
		27B					+		320		•
		37B		12					200		12
	NB UNIVERSITY Ave	38		12			+		200		6
		38B	345	31					200		0
		300	343	J1	TYPE III (R) ARROW	4	168	168			
		9	1140	26	THE III (II) AIRION	7	100	100	1140		26
	SB ROUTE 101 OFF RAMP	25	1627	69					1140	1627	69
	3B NOOTE TOT OFT MAINI	27B	1588	- 00					1588	1021	- 03
		9	206	6					320		8
	CD UNIVERSITY A	27B	310						320		l
	SB UNIVERSITY Ave	38B	515	46			+		520		46
		332			TYPE III (R) ARROW	2	84	84	32.0		
SC-4-					TYPE III (L) ARROW	2	84	84			
ŠČ-6		9	312	7	3 111 (2) 1111(11)		† <u> </u>		320		8
		25	305	8						100	3
	NB UNIVERSITY Ave	27B	320						320		
	ND UNIVERSITE AVE	38B	265	26					345		31
					TYPE III (R) ARROW	5	210	168			
		TOTAL	20,823	521			822	942	12,037	4209	492

[N] = NOT A SEPARATE PAY ITEM, FOR INFORMATION ONLY

STAGE CONSTRUCTION AND TRAFFIC HANDLING QUANTITIES

SCQ-1

APPROVED FOR STAGE CONSTRUCTION AND TRAFFIC HANDLING WORK ONLY

REVISED

DEPARTMENT OF TRANSPORTATION | CONSULTANT

STATE OF CALIFORNIA

BORDER LAST REVISED 8/1/2016

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CALIFORNIA - DEPARTMENT OF TRANSPORTATION	CONSULTANT FUNCTIONAL SUPERVISOR	CALCULATED-	LOSE COBONEL	REVISED BY	۲	
		DESIGNED BY	SOSE CONONEE	,)	
itans*	HOWARD MICHAEL	СНЕСКЕВ ВУ	DANIEL HO	DATE REVISED	9-15-22	

Dist	COUNTY	ROUTE	POST MILES TOTAL PROJECT	SHEET No.	TOTAL SHEETS					
04	SM	101	0.8/1.1	57	136					
		SIVIL ENGINE 30-22 VAL DATE	BEGISTER	NIEL HO 50914 9-30-2	S INEER					
OR AG	ENTS SHALL	IFORNIA OR ITS NOT BE RESPON COMPLETENESS LAN SHEET.	S OFFICERS **\\\	IVIL.	/ ~// I					
AECOM 4 N. SECOND S+ SUITE 675 SAN JOSE, CA 95113 CITY OF EAST PALO ALTO 1960 TATE STREET EAST PALO ALTO, CA 94303										

TEMPORARY RAILING (TYPE K)

STATION	TEMPORARY RAILING (TYPE K)			
	LF			
STAGE 1				
"D" 271+34 R+ TO "D" 275+00 R+	400			
"R1" 71+80 L+ TO "D" 274+00 L+	220			
"D" 272+80 L+ TO "D" 276+60 L+	380			
"R2" 74+00 R+ T0 "R2" 75+82 R+	182			
STAGE 2				
"D" 272+90 L+ TO "D" 274+40 L+	200			
"D" 272+80 R+ TO "D" 275+20 R+	480			
"U" 21+20 R+ TO "U" 29+20 R+	700			
STAGE 3				
"R2" 76+63 R+ TO "U" 23+40 L+	768			
TOTAL	3330			

ALTERNATIVE TEMPORARY CRASH CUSHION

SHEET No.	STATION	EΑ
SC-6	"U" 29+45 R†	1
	TOTAL	1

TEMPORARY CRASH CUSHION MODULE


SHEET No.	STATION	ARRAY	EΑ
SC-1	"D" 271+00 R+	TS-14	14
SC-1	"D" 274+00 L+	TS-14	14
SC-2	"D" 276+60 L+	TS-14	14
SC-2	"D" 273+70 R†	TS-14	14
SC-4	"D" 272+60 R+	TS-14	14
SC-5	"U" 21+00 R†	TS-14	14
SC-8	"R2" 76+31 R+	TS-14	14
		TOTAL	98

CHANNELIZER

SHEET No.	LOCATION	EA
	"D" 274+16 L† TO "D" 274+80 L†	6
SC-1	"R1" 62+43.56 L+ TO 66+00 L+	20
	R2" 72+28 R† TO "R2" 73+66 R†	6
SC-2	"D" 275+00 L† TO "D" 279+00 L†	16
SC-3	"U" 26+00 TO "U" 29+30	28
SC-4	"D" 271+00 R† TO "D" 272+80 R†	9
SC-8	"R2" 75+23 R+ TO "R2" 77+34 R+	9
SC-8 & SC-9	"U" 20+40 R† TO "U" 29+30 R†	31
	TOTAL	125

STAGE CONSTRUCTION AND TRAFFIC HANDLING QUANTITES


SCQ-2

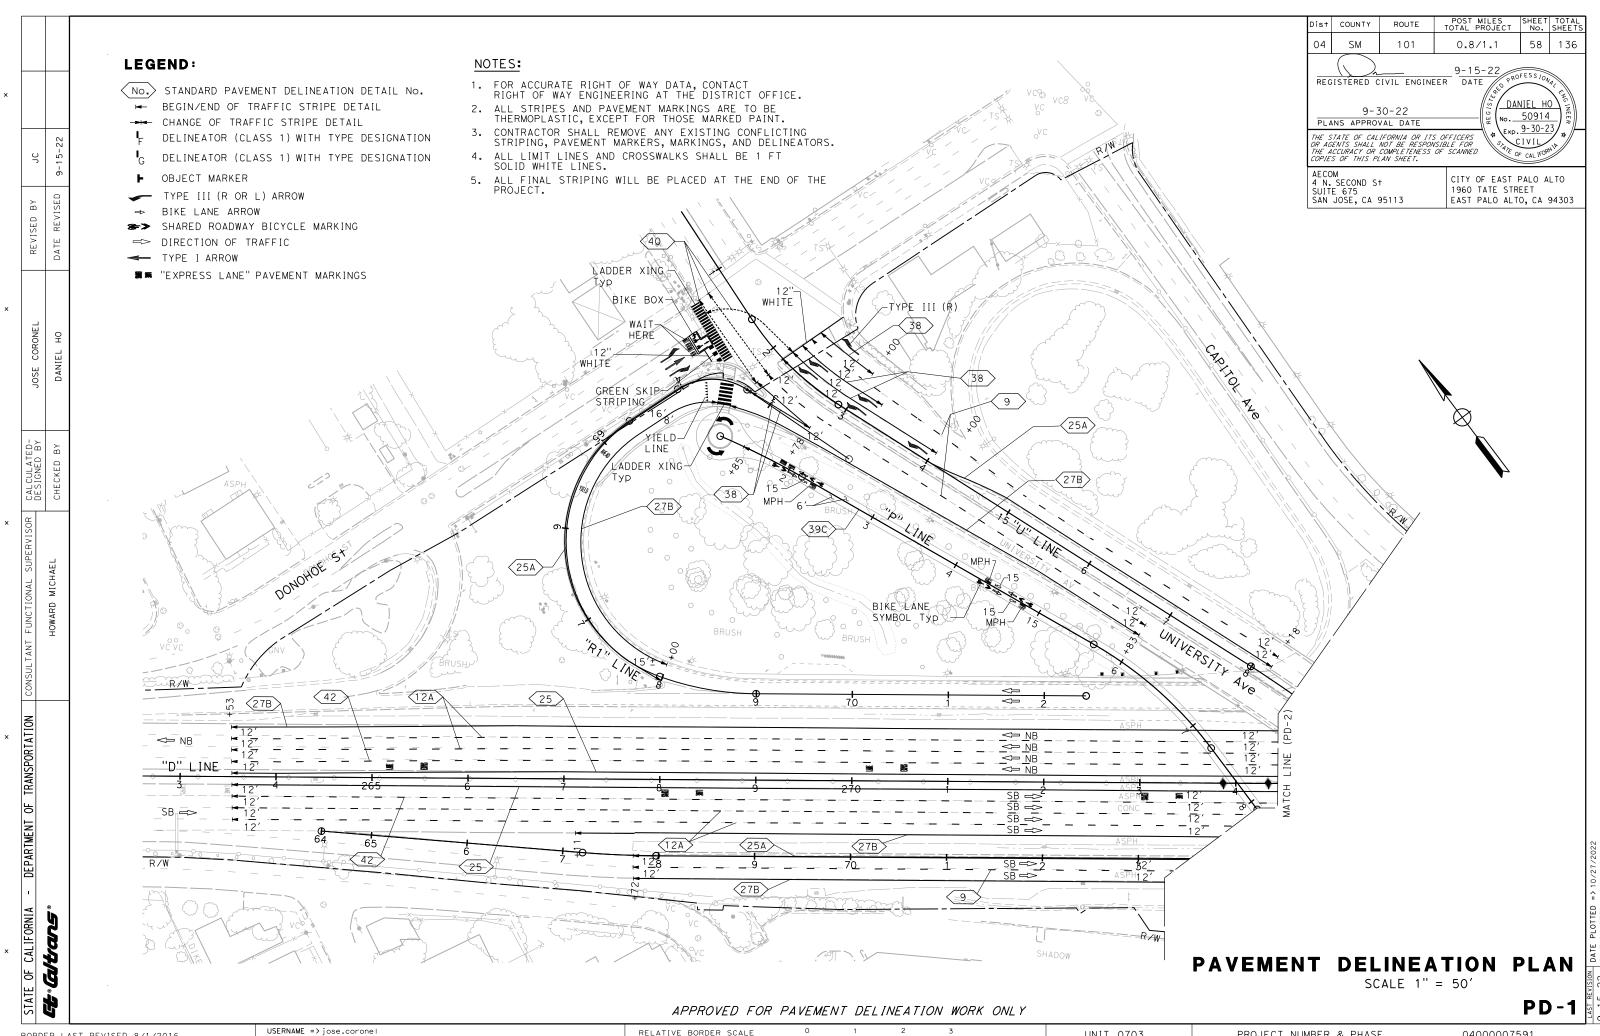

USERNAME => jose.coronel
DGN FILE => 04000007591na001.dgn


UNIT 0703

PROJECT NUMBER & PHASE

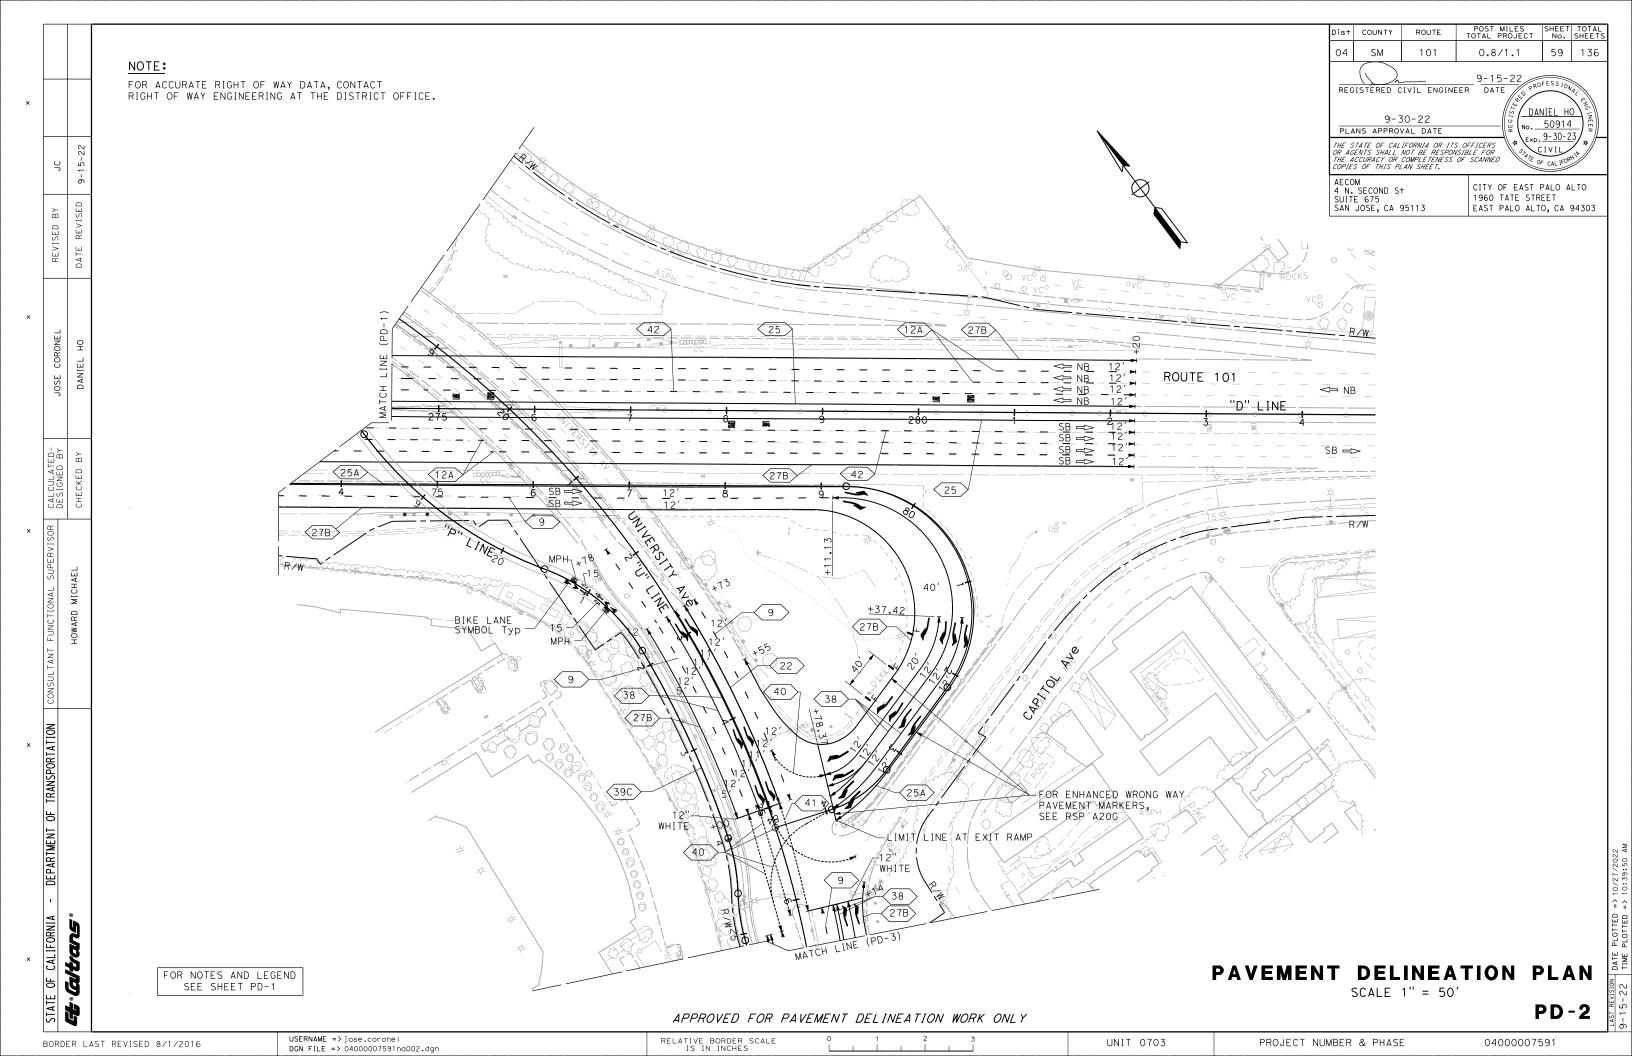

FOR ACCURATE RIGHT OF WAY DATA, CONTACT RIGHT OF WAY ENGINEERING AT THE DISTRICT OFFICE.

POST MILES SHEET TOTAL TOTAL PROJECT No. SHEETS Dist COUNTY 60 136 04 SM 101 0.8/1.1 REGISTERED CIVIL ENGINEER 9-15-22 DANIEL HO 9-30-22 ю. 50914 PLANS APPROVAL DATE Exp. 9-30-23 THE STATE OF CALIFORNIA OR ITS OFFICERS
OR AGENTS SHALL NOT BE RESPONSIBLE FOR
THE ACCURACY OR COMPLETENESS OF SCANNED
COPIES OF THIS PLAN SHEET. AECOM 4 N. SECOND S† SUITE 675 SAN JOSE, CA 95113 CITY OF EAST PALO ALTO 1960 TATE STREET EAST PALO ALTO, CA 94303

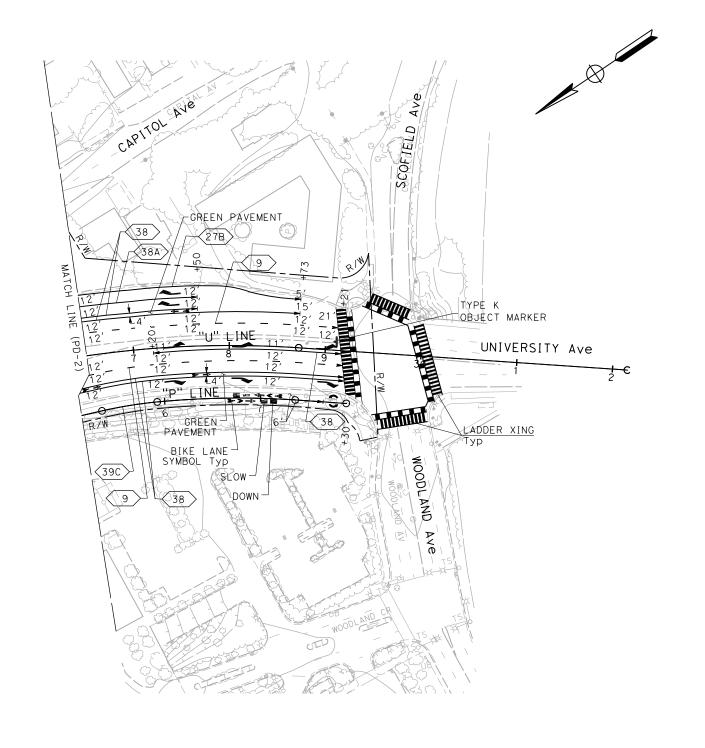

PAVEMENT DELINEATION PLAN

SCALE 1'' = 50'

PD-3


APPROVED FOR PAVEMENT DELINEATION WORK ONLY

USERNAME => jose.corone!

UNIT 0703

PROJECT NUMBER & PHASE

FOR NOTES AND LEGEND SEE SHEET PD-1

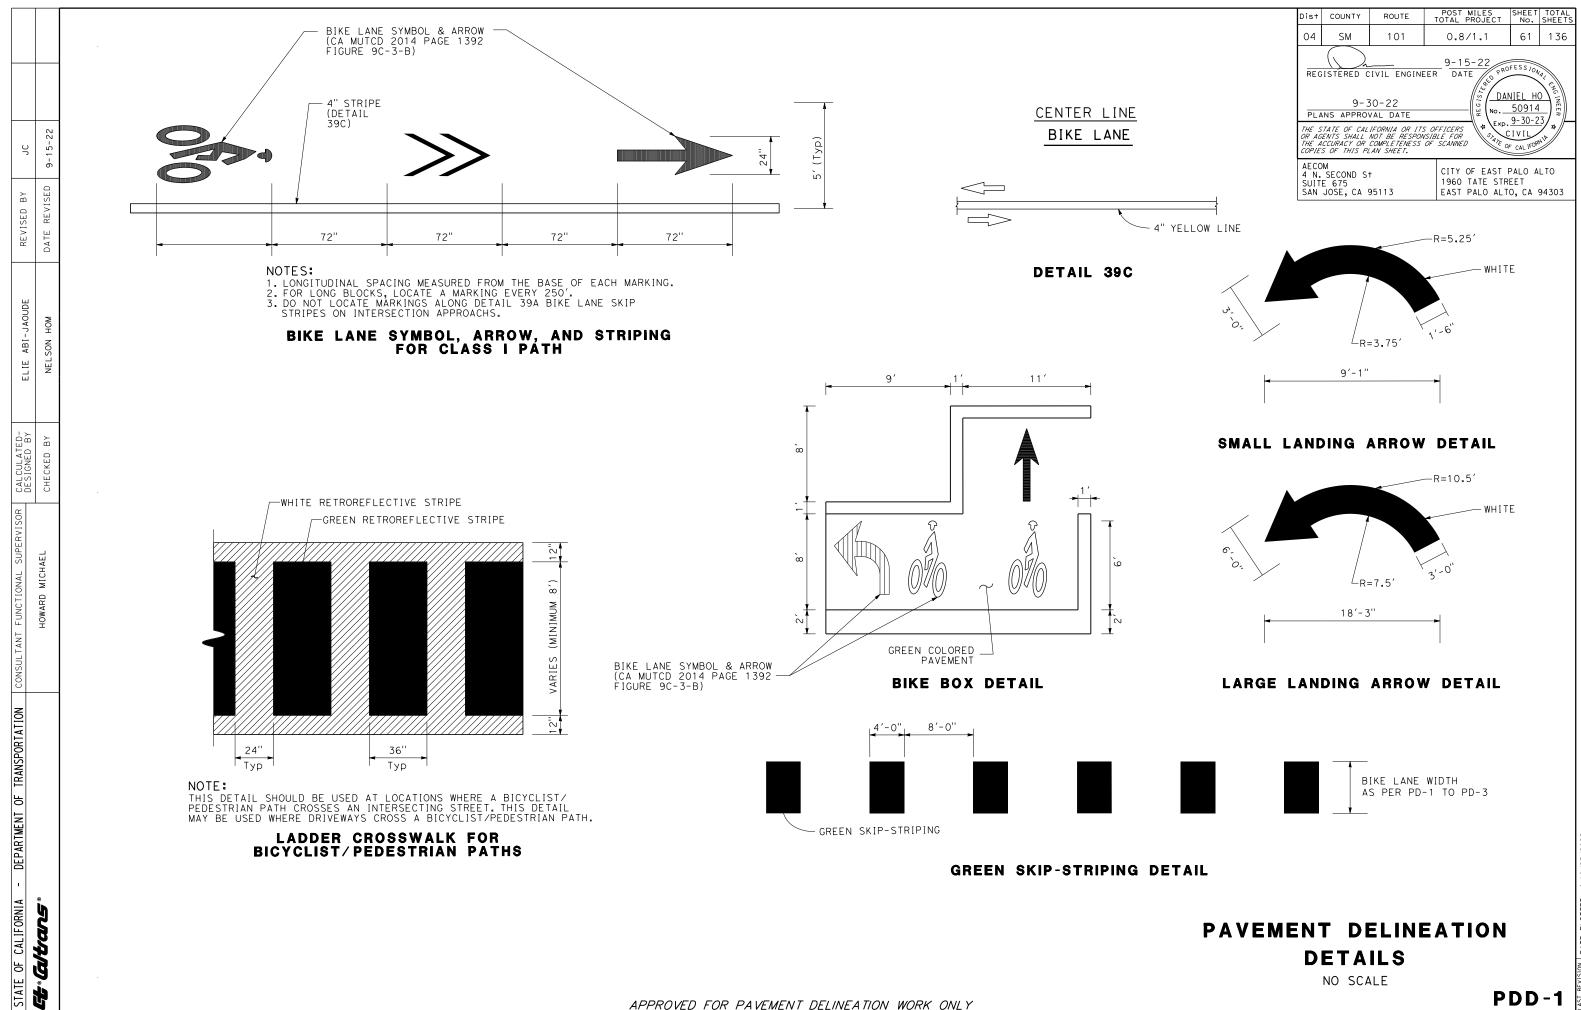

USERNAME => jose.corone! DGN FILE => 04000007591nb001.dgn

RELATIVE BORDER SCALE IS IN INCHES

UNIT 0703

PROJECT NUMBER & PHASE

DEPARTMENT OF TRANSPORTATION

CALIFORNIA

능

BORDER LAST REVISED 8/1/2016

POST MILES SHEET TOTAL TOTAL PROJECT No. SHEETS ist COUNTY 62 136 04 SM 0.8/1.1 DANIEL HO o.<u>50914</u> (Exp. 9-30-23) . CIVIL_ CITY OF EAST PALO ALTO

PAVEMENT DELINEATION QUANTITIES PDQ-1

USERNAME => jose.corone! 04000007591 UNIT 0703 PROJECT NUMBER & PHASE DGN FILE => 04000007591nc001.dgn


Dis+	COUNTY	ROUTE	POST MILES TOTAL PROJECT	SHEET No.	TOTAL SHEETS						
04	SM	101	0.8/1.1	63	136						
		IVIL ENGINE 30-22 VAL DATE	NO · ON PRE CISTER	NIEL HO 50914 9-30-2	S INEER						
THE STATE OF CALIFORNIA OR ITS OFFICERS OR AGENTS SHALL NOT BE RESPONSIBLE FOR THE ACCURACY OR COMPLETENESS OF SCANNED COPIES OF THIS PLAN SHEET.											
AECOM 4 N. SECOND S† CITY OF EAST PALO ALTO 1960 TATE STREET											


EAST PALO ALTO, CA 94303

	STATION LIMITS					Z	Р	AVEM	ENT M	ARKEI	7			THERI (ENHA	MOPLAS NCED V	STIC T WET NI	RAFFI [GHT \	C STR /ISIBII	IPE LITY)		THEDMOR	N ACTIC	BIKE LANE MARKING						
		Ш	DETAIL NO. OR PAVEMENT MARKING	DETAIL NO. OR PAVEMENT MARKING	DETAIL NO. OR PAVEMENT MARKING	DETAIL NO. OR PAVEMENT MARKING	DETAIL NO. OR PAVEMENT MARKING				_ <u>_</u>	RI	ETRO-	REFL	ECTIV	E	9	12A	22,25, 25A	27B	38 , 38B	39C	40	41	42	THERMOF PAVEN MARK	MENT		OBJECT MARKER
SHEET No.		SIDE						LENGT	TYPE C	TYPE D	TYPE G	TYPE R	TYPE RY	6" WHITE (BROKEN 17-7)	6" WHITE (BROKEN 18-12)	22,25, 25A XELLOW SOLID 1.5	6" WHITE SOLID	8" WHITE SOLID	4" YELLOW (SOLID)	6" WHITE (BROKEN 6-1)	6" YELLOW (BROKEN 6-1)	8" WHITE (BROKEN 18-12)	(ENHANC NIG VISIBI	ED WET HT	GREEN	(TYPE K)			
							EΑ			L	F	LF	LF	LF	LF	LF	LF	LF	EA [N]	SQFT	SQFT	EA							
		R†	38	927			42							927															
		R†	40	68												68													
		L+/R+	LIMIT LINE AT EXIT RAMP					66											1	66									
		R†	TYPE III (L) ARROW																1	42									
PD-2	SB Route 101 OFF-RAMP "R2" 78+60 TO "R2" 84+00	R†	TYPE III (R) ARROW																1	42									
		R†	TYPE III (L) ARROW																2	84									
		R†	TYPE III (R) ARROW																2	84									
		R†	TYPE III (L) ARROW																2	84									
		R†	TYPE III (R) ARROW																2	84									
		R†	TYPE III (L) ARROW																2	84									
		R†	TYPE III (R) ARROW																2	84									
		L†	9	300 290			8			300																			
		L†	27B	290									290																
PD-2	NB UNIVERSITY Ave	L†	38	425			19							425															
PD-2		L†	38A	162										162															
-0-3	"U" 26+10 TO "U"30+00	L+	CROSSWALK																1	1400	345								
		L†	TYPE III (R) ARROW																4	168									
		L†	LIMIT LINE	58															1	58									
		L†	BICYCLE/ARROW MARKING												1000				2	21	635								
PD-1-			39C	1,660											1660														
PD-1- PD-3	CLASS 1 FACILITY	L+/R+	SHARED PED/BICYCLE MARKING																8	84									
	CLASS 1 FACILITY "P" 11+20 TO "P"27+80	L+/R+	SLOW DOWN/15 MPH MARKING																4	40									
		L+/R+	LARGE ARROWS																2	120									
		L+/R+	SMALL ARROWS		407			4.0	067	7057	7500			4770		212	L	7774	2	30	4070								
			SHEET TOTAL OF PDQ-1 SHEET TOTAL OF PDQ-2	-		22				3053		6934		1776	1660	810		3771		4145 2575	1272	1							
				-	0	0	69	66	0	300	- 0	0	290	1514	1660	68	0	0		2515	980	0							
			GRAND TOTAL	<u> </u>	423	22	220	108	263	3353	7520	6934	6124	3290	1660	878	116	3771		6720	2252	1							


PAVEMENT DELINEATION QUANTITIES PDO

PDQ-2

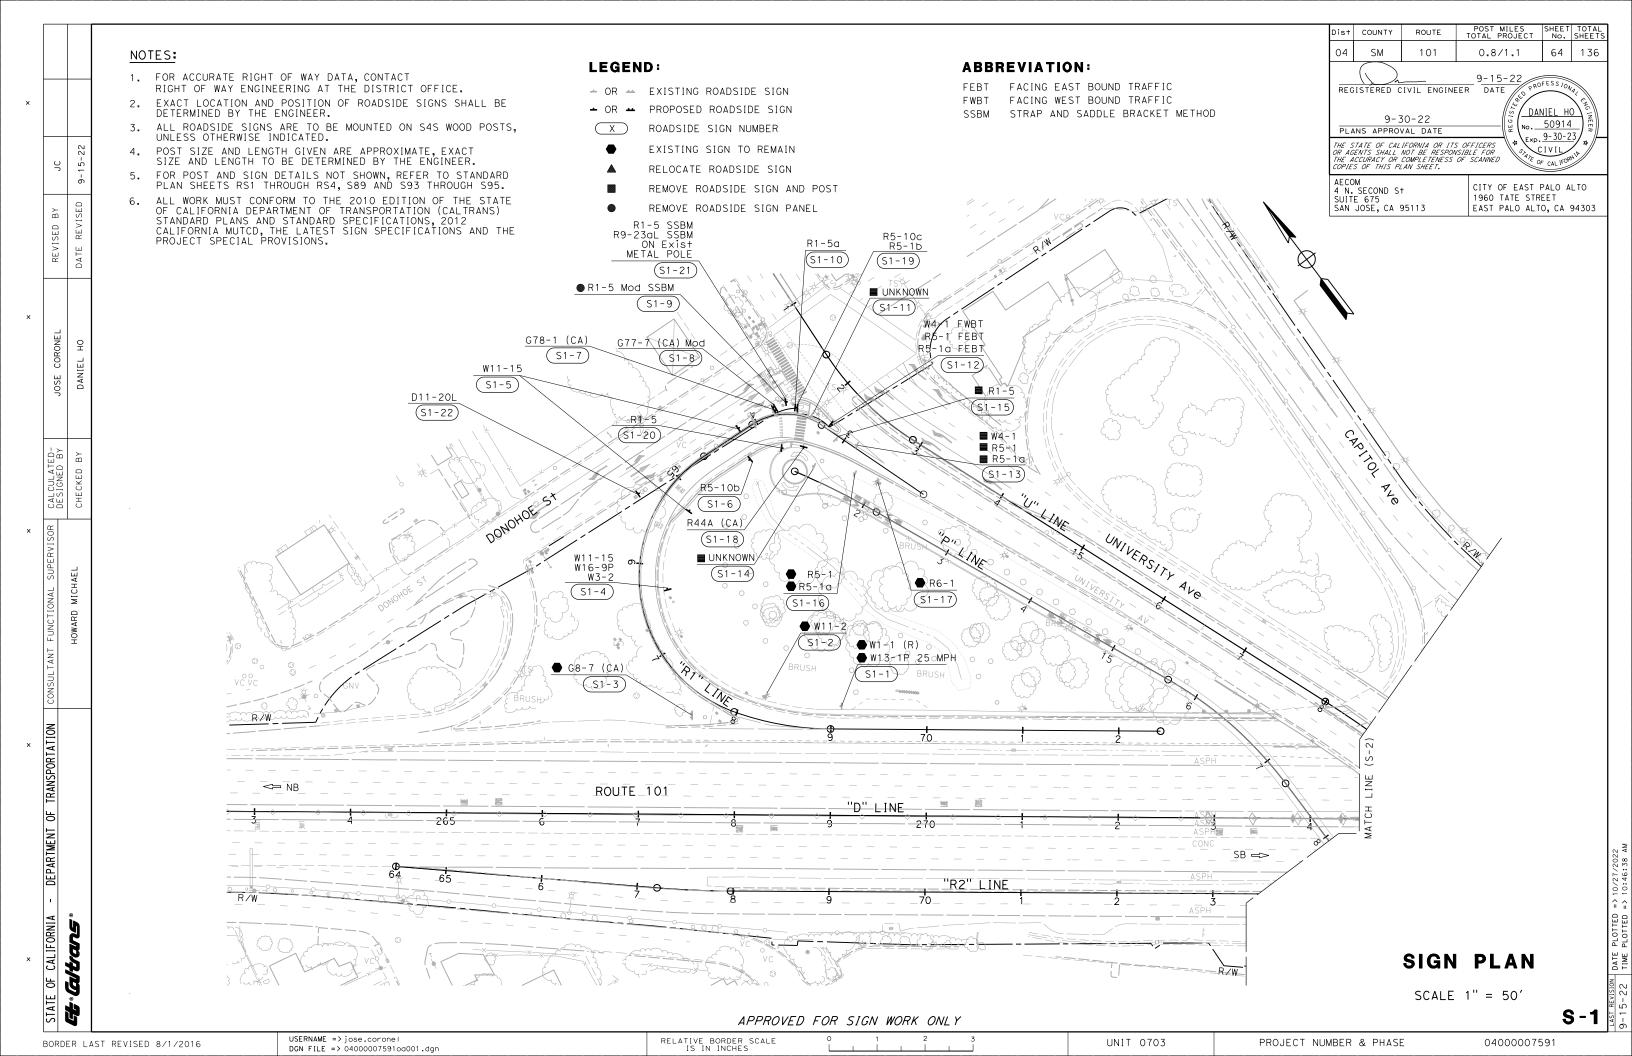

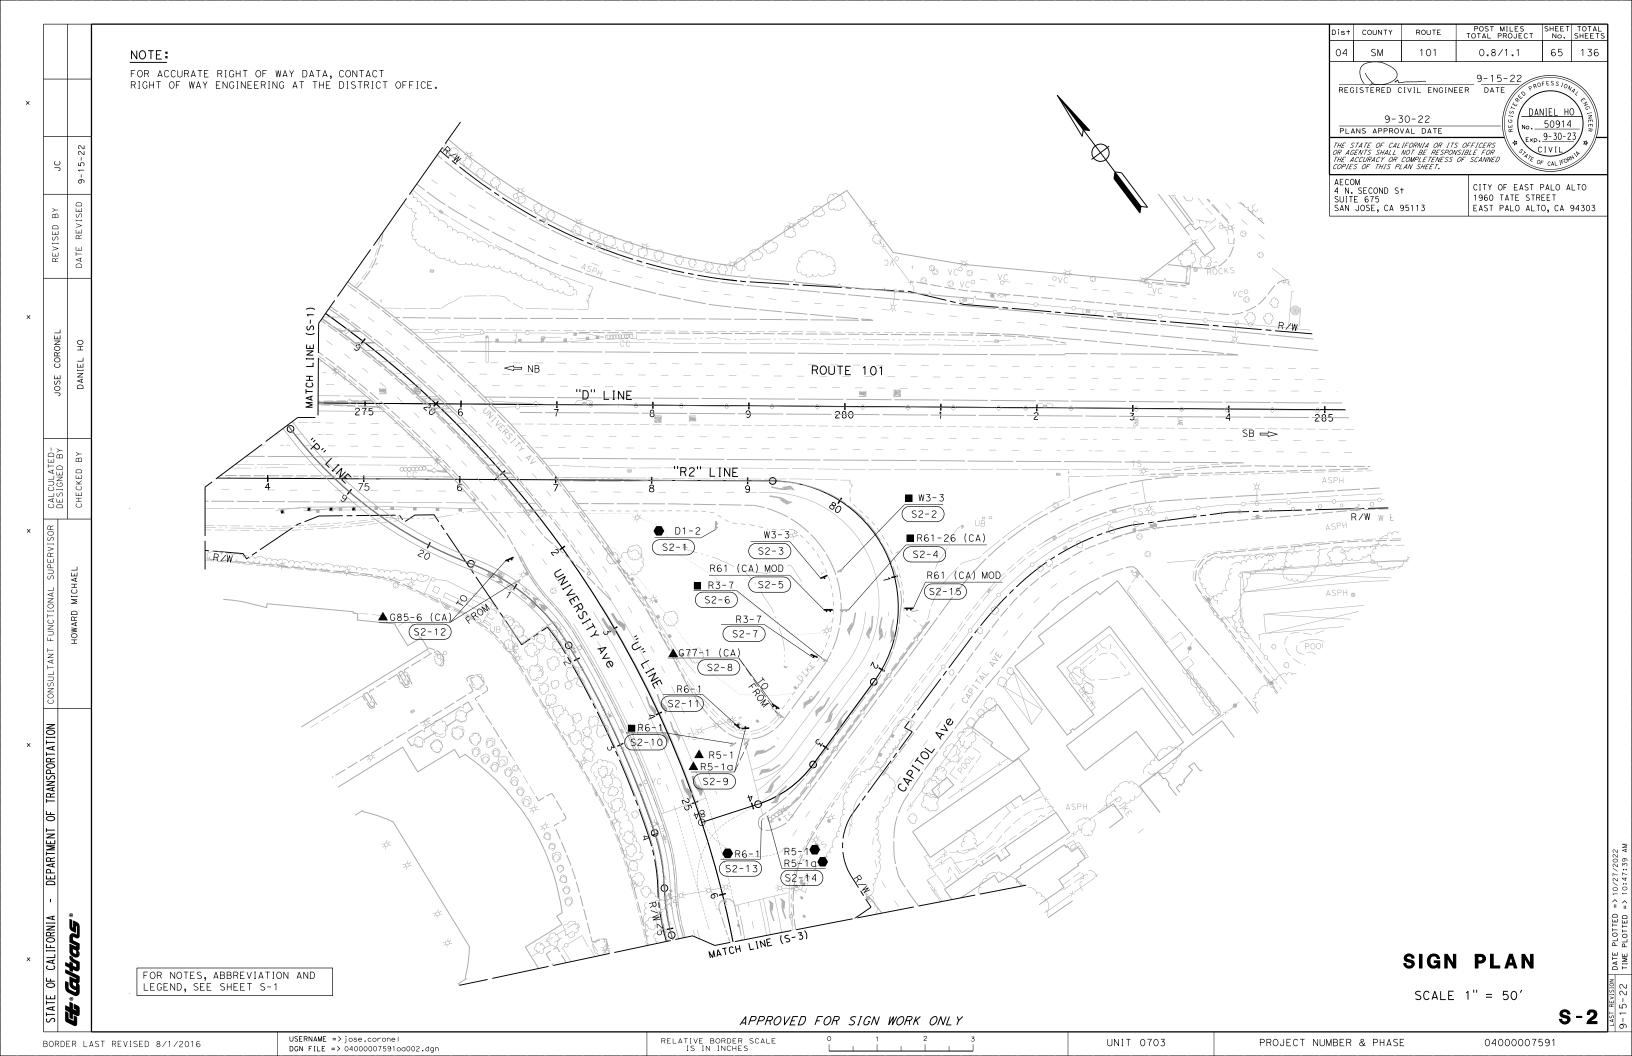

FOR ACCURATE RIGHT OF WAY DATA, CONTACT RIGHT OF WAY ENGINEERING AT THE DISTRICT OFFICE.

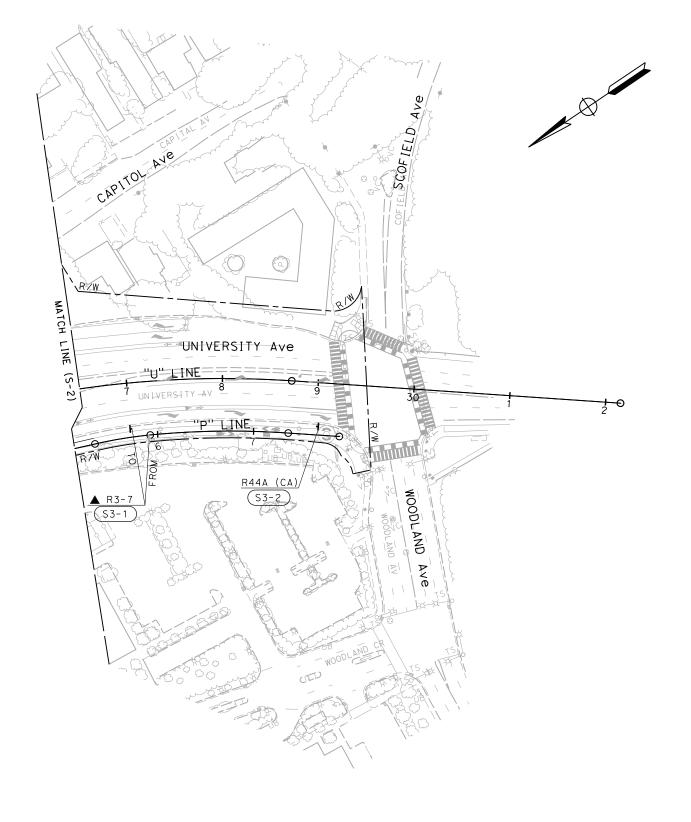

POST MILES SHEET TOTAL NO. SHEETS Dist COUNTY 04 66 136 SM 0.8/1.1 101 REGISTERED CIVIL ENGINEER 9-15-22

DATE //s DANIEL HO 9-30-22 PLANS APPROVAL DATE ю. 50914 Exp. 9-30-23 THE STATE OF CALIFORNIA OR ITS OFFICERS
OR AGENTS SHALL NOT BE RESPONSIBLE FOR
THE ACCURACY OR COMPLETENESS OF SCANNED
COPIES OF THIS PLAN SHEET. AECOM 4 N. SECOND S† SUITE 675 SAN JOSE, CA 95113 CITY OF EAST PALO ALTO 1960 TATE STREET EAST PALO ALTO, CA 94303

SIGN PLAN

SCALE 1" = 50'

S-3

APPROVED FOR SIGN WORK ONLY

USERNAME => jose.corone| DGN FILE => 040000075910a003.dgn


RELATIVE BORDER SCALE IS IN INCHES


UNIT 0703


PROJECT NUMBER & PHASE

04000007591

FOR NOTES, ABBREVIATION AND LEGEND, SEE SHEET S-1

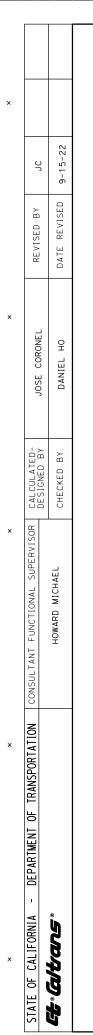


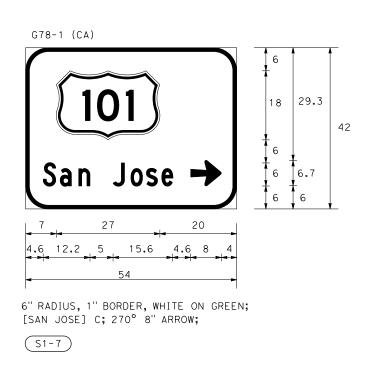

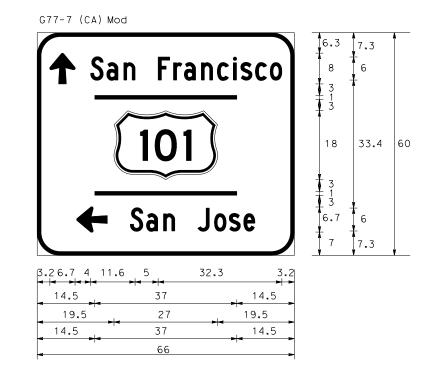

6" RADIUS, 1" BORDER, WHITE ON GREEN; 90° 8" ARROW; [SAN FRANCISCO] C (80% SPACING); 180° 8" ARROW; [SAN JOSE] C (80% SPACING);

(S1-8)

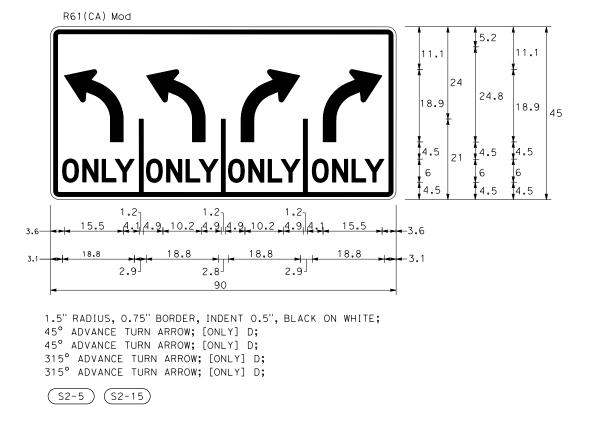

SIGN DETAILS

USERNAME => jose.corone! BORDER LAST REVISED 8/1/2016

DGN FILE => 04000007591ob001.dgn

RELATIVE BORDER SCALE IS IN INCHES

UNIT 0703

PROJECT NUMBER & PHASE

POST MILES SHEET TOTAL TOTAL PROJECT No. SHEETS

0.8/1.1

67

DANIEL HO

No. 50914

Exp. 9-30-23

CIVIL

CITY OF EAST PALO ALTO

1960 TATE STREET EAST PALO ALTO, CA 94303

136

Dist COUNTY

 SM

101

REGISTERED CIVIL ENGINEER DATE

THE STATE OF CALIFORNIA OR ITS OFFICERS OR AGENTS SHALL NOT BE RESPONSIBLE FOR THE ACCURACY OR COMPLETENESS OF SCANNED COPIES OF THIS PLAN SHEET.

9-30-22

PLANS APPROVAL DATE

AECOM 4 N. SECOND S† SUITE 675 SAN JOSE, CA 95113

04

SD-1

Dis	COUNTY	ROUTE	POST MILES TOTAL PROJECT	SHEET No.	TOTAL SHEETS
04	SM	101	0.8/1.1	68	136
PL THE OR A THE	9-3 ANS APPROV STATE OF CAL GENTS SHALL	IFORNIA OR ITS NOT BE RESPON COMPLETENESS	DAI S OFFICERS TO DAI NO. EXP.	VIEL HO 50914 9-30-2 CIVIL F CALIFORN	NEER NEER
SUI	OM . SECOND S TE 675 JOSE, CA S		CITY OF EAST 1960 TATE STR EAST PALO ALT	EET	

ROADSIDE SIGN QUANTITIES

NO.	SIGN No.	SIGN DESIGNATION	SIGN PANEL SIZE	" DIM FEET		POST SIZE ND LENGT		ROAD SI		INSTALL SIGN (SSBM)	REMOVE ROADSIDE SIGN	RELOCA	TE ROADSIDE SIGN	TREATED WOOD
SHEE	SIGN-No.			INC I	4"×4"	4"×6"	6"×6"	ONE POST	TWO POST	(330141)	31011	ONE POST	TWO POST	WASTE
"			L × D	1				Е	Ā	EA	EA		EΑ	LB
		W11-1	30" × 30"											
	S1-4	W16-9p	30" × 18"	7'			18.5′	1						
		W3-2	30" × 30"	1										
	S1-5	W11-15	30" × 30"	7′	12′			2						
	S1-6	R5-10b	30" × 18"	7′	11′			1						
	S1-7	G78-1(CA)	54" x 42"	- 7'			. = /							
	S1-8	G77-7(CA) Mod	66" × 60"	1 ′			15′		1					
	S1-9	R1-5 Mod									1			70
	S1-10	R1-5a	36" × 48"	7′		14′		1						
S-1	S1-11	UNKNOWN									1			70
		W4 - 1	36" × 36"											
	S1-12	R5-1	36" × 36"	5′		11′		1						
		R5-1a	42" × 30"	1										
		W4-1												
	S1-13	R5-1		1							1			70
		R5-1a		1										
	S1-14	UNKNOWN									1			70
	S1-15	R1-5									1			70
	S1-18	R44A (CA)	12" x 24"	7′	11.50′			1						
	C1 10	R5-1b	12" × 18"	7′	12'			1						
	S1-19	R5-10c	24" x 12"	1 '	'2			'						
	S1-20	R1-5	36" × 36"	7′		11′		1						
	S1-21	R1-5	36" × 36"	7′						2				
		R9-23aL	12" x 18"] '										
	S2-2	W3-3									1			70
	S2-3	W3-3	48" × 48"	7′	12.50′			1						
	S2-4	R61-26 (CA)									1			70
	S2-5	R61 (CA) Mod	90" × 45"	7′		13.50′			1					
	S2-6	R3-7									1			70
S-2	S2-7	R3-7	72" × 60"	7′	13.50′				1					
	S2-8	G77-1											1	
	S2-9	R5-1		1								1		
		R5-1a										<u>'</u>		
	S2-10	R6-1									1			70
	S2-11	R6-1	54" x 18"	7′	12'			1						
	S2-12	G85-6 (CA)				1							1	
	S2-15	R61 (CA) Mod	90" × 45"	7′		13.50′			1					
S-3	S3-1	R3-7	42" × 30"	5′		11′						1		
ــــــــــــــــــــــــــــــــــــــ	S3-2	R44A (CA)	12" x 24"	7′	11.50′			1						
							TOTAL	12	4	2	9	2	2	630

SIGN QUANTITIES

SQ-1

USERNAME => jose.corone| DGN FILE => 04000007591oc001.dgn

UNIT 0703

PROJECT NUMBER & PHASE

		р	oist COUNTY ROUTE	POST MILES SHEET TOTAL TOTAL PROJECT NO. SHEETS
			04 SM 101	0.8/1.1 69 136
			REGISTERED CIVIL ENG	INEER 9-15-22 PROFESSIONAL COLUMN COL
			9-30-22 PLANS APPROVAL DATE	Mo. 50914
20	15-22		THE STATE OF CALIFORNIA OR OR AGENTS SHALL NOT BE RES THE ACCURACY OR COMPLETENE COPIES OF THIS PLAN SHEET.	ITS OFFICERS PONSIBLE FOR SS OF SCANNED
	-6 d		AECOM 4 N. SECOND S† SUITE 675 SAN JOSE, CA 95113	CITY OF EAST PALO ALTO
REVISED BY	DATE REVISE		DAN JUSE, CA 95113	EAST PALO ALTO, CA 94303

SIGN PANEL MATERIAL QUANTITIES

							BACKGROUND		LEGEND	PROTECTIVE FILM
SHEET NO.	SIGN No.	SIGN DESIGNATION	PANEL SIZE	PANEL AREA	SINGLE FACED	DOUBLE FACED	SHEETING COLOR	TROREFLECTIVE ASTM TYPE	SHEETING COLOR	PREMIUM
			L×D	SQFT			SH	RE .	SH	
		W11-15	30" × 30"	6.25			FLUORESCENT YELLOW		BLACK	×
	S1-4	W16-9P	30" × 18"	3.75	×		YELLOW	ΧI	BLACK	×
		W3-2	30" × 30"	6.25	İ		YELLOW	ΧI	RED,WHITE,BLACK	×
	S1-5	W11-15	30" × 30"	6.25	×		FLUORESCENT YELLOW	ΧI	BLACK	×
	S1-6	R5-10b	30" x 18"	3.75		×	WHITE	ΧI	BLACK	×
	S1-7	G78-1 (CA)	54" × 42"	15.75		^	GREEN	ΧI	WHITE	X
	S1-8	G77-7 (CA) Mod	66" × 60"	27.5	×		GREEN	ΧI	WHITE	X
S-1	S1-10	R1-5a	36" × 48"	12	×		WHITE	ΧI	R,BLACK	X
3-1		W4-1	36" × 36"	9			YELLOW	ΧI	BLACK	×
	S1-12	R5-1	36" × 36"	9		×	WHITE, RED	ΧI	WHITE	×
		R5-1a	42" × 30"	8.75			WHITE, RED	ΧI	WHITE	×
	S1-18	R44A (CA)	12" × 24"	2	×		WHITE	ΧI	BLACK	×
	S1-19	R5-1b	12" × 18"	1.5	$\mid \times \mid$		WHITE	ΧI	BLACK	×
		R5-10c	24" × 12"	2			RED	ΧI	WHITE	×
	S1-20	R1-5	36" × 36"	9	×		WHITE	ΧI	BLACK,RED	X
	S1-21	R1-5	36" × 36"	9	×		WHITE	ΧI	BLACK,RED	X
		R9-23aL	12" x 18"	1.5	×		WHITE	ΧI	BLACK	X
	S1-22	D11-20L	12" x 18"	1.5	×		GREEN	ΧI	WHITE	X
	S2-3	W3-3	48" × 48"	16	×		YELLOW, BLACK	ΧI	RED, YELLOW, GREEN	×
S-2	S2-5	R61(CA) Mod	90" x 45"	28.1	×		WHITE	ΧI	BLACK	×
	S2-7	R3-7	72" × 60"	30	X		WHITE	ΧI	BLACK	×
	S2-11	R6-1	54" x 18"	6.75	×		BLACK	ΧI	WHITE, BLACK	×
	S2-15	R61(CA) Mod	90" x 45"	28.1	X		WHITE	ΧI	BLACK	×
S-3	S3-2	R44A (CA)	12" x 24"	2	×		WHITE	ΧI	BLACK	X
			TOTAL	245.7						

SIGN QUANTITIES

SQ-2

REMOVE CONCRETE

	STATION		REMOVE CONCRETE					
SHEET No.			CURB	SIDEWALK & ISLAND	CONCRETE BARRIER	DIKE		
			LF	SF	LF	LF		
	"R1" 65+45 TO "U" 11+82.18	R†	293	2136				
L-1	"R1" 65+45 TO "U" 12+96.44	L†	267					
	"U" 12+44.73 TO "U" 16+60	R†		2080				
L-1 - L-2	"D" 273+46.92 TO "D" 274+56.92	CL			110			
L-2	"R2" 80+62.89 TO "R2" 83+22.10	R+				202		
L-2 - L-3	"U" 21+80 TO "U" 29+61.61	R†	796	5220				
L-3	"U" 26+60 TO "U" 29+13	L†	530	1864		·		
L-3	"U" 28+68.08 TO "U" 29+43.83	L†	100	1240	·			
		TOTAL	1986	12,540	110	202		

EARTHWORK QUANTITIES SUMMARY

STATION	ROADWAY EXCAVATION TYPE (Z-2) (AERIALLY DEPOSITED LEAD)	EMBANKMENT (N)	IMPORTED BORROW
	CY	CY	CY
"P" 11+20 TO 15+06		9100	9100
"P" 20+46 TO 27+90	620		
"R1" 62+34 TO 65+45	415		
"R2" 79+02 TO 84+30	370		
TOTAL	1405	9100	9100

Dist	COUNTY	ROUTE	POST MILES TOTAL PROJECT	SHEET No.	TOTAL SHEETS				
04	SM	101	0.8/1.1	70	136				
PLA	PLANS APPROVAL DATE PS - 15 - 22 PLANS APPROVAL DATE PLANS PROVAL DATE PLANS APPROVAL DATE PLANS PROVAL								
OR AG	THE STATE OF CALIFORNIA OR ITS OFFICERS OR AGENTS SHALL NOT BE RESPONSIBLE FOR THE ACCURACY OR COMPLETENESS OF SCANNED COPIES OF THIS PLAN SHEET.								
AECOM 4 N. SECOND S† SUITE 675 SAN JOSE, CA 95113 CITY OF EAST PALO ALTO 1960 TATE STREET EAST PALO ALTO, CA 94303									

MINOR CONCRETE (MISCELLANEOUS CONSTRUCTION)

SHEET No.	STATION	SIDE	ISLAND & SIDEWALK	A2-6 CURB	B1-6 CURB	B2-6 CURB	TYPE E CURB	CURB RAMP (CASE A)	CURB RA (CASE F	CURB RAMP (CASE G)	ISLAND PASSAGEWAY	HMA DIKE (TYPE D)
		_	CY	CY	CY	CY	CY	EA	EA	EA	EA	LF
L-1	"R1" 65+45 TO "U" 11+82.18	L+/R+	7.2			16.2					1	
L-1	"R1" 65+45 TO "U" 12+96.44	L+		7.4					1			180
L-2	"R2" 79+59.03 TO "R2" 83+03.60	R+					9.9					225
L-2 - L-3	"U" 21+80 TO "U" 29+61.61	R+	14.6	35.0						2		
	"U" 26+60 TO "U" 29+13	L+/R+	9.5		14.6							
L-3	"U" 28+68.08 TO "U" 29+43.83	L+	10.0	7.2				1		1		
		TOTAL	41.3	49.6	14.6	16.2	9.9	1	1	3	1	405

ROADWAY QUANTITIES

SHEET No.	STATION		HOT MIX ASPHALT (TYPE A)	CLASS 2 AB
			TON	CY
I – 1	"R1" 65+45 TO "U" 13+07		535	83.1
L 1	"P" 11+20 TO "P" 15+06		240	61
L-2	"R2" 78+92 TO "R2" 84+30		599.4	137.5
1-2 - 13	"P" 20+46 TO "P" 27+90		320	82
L-2 - L3	"U" 21+80 TO "U" 29+62		33	6
L-3	"U" 26+60 TO "U" 29+20		174	31
٥-	"U" 28+68 TO "U" 29+44		6	1.5
		TOTAL	1907.4	402.1

REMOVE BASE AND SURFACING

SHEET No.	STATION	SIDE	REMOVE ASPHALT CONCRETE PAVEMENT CY
L-1	"R1" 65+45 TO "U" 12+96.31	L†/R†	215
L-2 - L-3	"U" 21+80 TO "U" 29+61.61	R†	264
	"U" 26+60 TO "U" 29+20	R†	1 4
L-3	"U" 28+68.08 TO "U" 29+43.83	L†	42
	"U" 29+50 TO "U" 30+15	R†	5
		TOTAL	540

TREATED WOOD WASTE

DESCRIPTION	LB
FROM MIDWEST GUARDRAIL SYSTEM	882
FROM ROADSIDE SIGN QUANTITES	630
TOTAL	1512

COLD PLANE ASPHALT CONCRETE PAVEMENT

SHEET No.	STATION	SIDE	AREA
JIILLI NO.	31411011	JIDL	SQYD
L-1	"R1" 65+45 TO "R1" 65+55	L+	17.5
	"R1" 62+24 TO "R1" 62+34	R†	12.5
L-2	"R2" 78+92 TO "R2" 79+05	R†	25.5
		TOTAL	55.5

CONCRETE BARRIER

SHEET No.	STATION	SIDE	TYPE 60R (Mod A)	TYPE 60R (Mod B)	TYPE MS
L-1 - L-2	"D" 273+57.00 TO "D" 274+47.00	CL	90		
L-2	"R2" 74+99.73 TO "R2" 75+25.85	R†		24	
L-2	"R2" 75+25.85 TO "R2" 76+21.22	R†			95
		TOTAL	90	24	95

DESCRIPTION	LB
FROM MIDWEST GUARDRAIL SYSTEM	882
FROM ROADSIDE SIGN QUANTITES	630
TOTAL	1512

IRRIGATION CONDUIT

SHEET NO. STATION	STATION	8" WELDED STEEL PIPE CONDUIT	2" PLASTIC PIPE (CLASS 315)	ELECTRICAL CONDUIT (CNC)	
			LF		
L-2	STA 81+00	112	124	124	

FENCE

SHEET No.	STATION	SIDE	TYPE CL-6, VINYL-CLAĎ - BLACK)	REMOVE CL FENCE
			LF	LF
L-1	"U" 12+06.45 TO "U" 15+89.45	R+	461	
L-2 - L-3	"U" 20+92.52 TO "U" 28+16.28	R+		530
		TOTAL	461	530

MIDWEST GUARDRAIL SYSTEM

SHEET No.	LOCATION	SIDE	GUARD RAILING LAYOUT	MIDWEST GUARDRAIL SYSTEM(STEEL POST)	TRANSITION RAILING (TYPE WB-31)	m ALTERNATIVE IN-LINE P TERMINAL SYSTEM	END CAP (TYPE A)	END CAP (TYPE TC)	END ANCHOR ASSEMBLY (TYPE SFT-m)	END ANCHOR BLOCK	WEGETATION CONTROL	규 REMOVE GUARDRAIL	TREATED WOOD WASTE
L-1	BENT 2	L†	12DD	75			1		1		46		
L-2	BENT 4	R†	12A	83	1	1		1	·	1	93	73	882
			TOTAL	158	1	1	1	1	1	2	139	73	882

SUMMARY OF QUANTITIES


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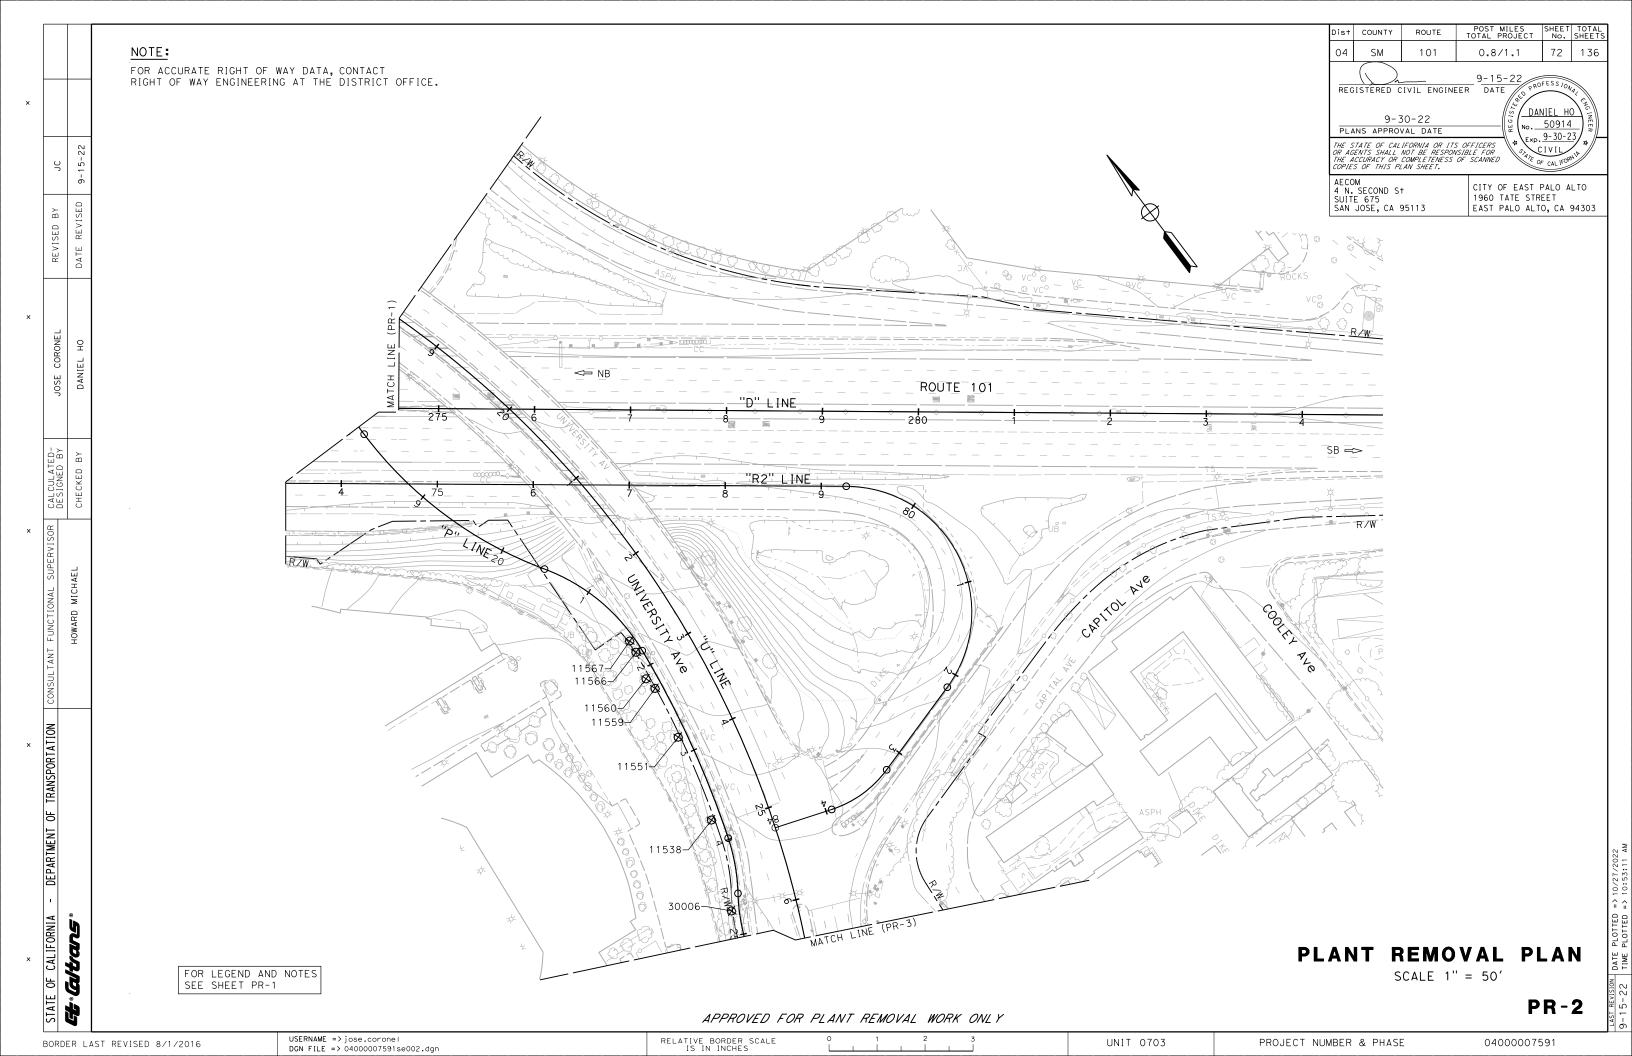
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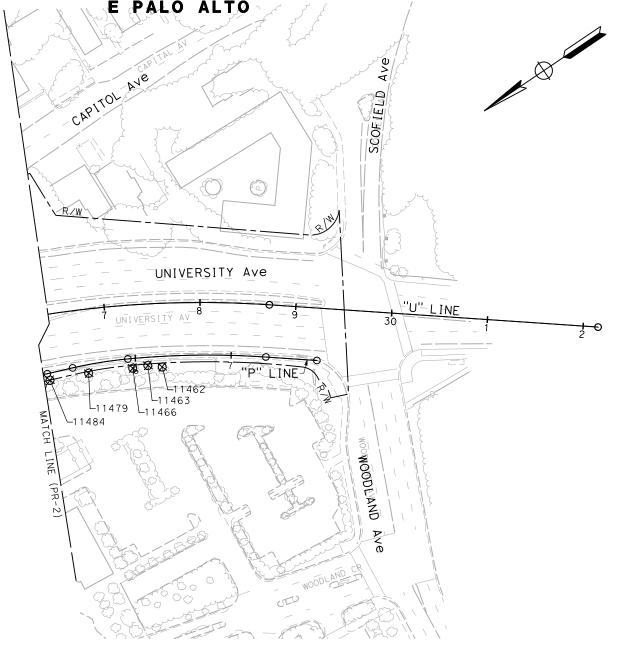
UNIT 0703

PROJECT NUMBER & PHASE





POST MILES SHEET TOTAL TOTAL PROJECT No. SHEETS Dist COUNTY 73 | 136 SM 101 0.8/1.1 REGISTERED CIVIL ENGINEER 9-15-22
DATE DANIEL HO 9-30-22 ю.<u>50914</u> PLANS APPROVAL DATE Exp. 9-30-23 THE STATE OF CALIFORNIA OR ITS OFFICERS
OR AGENTS SHALL NOT BE RESPONSIBLE FOR
THE ACCURACY OR COMPLETENESS OF SCANNED
COPIES OF THIS PLAN SHEET. AECOM 4 N. SECOND S† SUITE 675 SAN JOSE, CA 95113 CITY OF EAST PALO ALTO 1960 TATE STREET EAST PALO ALTO, CA 94303

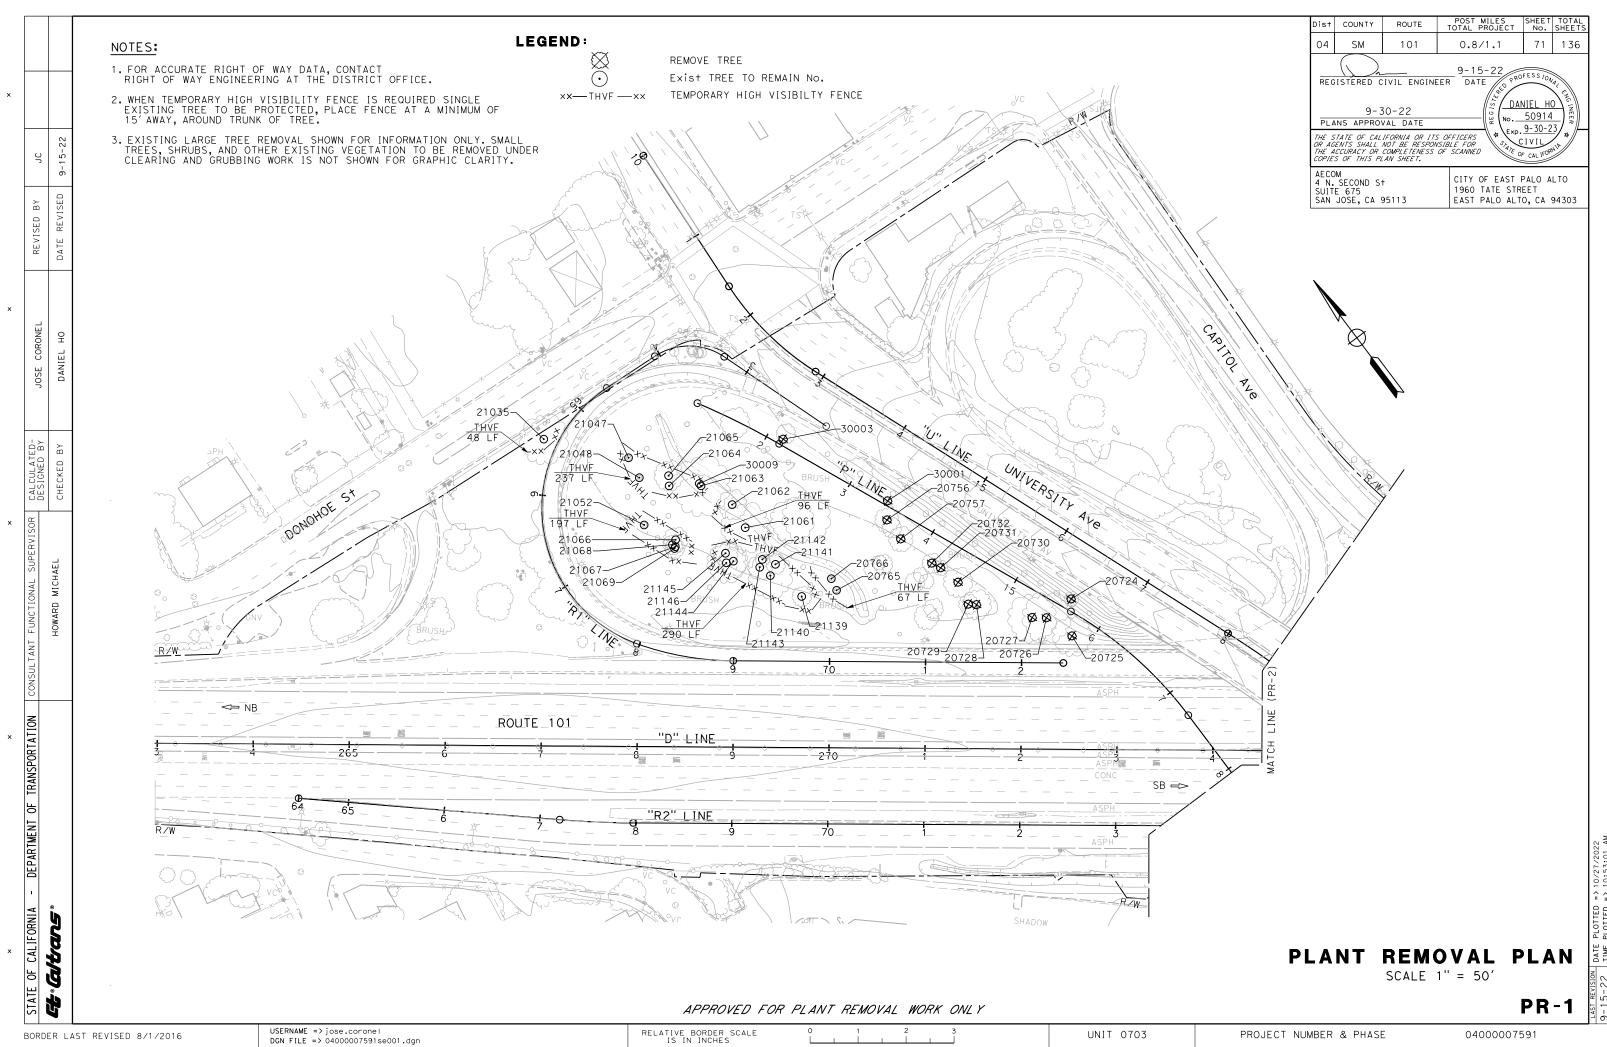

PLANT REMOVAL PLAN

SCALE 1" = 50'

PR-3

USERNAME => jose.corone| DGN FILE => 04000007591se003.dgn

RELATIVE BORDER SCALE IS IN INCHES

UNIT 0703

PROJECT NUMBER & PHASE

FOR LEGEND AND NOTES SEE SHEET PR-1

DEPARTMENT OF TRANSPORTATION | CONSULTANT

STATE OF CALIFORNIA **Gltans**

	Dist	COUNTY	ROUTE	POST MILES SHEET TOTAL TOTAL PROJECT NO. SHEET	
	04	SM	101	0.8/1.1 74 136	
	PLA THE S OR AG THE A	9-3 INS APPROV TATE OF CAL ENTS SHALL CCURACY OR	30-22 VAL DATE IFORNIA OR 113 NOT BE RESPON COMPLETENESS	DANIEL HO SOFFICERS SISBLE FOR DANIEL HO SOFFICERS CIVILIAN CIVILIAN	
O4 SM 101 0.8/1. REGISTERED CIVIL ENGINEER DATE 9-30-22 PLANS APPROVAL DATE THE STATE OF CALIFORNIA OR ITS OFFICERS OR ACCURACY OR COMPLETENESS OF SCANNED COPIES OF THIS PLAN SHEET. AECOM 4 N. SECOND S† SUITE 675 1960 TAT	CITY OF EAST PALO ALTO 1960 TATE STREET EAST PALO ALTO, CA 94303				

TREES TO BE REMOVED

Tree No.	DBH (inches)	COMMON NAME	NORTHING	EASTING
11462	18	REDWOOD	1993607.042	6085237.204
11463	18	REDWOOD	1993618.605	6085246.894
11466	15	REDWOOD	1993633.186	6085253.434
11479	22	COAST LIVE OAK	1993674.242	6085274.777
11484	23	COAST LIVE OAK	1993711.750	6085291.138
11538	13	COAST LIVE OAK	1993831.472	6085345.822
11551	6	JAPANESE FLOWERING CHERRY	1993921.293	6085370.119
11559	6	JAPANESE FLOWERING CHERRY	1993976.404	6085381.357
11560	6	JAPANESE FLOWERING CHERRY	1993990.044	6085379.908
11566	11	REDWOOD	1994018.474	6085388.161
11567	1 1	REDWOOD	1994031.791	6085389.902
20724	17, 13, 13	PERUVIAN PEPPER	1994620.528	6085274.123
20725	40	ASH	1994589.219	6085251.715
20726	27	RED OAK	1994620.303	6085241.832
20727	27	RED OAK	1994629.499	6085230.074
20728	30	REDWOOD	1994675.104	6085192.025
20729	20	REDWOOD	1994680.709	6085185.449
20730	37	REDWOOD	1994705.374	6085190.553
20731	17, 16	REDWOOD	1994728.290	6085185.109
20732	27	REDWOOD	1994737.687	6085180.692
20756	8, 8, 7, 6, 4	CHINESE PHOTINIA	1994801.708	6085170.460
20757	10, 8	CAMPHOR	1994777.310	6085170.019
30001	6, 5, 5, 5, 4, 4, 4, 4	BOX ELDER	1994817.183	6085182.944
30003	8	GINKO BILOBA	1994934.068	6085134.636
30006	1 4	COAST LIVE OAK	1993743.333	6085305.494

FENCE

SHEET No.	STATION	SIDE	TEMPORARY HIGH
PR-1	"U" 11+70.00 TO "U" 14+70.00	R†	935
		TOTAL	935

EXISTING TREES TO BE PROTECTED

Tree No.	DBH (inches)	COMMON NAME	NORTHING	EASTING
20765	4	NOT DETERMINED	1994774.861	6085084.614
20766	5	JAPANESE FLOWERING CHERRY	1994787.777	6085087.543
21035	46	COAST LIVE OAK	1995084.202	6084935.715
21047	4	NOT DETERMINED	1995015.499	6084994.425
21048	4	CHINESE PISTACHE	1994992.247	6084991.028
21052	4	NOT DETERMINED	1994949.877	6084965.450
21061	31	ASH	1994884.265	6085047.811
21062	20	COAST LIVE OAK	1994911.607	6085051.392
21063	27	RED OAK	1994946.763	6085037.264
21064	30	REDWOOD STUMP	1994966.737	6085010.657
21065	79	REDWOOD	1994975.574	6085016.644
21066	33	REDWOOD	1994917.852	6084982.242
21067	11	REDWOOD	1994912.261	6084977.751
21068	22	REDWOOD	1994915.713	6084976.547
21069	27	REDWOOD	1994911.254	6084975.900
21140	69	REDWOOD	1994828.594	6085038.707
21141	27, 24, 15	REDWOOD	1994834.791	6085050.007
21142	16,8	REDWOOD	1994847.110	6085042.128
21143	24, 15	REDWOOD	1994842.198	6085035.060
21144	34	REDWOOD	1994863.824	6085016.941
21145	24, 12, 6	REDWOOD	1994875.340	6085015.376
21146	29, 26, 18	REDWOOD	1994866.803	6085010.062
30009	21	BLACKWOOD ACACIA	1994949.763	6085037.264

PLANT REMOVAL PLAN

APPLICABLE WHERE CIRCLED (OR IN BRACKET)

NOTE:

DB

REVISED

STATE OF CALIFORNIA - DEPARTMENT OF TRANSPORTATION

1 INSTALL RISER ASSEMBLY (TYPE V) SPRINKLERS WITH EMITTERS ON THE UPHILL SIDE IF PLANT BASINS.

IRRIGATION SPRINKLER SCHEDULE

				1.1	TING	E (GPM)	(GPH)		(NPT INCH)		RISEF	RIAL		
SYMBOL	ТҮРЕ	DESCRIPTION	SPRAY PATTERN	OPERATING PRESSURE	PRESSURE COMPENSA	GALLONS PER MINUTE	GALLONS PER HOUR	MATERIAL	INLET CONNECTION (TYPE	PLASTIC	SIZE (IPS INCH)	IRRIGATION EMITTERS PER PLANT	REMARKS
0	C-2	TREE RISER SPRINKLER ASSEMBLY	F	20- 90	YES	0.25	15	PL	1/2''	٧	Х	1/2"	2 SPRINKLER RISER ASSEMBLIES PER PRUNUS SERRULATA 'KWANZAN' AND CERCIS OCCIDENTALIS	1)
\bigcirc	C-2	TREE RISER SPRINKLER ASSEMBLY	F	20- 90	YES	0.25	15	PL	1/2"	V	Х	1/2"	3 SPRINKLER RISER ASSEMBLIES FOR QUERCUS CHRYSOLEPIS, QUERCUS WISLIZENII, AND X CHITALPA TASHKENTENSIS 'PINK CLOUD'	1)
×	C-2	GROUNDCOVER RISER SPRINKLER ASSEMBLY	F	20- 90	YES	0.25	15	PL	1/2"	V	X	/ ₂ ''	1 SPRINKLER RISER ASSEMBLY PER PLANT	1)

PLASTIC PIPE SIZING (LATERAL)

		PIPE SIZE	GPM	No. OF SPRINKLERS (EA)
PIPE	4 40	1"	0-12	48
	SCH	1-1/2"	13-30	120
PLASTIC	315	2"	31-45	180
PL,	CL	2-1/2"	46-70	280
		SHEET TO	DTAL	628

Dist COUNTY 04 SM 101 0.8/1.1 75 136 REGISTERED LANDSCAPE ARCHITECT DATE 9-30-22 PLANS APPROVAL DATE THE STATE OF CALIFORNIA OR ITS OFFICERS OR AGENTS SHALL NOT BE RESPONSIBLE FOR THE ACCURACY OR COMPLETENESS OF SCANNED COPIES OF THIS PLAN SHEET. AECOM 4 N. Second St Suite 675 San Jose, CA 95113 CITY OF EAST PALO ALTO 1960 TATE STREET EAST PALO ALTO, CA 94303

IRRIGATION SPRINKLER **SCHEDULE**


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RELATIVE BORDER SCALE IS IN INCHES

UNIT 0703




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BORDER LAST REVISED 8/1/2016

UNIT 0703

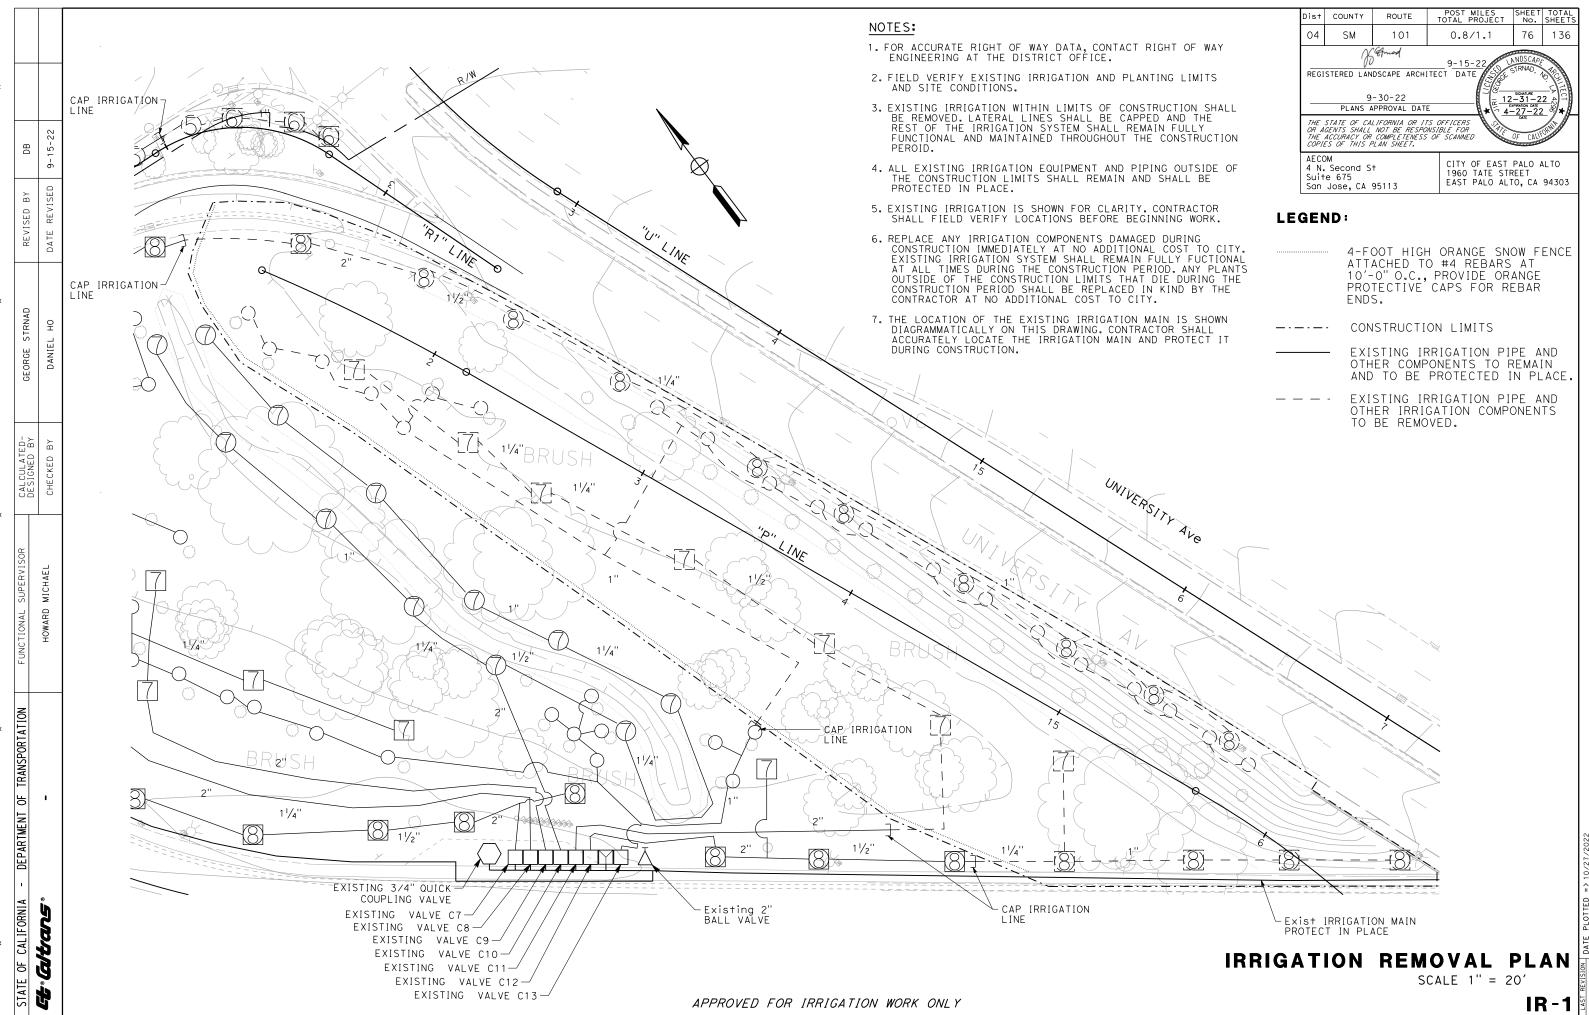

STATE OF CALIFORNIA - DEPARTMENT OF TRANSPORTATION

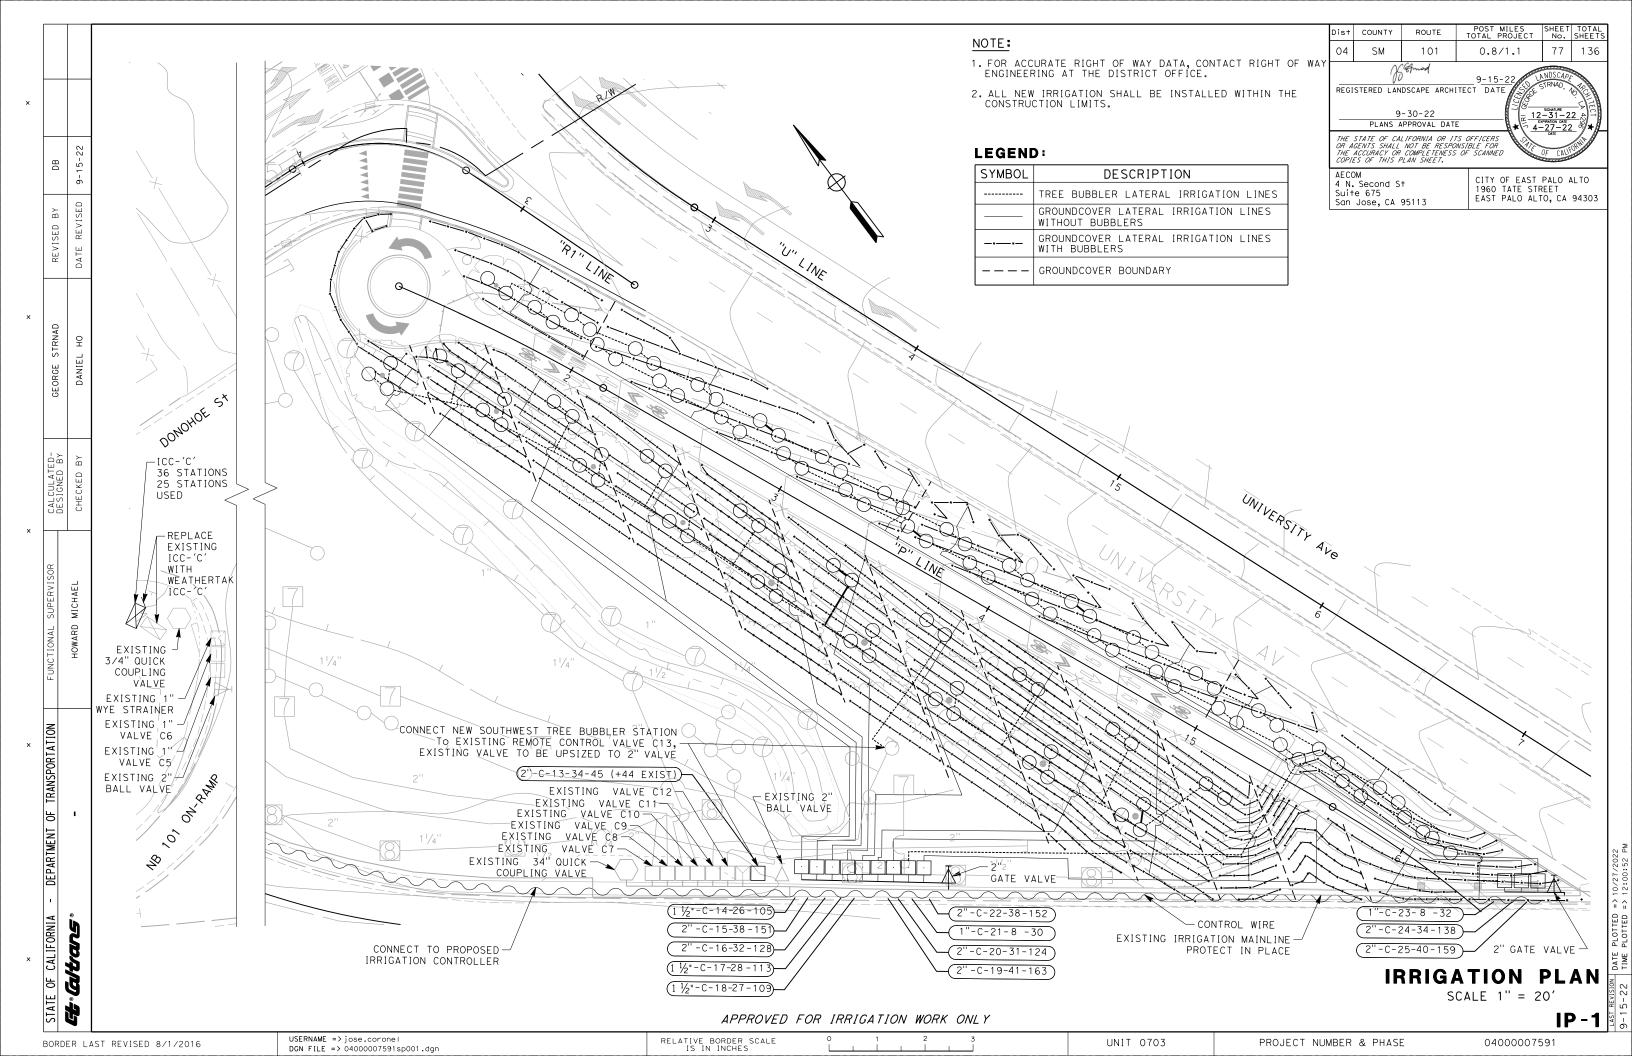IRRIGATION QUANTITY (LATERAL SIDE OF CONTROL VALVE)

		IR	RIGATION LIN			
	NUMBER	PLAST (SCHED (SUPPL	IC PIPE ULE 40) Y LINE)	PLASTIC PIPE (CLASS 315) (SUPPLY LINE)		SPRINKLER ASSEMBLY
SHEET	VALVE N	1"	1-1/2"	2"	CHECK	
SHE	VAL		L	F		EΑ
	C-13 (EXISTING)	802	-	-		45
	C-14	C-14 397 392 -			105	
	C-15	483	399	163		151
	C-16	202	304	131		128
	C-17	234	413	-		113
	C-18	272	454	-		109
IP-1	C-19	184	330	265		163
	C-20	226	345	142		124
	C-21	618	_	-		30
	C-22	487	280	145		152
	C-23	503	-	-		32
	C-24	1 , 052	351	51		138
	C-25	1,328	95	86		159
SHE	ET TOTAL	5,460	3,363	983		1,449

IRRIGATION QUANTITY (MAIN SUPPLY SIDE OF CONTROL VALVE)

SHEET		PLASTIC PIPE (CLASS 315) (SUPPLY LINE)			GATE VALVE			REMOTE CONTROL VALVE			
	2"	2-1/2"	3''	2''	2-1/2"	3''	1''	1-1/2"	2''		
	LF				EΑ			EA			
IP-1	65			2	-	-	2	3	8		
SHEET TOTAL	65	_	ı	2	-	_	2	3	8		

POST MILES SHEET TOTAL TOTAL PROJECT No. SHEETS Dist COUNTY 04 SM 101 0.8/1.1 78 136 REGISTERED LANDSCAPE ARCHITECT DATE 9-30-22 PLANS APPROVAL DATE THE STATE OF CALIFORNIA OR ITS OFFICERS OR AGENTS SHALL NOT BE RESPONSIBLE FOR THE ACCURACY OR COMPLETENESS OF SCANNED COPIES OF THIS PLAN SHEET.

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CITY OF EAST PALO ALTO 1960 TATE STREET EAST PALO ALTO, CA 94303

IRRIGATION QUANTITIES


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04	SM	101	0.8/1.1	79	136				
	X	Amod	9-15-22	NDSCAP					
REGI	REGISTERED LANDSCAPE ARCHITECT DATE								
		-30-22 APPROVAL DAT	- N 16 - E	SIGNATURE 1-31-2 XPIRATION DATE 1-27-22	<u></u> 21 N				
OR A	GENTS SHALL	LIFORNIA OR II NOT BE RESPO COMPLETENESS PLAN SHEET.	TS OFFICERS SANSIBLE FOR	OF CALL					

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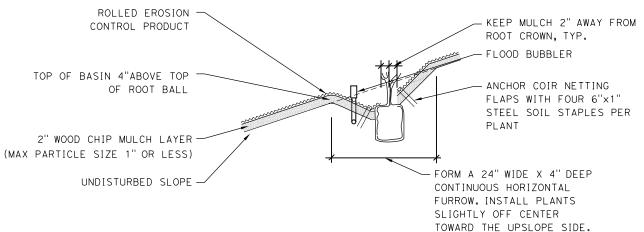
4 N. Second St Suite 675 San Jose, CA 95113 CITY OF EAST PALO ALTO 1960 TATE STREET EAST PALO ALTO, CA 94303

POST MILES SHEET TOTAL TOTAL PROJECT No. SHEETS



GROUNDCOVER PLANTING

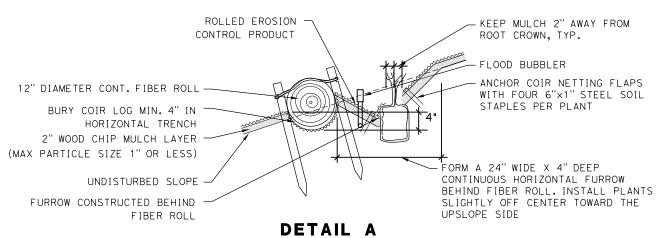FURROW AT FIBER ROLL



DETAIL B GROUNDCOVER PLANTING FURROW

PLANT LEGEND

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UNIT 0703

PROJECT NUMBER & PHASE


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BORDER LAST REVISED 8/1/2016

DEPARTMENT

CALIFORNIA

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APPLICABLE WHERE CIRCLED (OR IN BRACKET)

① BASIN MULCH IS INCLUDED WITH MULCH QUANTITES SHOWN ON PLANTING PLAN

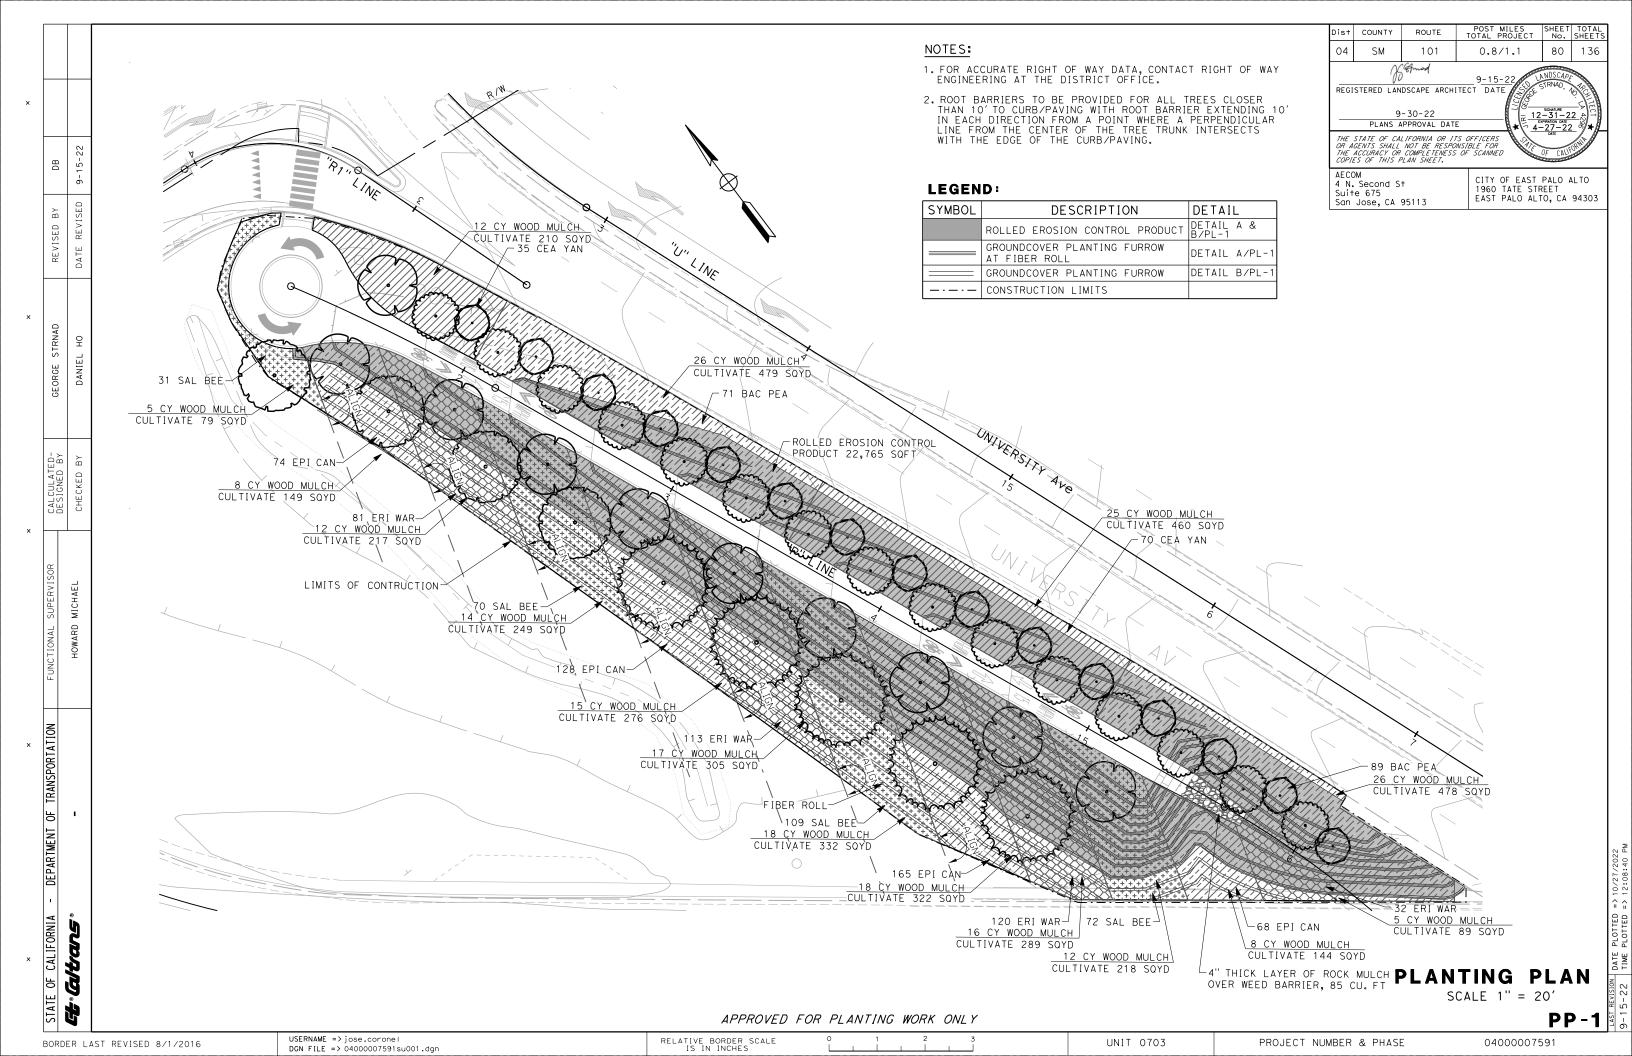Dis+	COUNTY	ROUTE	POST MILES TOTAL PROJECT	SHEET No.	TOTAL SHEETS
04	SM	101	0.8/1.1	81	136
THE . OR A. THE .	9 PLANS A STATE OF CA GENTS SHALL	DSCAPE ARCHI -30-22 PPROVAL DATE LIFORNIA OR IT NOT BE RESPO. COMPLETENES PLAN SHEET.	TECT DATE THE TECT D	NDS CAPA STRNAD, SIGNATURE 2-31-2 EXPRATION DATE -27-22 DATE	2 4288 ★
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AECOM 4 N. Second St Suite 675 San Jose, CA 95113 CITY OF EAST PALO ALTO 1960 TATE STREET EAST PALO ALTO, CA 94303

PLANT QUANTITIES

			ANT DUP	PL/ BA	ANT SIN				_	TOR	
BOTANICAL NAME	COMMON NAME	А	U	WOOD MULCH (2")	SOIL AMENDMENT	PACKET FERTILIZER	SLOW RELEASE FERTILIZER (Pi+ Es+)	ROCK MULCH	WEED GERMINATION	FOLIAGE PROTECTO (TREE STAKING)	ROOT BARRIER
		ΕA	ΕA	CY	CY	EA	Lb	SQFT	SQYD	EΑ	LF
BACCHARIS PILULARIS 'Twin Peaks'	PIGEON POINT COYOTE BRUSH	160	-	1	6	160	40.0				
CEANOTHUS GRISEUS HORIZONTALIS 'Yankee Point'	CARMEL MOUNTAIN LILAC	105	-	1	4	105	26.3				
EPILOBIUM CANUM 'Calistoga'	CALIFORNIA FUCHSIA	436	-	1	16	4 36	109.0				
ERIOGONUM FASCICULATUM 'Warriner Lytle'	WARRINER LYTLE BUCKWHEAT	346	-	1)	13	-	-				
SALVIA X 'Bee's Bliss'	BEE'S BLISS SAGE	292	-	1	1	-	-				
CERCIS OCCIDENTALIS	WESTERN REDBUD	-	15	1	5	120	3.8	260	4,296	49	452
PRUNUS SERRULATA 'Kwanzan'	KWANZAN JAPANESE FLOWERING CHERRY	-	15	1	5	120	3.8				
QUERCUS CHRYSOLEPIS	CANYON LIVE OAK	-	4	1	1	32	1.0				
QUERCUS WISLIZENII	INTERIOR LIVE OAK	-	5	1	1	40	1.3				
X CHITALPA TASHKENTENSIS 'Pink Cloud'	PINK CLOUD CHITALPA	-	10	1	3	80	2.5				
	SHEET TOTAL	1,339	49	237	55	1,093	187.7	260	4,296	49	452

PLANT QUANTITES

PQ-1 1-6

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UNIT 0703

PROJECT NUMBER & PHASE

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STATE OF CALIFORNIA -BORDER LAST REVISED 8/1/2016

- DEPARTMENT OF TRANSPORTATION

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REVISED BY	DATE REVISED	
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EROSION CONTROL TYPE 1

SYMBOL	SEQUENCE	ITEM	MATER	IAL	APPLICATION	DEPTH	REMARKS
3 I MIDUL	SEQUENCE	I I ⊏ IVI	DESCRIPTION	TYPE	RATE	DEFIN	REMARKS
	STEP 1	WOOD CHIPS	WOOD CHIPS	FINE PARTICLES 1" OR LESS	270 CY/AC	2"	
	STEP 2	ROLLED EROSION CONTROL PRODUCT (NETTING)	NETTING	TYPE C			
	STEP 3	FIBER ROLLS	FIBER ROLL	BioD-Wa+I (12" x 10') COIR WATTLES	AS SHOWN ON PLANS		

EROSION CONTROL TYPE 2

CEOUENCE	ITEM	MATER	IAL	APPLICATION	DEDTH
SEQUENCE	ITEM	DESCRIPTION	TYPE	RATE	DEPTH
STEP 1	COMPOST	COMPOST	FINE	135 CY/ACRE	1''
STEP 2	ROLLED EROSION CONTROL PRODUCT (NETTING)	NETTING	TYPE A		
		SEED	MIX 1	42.3 LB/ACRE	
STEP 3	HYDROSEED	FIBER	WOOD	500 LB/ACRE	
		FERTILIZER	ORGANIC	500 LB/ACRE	
CTED 4	HYDROMUL CH	FIBER	WOOD	1,500 LB/ACRE	
STEP 4	HIDROMULCH	TACKIFIER	GUAR (PLANT BASED)	70 LB/ACRE	

EROSION CONTROL TYPE 3

SEQUENCE	ITEM	MATERIA	.L	APPLICATION	DEPTH
SEQUENCE	I I ⊏ IVI	DESCRIPTION	TYPE	RATE	DEFIR
STEP 1	COMPOST	COMPOST	MEDIUM	135 CY/ACRE	1"
STEP 2		SEED	MIX 1	42.3 LB/ACRE	
	HYDROSEED	FIBER	WOOD	500 LB/ACRE	
		FERTILIZER	ORGANIC	500 LB/ACRE	
STEP 3	HYDROMULCH	FIBER	WOOD	1,500 LB/ACRE	
JILF J	TITUROMOLCH	TACKIFIER	GUAR	125 LB/ACRE	

Dist	COUNTY	ROUTE	POST MILES TOTAL PROJECT	SHEET No.	TOTAL SHEETS
04	SM	101	0.8/1.1	82	136
PLA THE S OR AG THE A	9-3 INS APPROVI TATE OF CAL SENTS SHALL	IFORNIA OR ITS NOT BE RESPON COMPLETENESS	DAI No	NIEL HO 50914 9-30-2 IVIL	ENG INEER
SUIT	M SECOND S- E 675 JOSE, CA S		CITY OF EAST I 1960 TATE STR EAST PALO ALT	EET	

SEED MIX

		OLLD MIX			
SEED	BOTANICAL NAME (COMMON NAME)	PERCENT GERMINATION (MINIMUM)	POUNDS PURE LIVE SEED PER ACRE (SLOPE MEASUREMENT)		
	LIPINUS BICOLOR (ANNUAL LUPINE)	50	5		
	BROMUS CARINATUS 1 (CALIFORNIA BROME)	60	9		
	ESCHSCHOLZIA CALIFORNICA (CALIFORNIA POPPY)	60	3		
←	FESTUCA MICROSTACHYS (THREE-WEEK FESCUE)	60	4		
MIX	FESTUCA RUBRA VAR MOLATE (MOLATE RED FESCUE)	60	8		
	HORDEUM BRACHYANTHERUM (CALIFORNIA MEADOW BARLEY)	60	11		
	KOELERIA MACRANTHA (JUNEGRASS)	50	2		
	SYMPHYOTRICHUM CHILENSE (PACIFIC ASTER)	40	0.2		
	ACHILLEA MILLEFOLIUM (YARROW)	60	0.1		

FIBER ROLLS

SEQUENCE	ITEM	MATE	RIAL	REMARKS
SEQUENCE	ITEM	DESCRIPTION	TYPE	REMARKS
IN EC TYPES 2 AREAS FIBER ROLLS MUST BE INSTALLED AFTER RECP	FIBER ROLLS	RICE STRAW FILLED, JUTE COVERED	8" TO 10" Dia	TYPE 2 FIBER ROLLS INSTALLATION


EROSION CONTROL LEGEND


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UNIT 0703

PROJECT NUMBER & PHASE



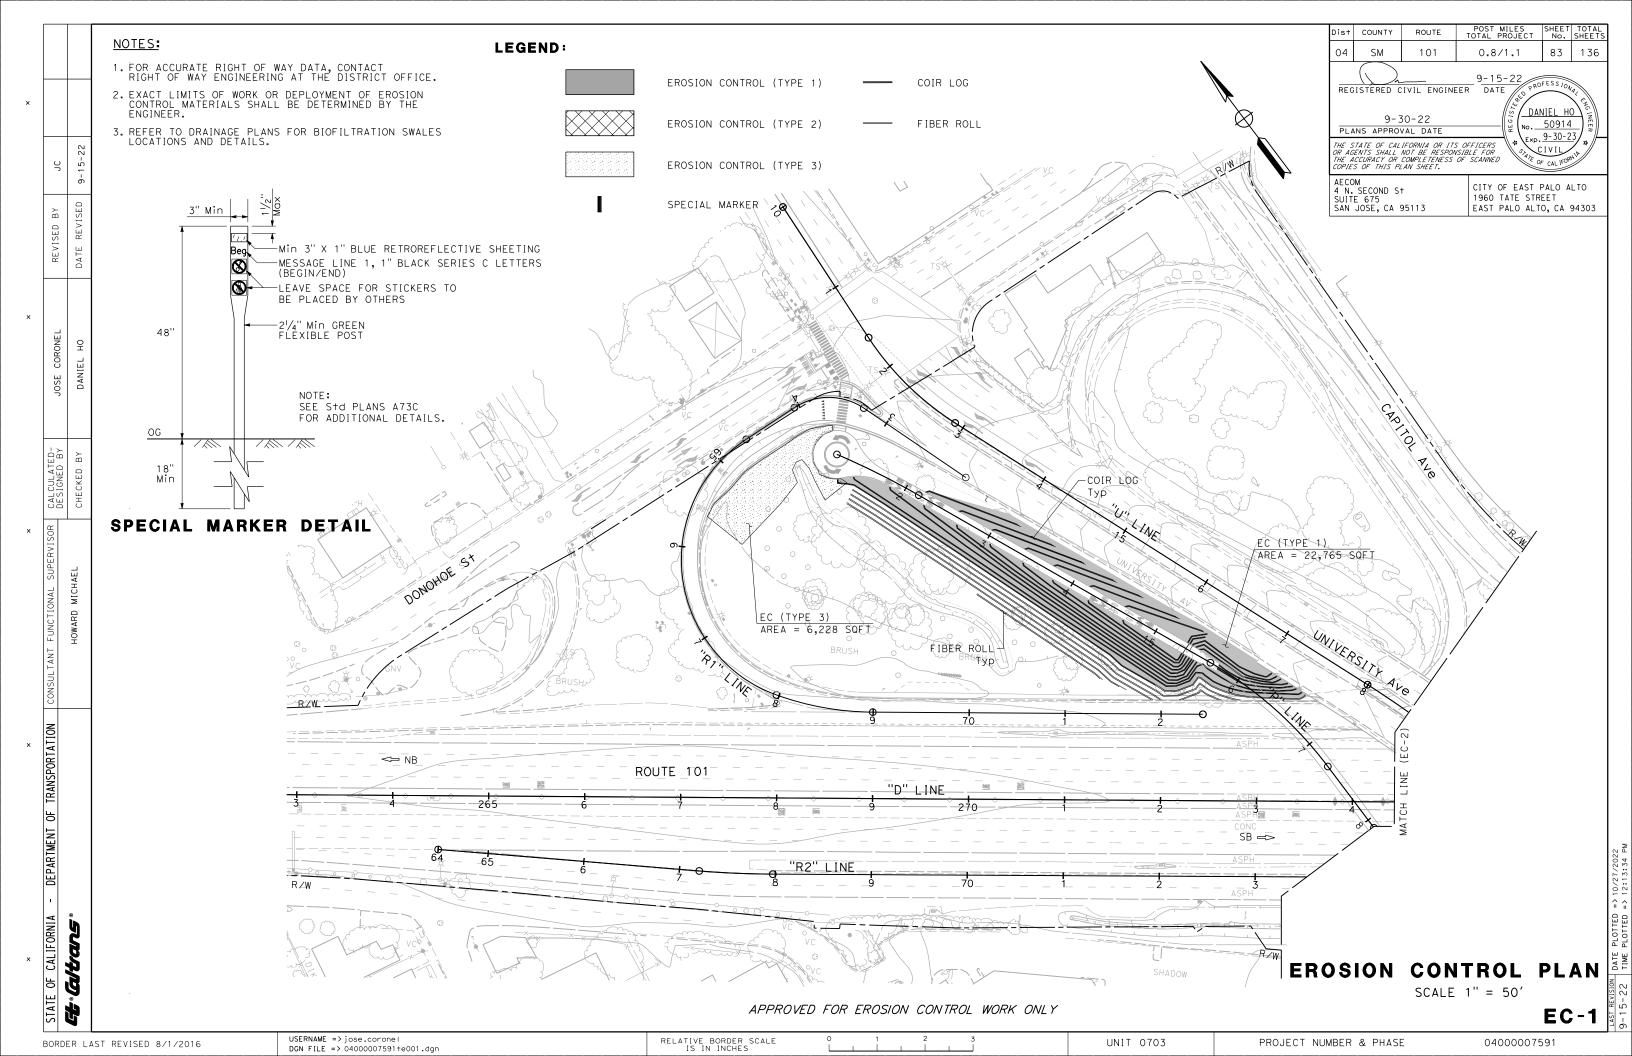

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OF CALIFORNIA - DEPARTMENT OF TRANSPORTATION	CONSULTANT FUNCTIONAL SUPERVISOR	CALCULATED-	- DINCOOUT	REVISED BY	٦		
		DESIGNED BY	JOSE CONOINEL		ر د		
altans	HOWARD MICHAEL	CHECKED BY	DANIEL HO	DATE REVISED	9-15-22		
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×	×		×			Κ	
PORTATION	CONSULTANT FUNCTIONAL SUPERVISOR	CALCULATED-		REVISED BY	٢		
		DESIGNED BY	JOSE COLONEL		ر د		
	HOWARD MICHAEL	CHECKED BY	DANIEL HO	DATE REVISED	9-15-22		

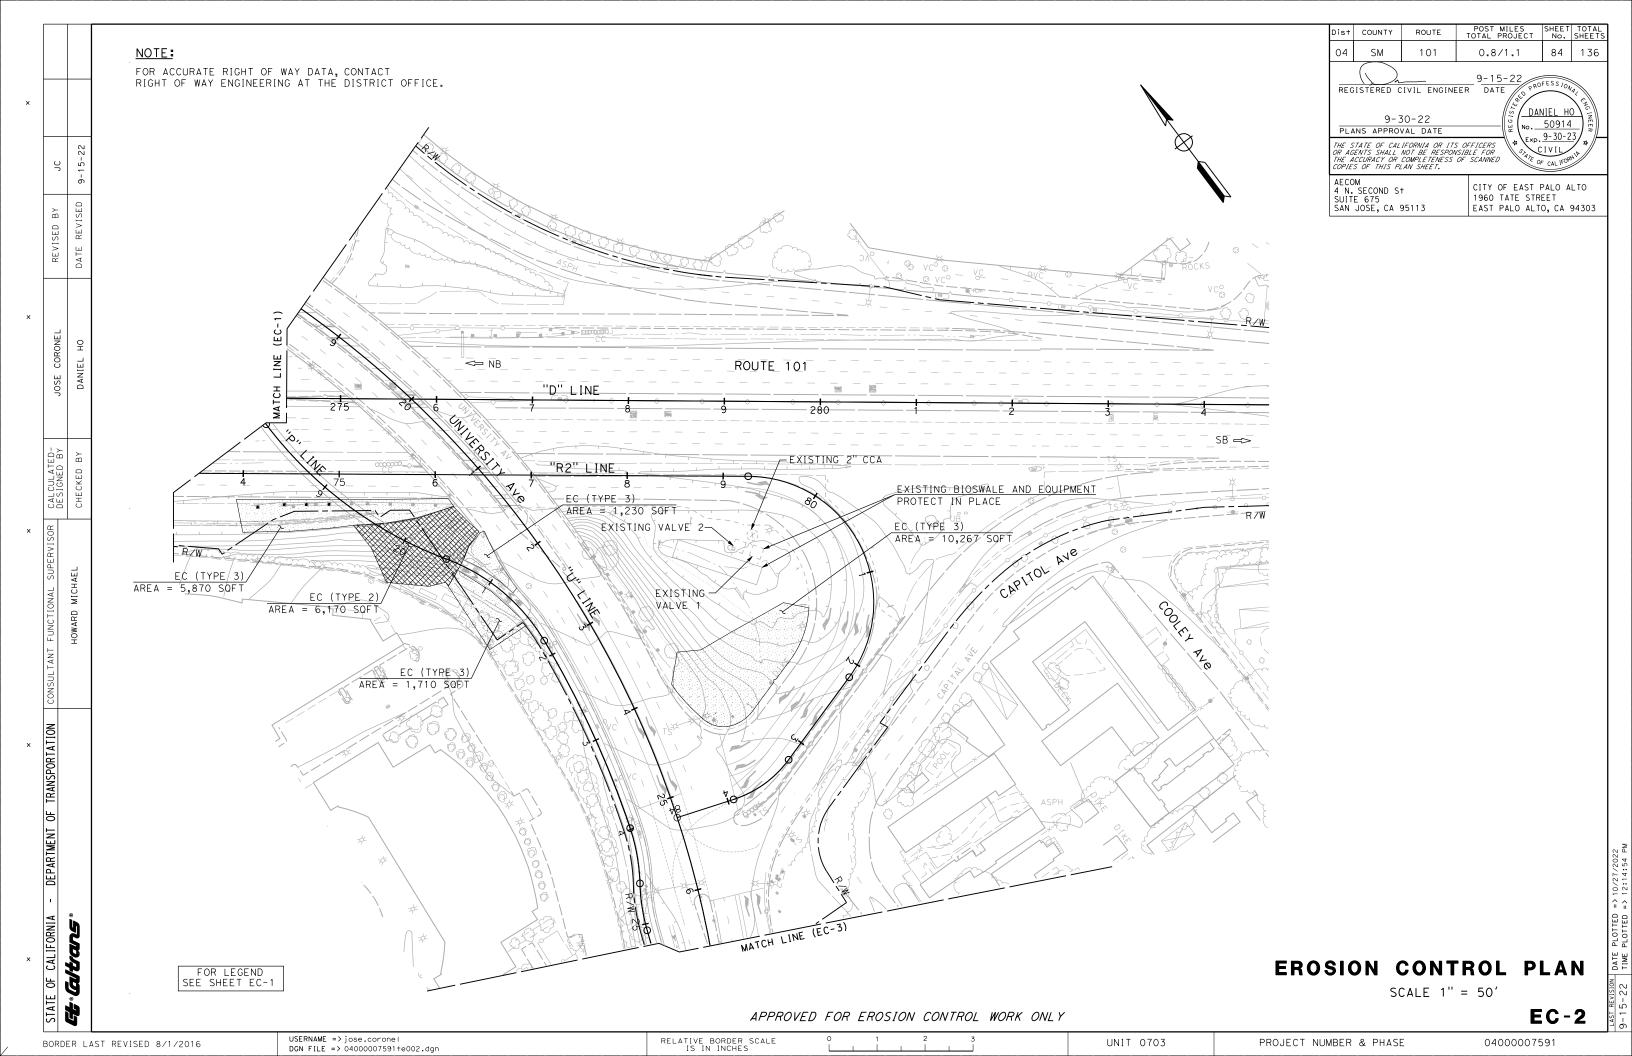RNAME => jose.coronel FILE => 04000007591+g001.dgn	RELATIVE BORDER SCALE IS IN INCHES	0 1 2 3	UNIT 0703	PROJECT NUMBER & PHASE	040000075

Dist	COUNTY	ROUTE		POST MILES	SHEET	TOTAL
DIST	COUNTY	ROUTE	Т	OTAL PROJECT	No.	SHEETS
04	SM	101		0.8/1.1	85	136
PLA THE S OR AG THE A	9-3 ANS APPROV TATE OF CAL SENTS SHALL	IFORNIA OR ITS NOT BE RESPON COMPLETENESS	S OF VS1Bi	FICERS PACE	NIEL HO 50914 9-30-2 CIVIL OF CALIFOR	CNC INEER
			_		_	
SUIT	SECOND SE			CITY OF EAST 1960 TATE STE EAST PALO ALT	REET	

EROSION CONTROL QUANTITIES

		ION DUCT							Н	YDROSE (N)	ED	HYDROI (N	
SHEET No.	DESCRIPTION	ROLLED EROSION CONTROL PRODUC (NETTING)	HYDROSEED	HYDROMULCH	COIR LOG	FIBER ROLL	COMPOST	COMPOST (N)	SEED	FIBER	FERTILIZER	FIBER	TACKIFIER
		SQFT	SQFT	SQFT	LF	LF	CY	SQFT	LB	LB	LB	LB	LB
EC-1	EC TYPE 1	22,765			4332	1808							
LC 1	EC TYPE 3		6228	6228			19	6228	6.0	71.5	6.0	214.5	17.9
EC-2	EC TYPE 2	6770	6770	6770			84	6770	6.6	77.7	6.6	233.1	10.9
	EC TYPE 3		20,317	20,317			63	20,317	19.7	233.2	19.7	699.6	58.3
	GRAND TOTAL	29 , 535	33,315	33,315	4332	1808	166						

[N] - NOT A SEPARATE BID ITEM.

EROSION CONTROL QUANTITIES

					Dist COUNTY ROUTE POST MILES SHOULD S
	INDEX OF ELEC	CTRICAL SYSTEMS PLANS:	<u>ABBRE VI</u>	ATIONS:	04 SM 101 0.8/1.1
	ELECTRICAL SYSTEMS		AWG	AMERICAN WIRE GAUGE	REGISTERED CIVIL ENGINEER 7-15-22 PROFE PR
	PLAN SHEET	DESCRIPTION	HCC	HYBRID CAMERA CABLE	9-30-22 PLANS APPROVAL PATE
22	E-1 TO E-3	ELECTRICAL SYSTEMS	PG&E	PACIFIC GAS AND ELECTRIC COMPANY	THE STATE OF CALIFORNIA OR ITS OFFICERS
7-15-	E-4	MODIFYING LIGHTING SYSTEMS	RRFB	RECTANGULAR RAPID FLASHING BEACON	THE ACCURACY OR COMPLETENESS OF SCANNED COPIES OF THIS PLAN SHEET.
- 20	E-5 TO E-6	MODIFYING FIBER OPTIC CABLE SYSTEMS			Y&C TRANSPORTATION CITY OF EAST I CONSULTANTS, INC. 1960 TATE STR 3250 RAMOS CIRCLE EAST PALO ALT
REVISED	E-7 TO E-9	MODIFYING SIGNAL AND LIGHTING SYSTEMS			SACRAMENTO, CA 95827 CA 94303
	E-10 TO E-12	LIGHTING (CITY STREET)			
DATE	E-13 TO E-18	SIGNAL AND LIGHTING (CITY STREET)			
	E-19	RECTANGULAR RAPID FLASHING BEACON SYSTEM (CITY)	LEGEND:		
_	ED-1 TO ED-4	ELECTRICAL SYSTEMS DETAILS	2202110		
CHAN	EQ-1 TO EQ-2	ELECTRICAL SYSTEMS QUANTITIES	o- <u>(i)</u>	PEDESTRIAN TEAR DROP LIGHT WITH 51 W LED LUMINAII (HOLOPHANE MODEL NO. MSPL2-P30-40K-AS-S-B-4-P5-F	PCS-BHDF13-200-BK) ON 13' DECORATIVE POLE
KIN Y.			Ckt No.	(HOLOPHANE MODEL NO. NY13/20CISU734D, AFCABKH, BH OR APPROVED EQUAL. INSTALL CALTRANS TYPE 15 FOU	CZ4/I/BOU38ZO, FGIUS, AB-31-4 RFD1(012Z), NDATION PER MANUFACTURER RECOMMENDATION.
СНЕСКЕD ВҮ			CK+ No	DUAL HEAD STREET/PEDESTRIAN TEAR DROP LIGHT INCL (HOLOPHANE MODEL NO. MPL2-P30S-40K-AS-BK-TG-3-S- (HOLOPHANE MODEL NO. MSPL2-P10-40K-AS-S-B-4-P5-F (HOLOPHANE MODEL NO. NY23/20CISU735D, WLC72/1, BH OR APPROVED EQUAL. INSTALL CALTRANS TYPE 15D FO	P5-PCLL-BHDF13-200-BK), 27 W LED PEDESTRIAN LUMINAI PCS-BHDF13-200-BK), AND 22'-10" DECORATIVE POLE C24/1, (2)BBD24, FGIUS, AB-31-4 RFD170123),
			G ,	5 W LED LIGHT BOLLARD (B-K LIGHTING MODEL NO. BS-	-LED-e102-A9-BLA-B-BLP-30-T) OR APPROVED EQUAL.
			Ckt No.	SEE STRUCTURE PLANS FOR INSTALLATION DETAILS.	
	NOTES:		<u></u>	RRFB AASEMBLY	
. AO		E WIRES FOR ALL NEW CALTRANS CONDUITS PER CALTRANS STANDARD	-	MA D AASEMBET	
DAN A.	SPECIFICATION	OR MUST COMPLY WITH THE SIGN PLANS FOR SIGNS MOUNTED ON SIGNAL AND NDARDS AND MAST ARMS.	٦	NEMA 4 JUNCTION BOX, 12"L × 6"W × 4"D. SEE SHEET	13 STRUCTURE PLAN FOR JUNCTION BOX INSTALLATION DE
		TRAFFIC RATED PULL BOXES MUST BE WELDED AS SHOWN ON SHEET ED-1.			
۱					
					ELECTRICAL SYSTEM
		INDEV OF FLEATBLOAT OV	OTEMO DIANO NOT	O ADDDEVIATIONS AND LESSY	
		INDEX OF ELECTRICAL SYS	SIEMS PLANS, NOTE	ES, ABBREVIATIONS AND LEGEN	E-

USERNAME => myang DGN FILE => E-1 NOTES


RELATIVE BORDER SCALE IS IN INCHES

		73 Exist 2-1" INNERDUCTS IN 2"C, ONE 72-STRAND SMFO CABLE TO FIBER OPTIC CABINET TSC053 AT UNIVERSITY AVE AND BAY Rd INTERSECTION
MY	5-22	74 PULL OUT Exist ONE 72-STRAND SMFO CABLE FROM FIBER OPTIC CABIN TSC057 TO THIS FIBER OPTIC SPLICE VAULT. REINSTALL ONE 72-STR SMFO CABLE IN NEW AND EXISTING CONDUITS AS INDICATED ON THE PL
BY N	REVISED 07-1	75 Exist 2"C, ONE 12-STRAND SMFO CABLE AND ONE 72-STRAND SMFO CAB PULL OUT AND REINSTALL Exist ONE 72-STRAND SMFO CABLE AS INDICATED ON THE PLAN.
REVISED	DATE REVI	76 Exist 2-1" INNERDUCTS IN 2"C, ONE 72-STRAND SMFO CABLE. PULL O AND REINSTALL Exist ONE 72-STRAND SMFO CABLE AS INDICATED ON PLAN.
	_	77 4-1½"C, ONE 12-STRAND SMFO CABLE, REINSTALL Exist ONE 72-STRAN SMFO CABLE TO NEW CONDUIT AS INDICATED ON THE PLAN. SEE TRENC DETAIL ON SHEET ED-3.
YANG	CHAN	78 Exist 3"C, ONE 12-STRAND SMFO CABLE.
MENG	KIN Y.	79 INSTALL FIBER OPTIC PULL BOX. SEE SHEET ED-2 FOR DETAILS.
	<u> </u>	80 4-11/2"C, ONE 12-STRAND SMFO CABLE. SEE TRENCH DETAIL ON SHEET ED-3.
CULATED- IGNED BY	CHECKED BY	81 ADD ONE 30 A, 1P, 120 V CB WITH NAMEPLATE "LIGHTING 2" TO Exist SERVICE EQUIPMENT ENCLOSURE FOR L+g Ck+ 2. ADD ONE 30 A, 1P, 1 V CB WITH NAMEPLATE "LIGHTING 3" TO Exist SERVICE EQUIPMENT ENCLOSURE FOR L+g Ck+ 3.
CAL	CHE	82 Exist 2"C, 2 DLC. ADD 12 LOOP WIRES.
SUPERVISOR		ADD 20 A, 1P, 120 V CB WITH NAMEPLATE "RRFB" TO Exist SERVICE EQUIPMENT ENCLOSURE FOR RRFB.
		84] 3"C, 2#6 (240 V SOFFIT), 8 DLC, 1 SIC.
FUNCTIONAL	YAU	85 Exist $1\frac{1}{2}$ "C, 2#6 (240 V L+g), 2#14 (120 V TEST SWITCH).
FUNCT	DAN K.	86 2"C, 2#6 (240 V L+g), 2#14 (120 V TEST SWITCH).
		87 2"C, 2#6 (240 V L+g).
CONSULTANT		88 RL Exist IISNS TO NEW SMA AS SHOWN ON SHEET E-17.
		89 Exist 2"C, ONE 12-STRAND SMFO CABLE.
AT ION		90 Exist $1\frac{1}{2}$ "C, 2 DLC. ADD 8 LOOP WIRES.
TRANSPORTATION		91 RC Exist PBA. REPAIR THE HOLES ON Exist STANDARD.
OF TR		
DEPARTMENT		
1		
CAL IFORNIA	ع ا	
CALIF	ditans	
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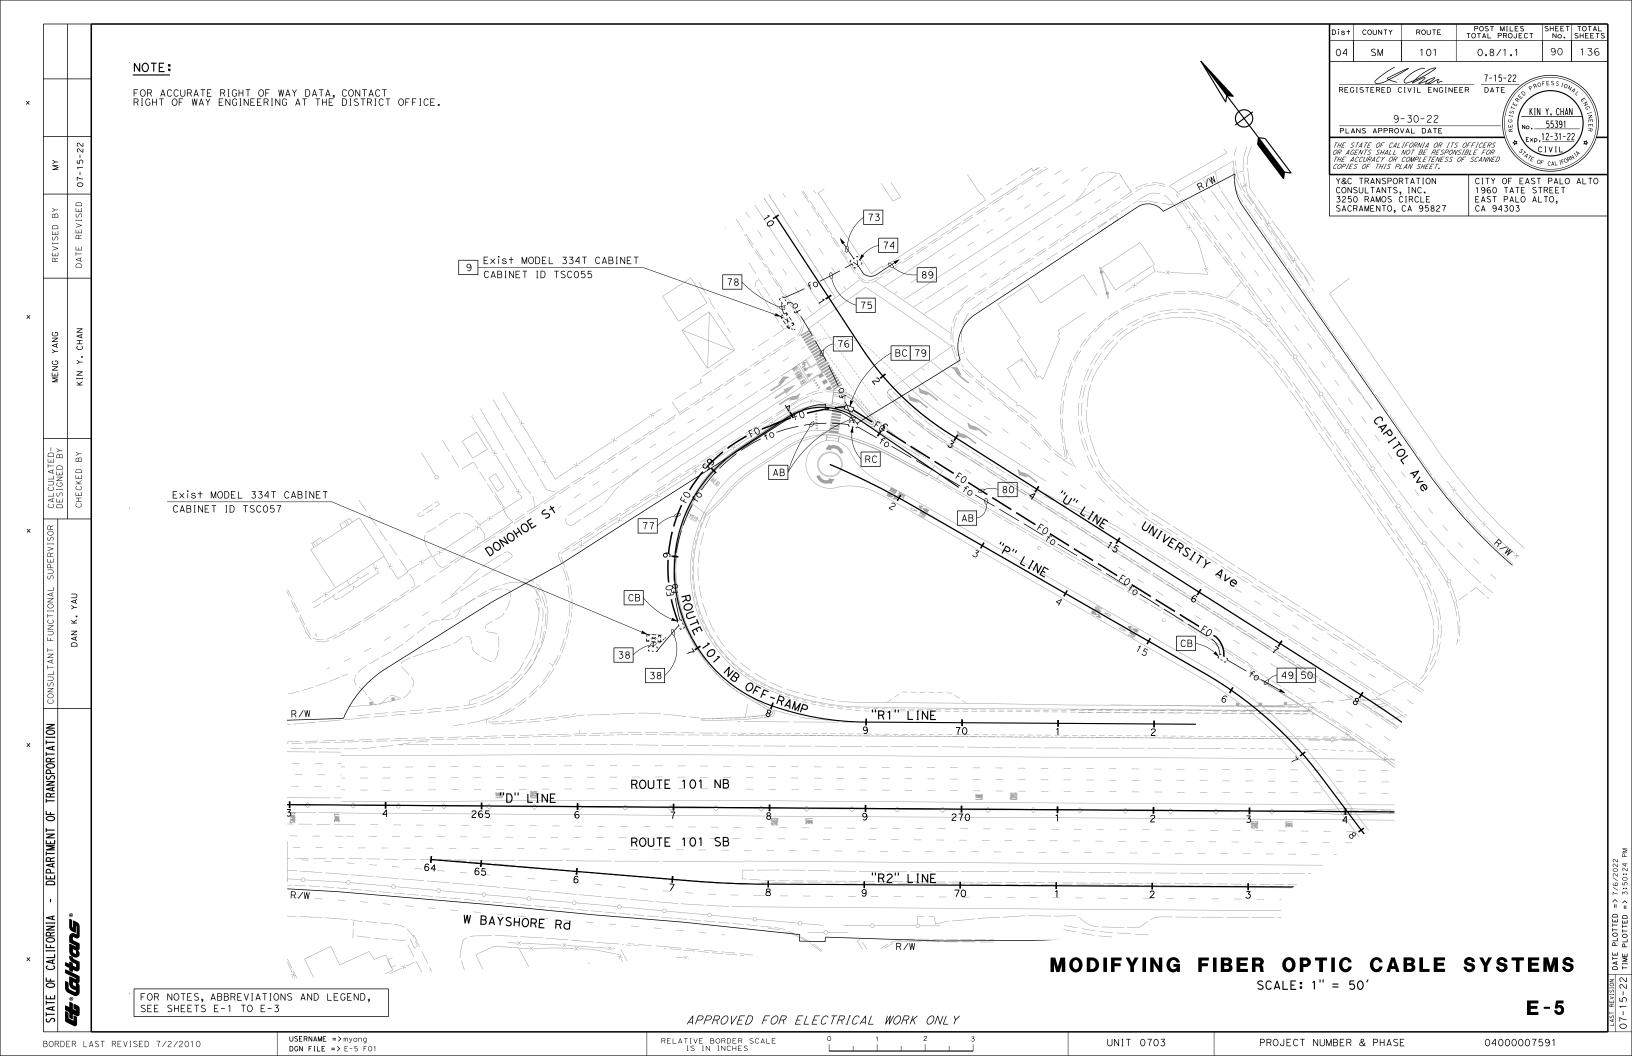
Dis	†	COUNTY	ROUTE	POST MILES SHE									
04	1	SM	101	0.8/1.1 88	3 136								
	REGISTERED CIVIL ENGINEER 9-30-22 PLANS APPROVAL DATE T-15-22 DATE REGISTERED CIVIL ENGINEER 7-15-22 DATE REGISTERED CIVIL ENGINEER No. 55391												
OR THE	THE STATE OF CALIFORNIA OR ITS OFFICERS OR AGENTS SHALL NOT BE RESPONSIBLE FOR THE ACCURACY OR COMPLETENESS OF SCANNED COPIES OF THIS PLAN SHEET.												
CC 32	Y&C TRANSPORTATION CONSULTANTS, INC. 3250 RAMOS CIRCLE SACRAMENTO, CA 95827 Y&C TRANSPORTATION CITY OF EAST PALO ALTO 1960 TATE STREET EAST PALO ALTO, CA 94303												


ELECTRICAL SYSTEMS


E-3

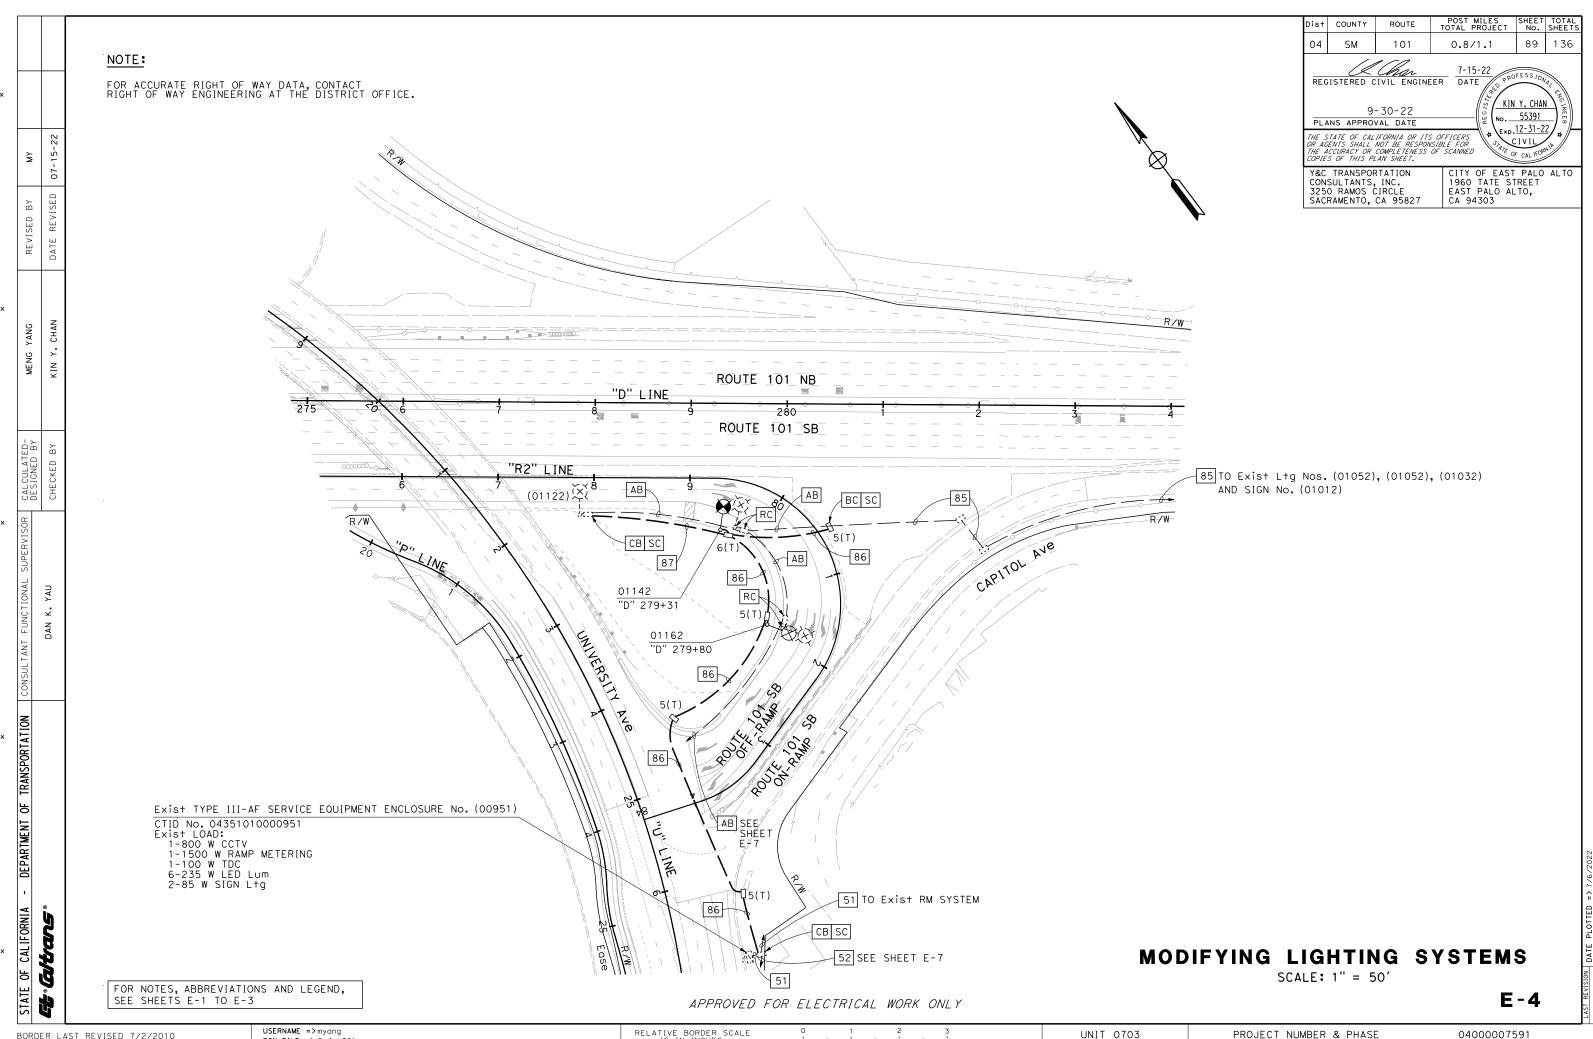


UNIT 0703 PROJECT NUMBER & PHASE BORDER LAST REVISED 7/2/2010 DGN FILE => E-4 LTG1



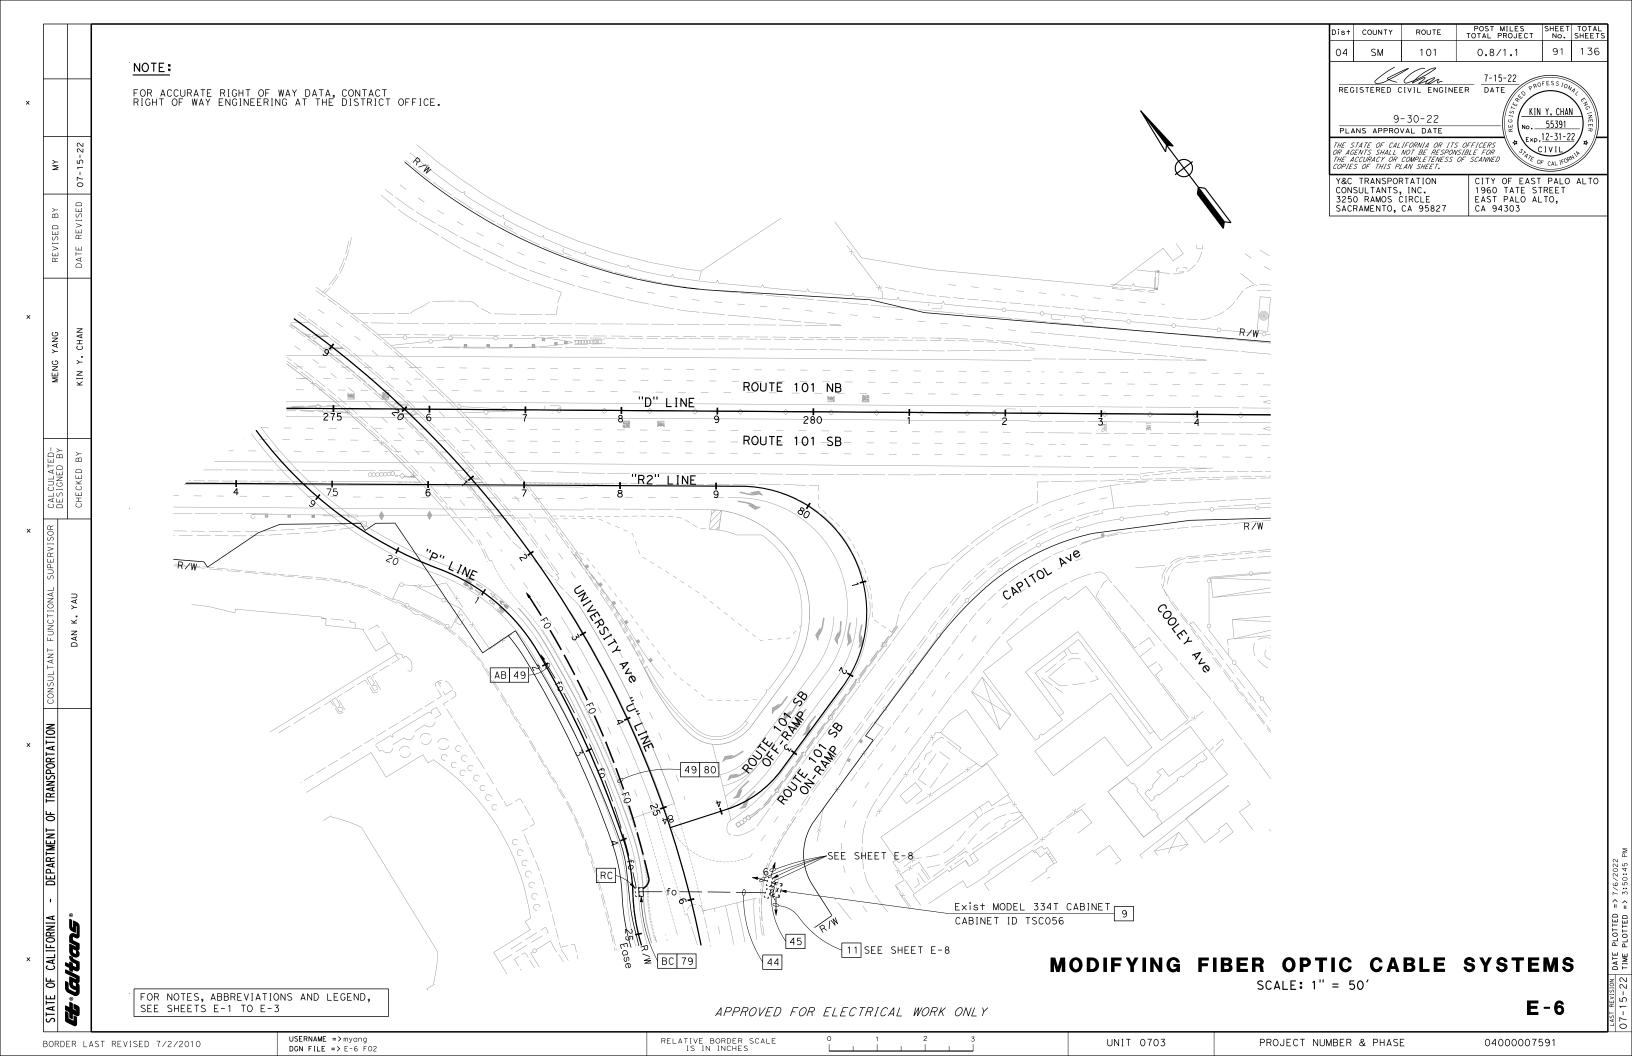

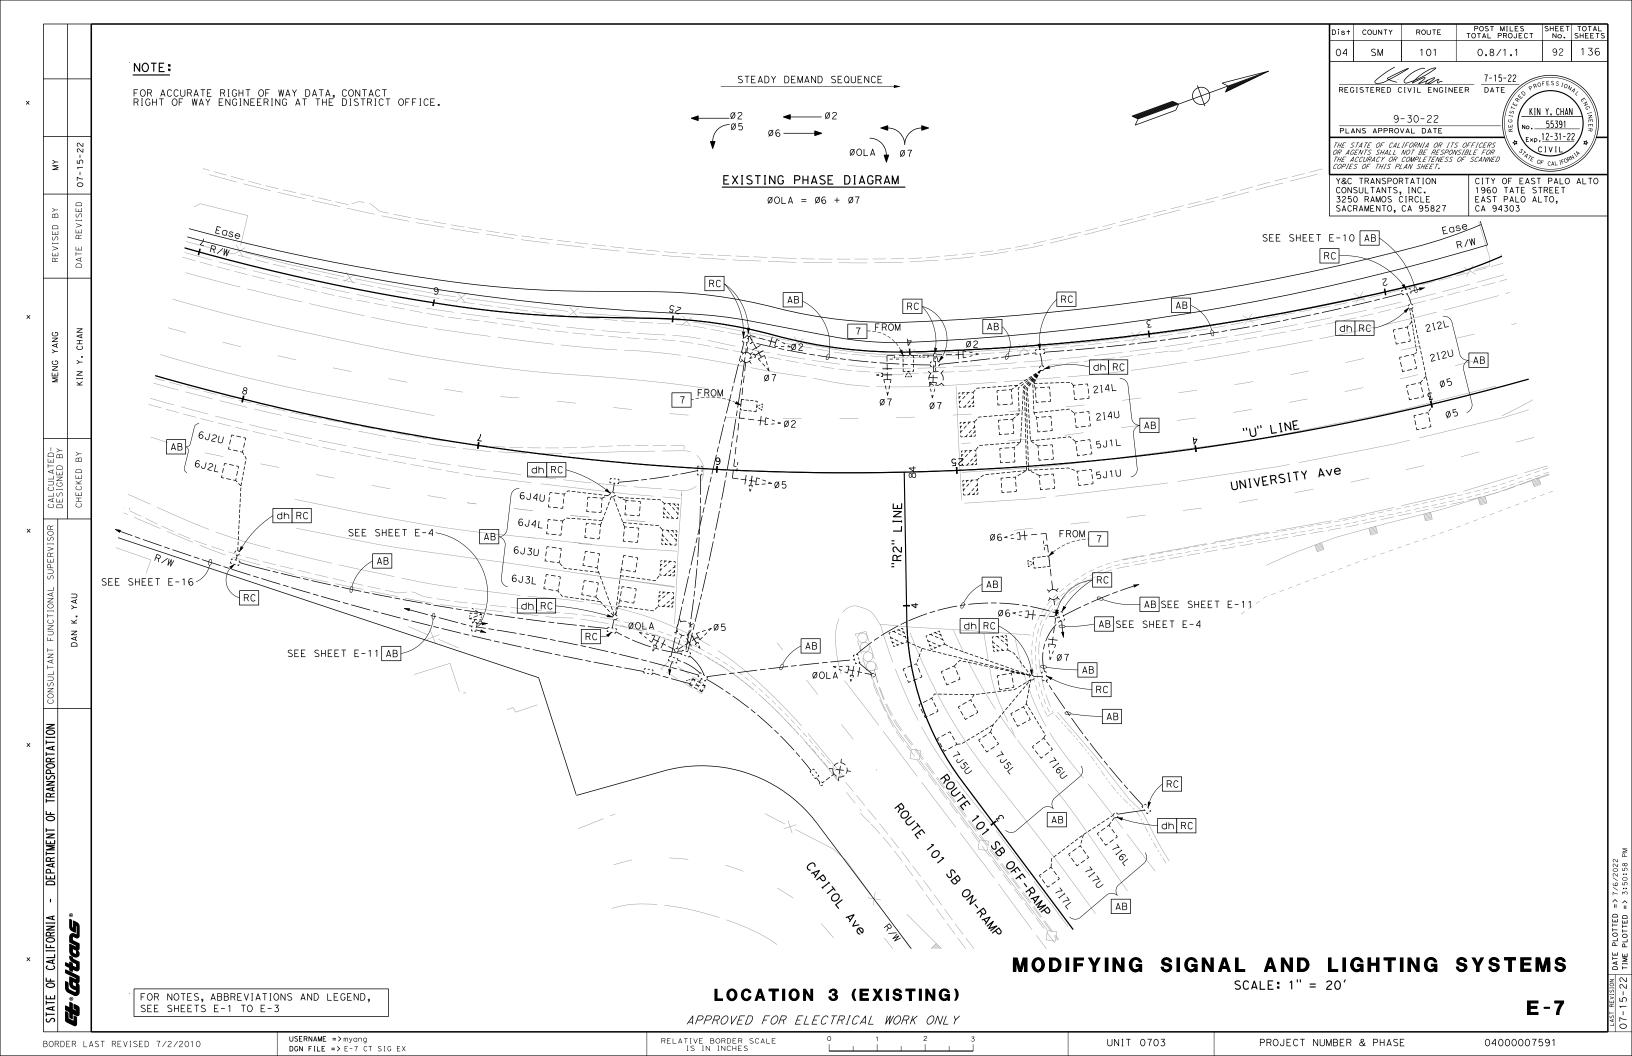

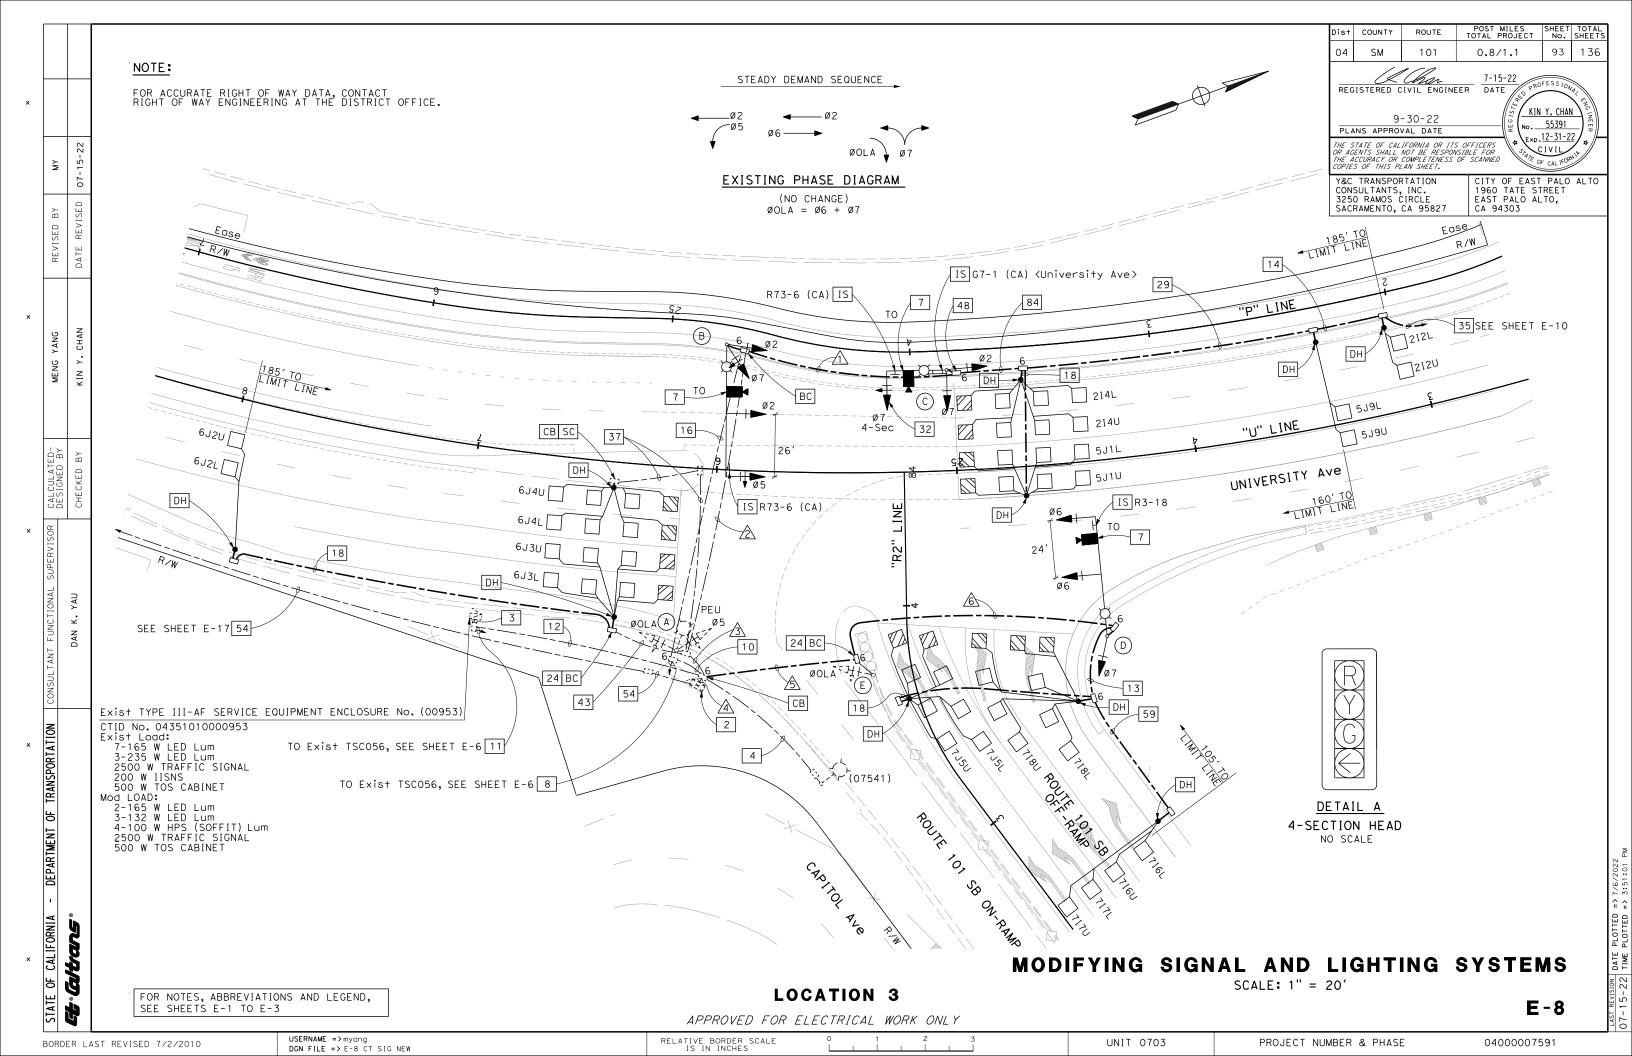

SCHEDULES: (FOR SHEET E-8)

CONDUCTOR AND CONDUIT SCH	HEDU	JLE				
				DNDU		
CONDUCTOR SCHEDULE	COI			UN N		ER
	1/1	2	3	4	/5\	<u>/6\</u>
No. 14 CONDUCTORS						
Ø2	3	3		3		
Ø5		3	3	3		
Ø6	<u> </u>			3	3	3
Ø7	4	4	4	7	3	3
ØOLA			5	10	5	
PEU	<u> </u>		3	<u> </u>		
SPARES	3	3	3	6	3	3
TOTAL No. 14	10	13	18	32	14	9
No. 8 CONDUCTORS						
SIGNAL NEUTRAL	1	1	1	2	1	1
				 		
No. 6 CONDUCTORS						
LIGHTING	2	2	2		2	2
SERVICE TO CONTROLLER				2		
TOTAL No. 6	2	2	2	2	2	2
DETECTOR CABLES (DLC)						
2I2U/2I2L	2	2	2	2		
2I4U/2I4L	2	2	2	2		
716U/716L				2	2	2
717U/717L				2	2	2
718U/718L				2	2	2
7J5U/7J5L				2	2	2
5J1U/5J1L	2	2	2	2		
5J9U/5J9L	2	2	2	2		
6J2U/6J2L			2	2		
6J3U/6J3L			2	2		
6J4U/6J4L			2	2		
TOTAL DETECTOR CABLES	8	8	14	22	8	8
CIONAL INTERCONNECT CARLES	1	1	1	1 /		
SIGNAL INTERCONNECT CABLES HYBRID CAMERA CABLE (HCC)	1		-	1 1#	1	1
HIDRID CAMERA CABLE (HCC)	+'-				-	-
CONDUIT SIZE (INCHES)	3''	3''	3"	2-3"	3''	3''
NEW/EXISTING CONDUIT	N	E	E	E	N	N
% FILL	17	16		_	17	

NOTE: REMOVE ALL Exist CONDUCTORS/CABLES.
ADD ALL NEW CONDUCTORS/CABLES, UNLESS OTHERWISE NOTED.

= Exist CABLE TO REMAIN

Dist	COUNTY	ROUTE	POST MILES TOTAL PROJECT	SHEET No.	TOTAL SHEETS								
04	SM	101	0.8/1.1	136									
	REGISTERED CIVIL ENGINEER 9-30-22 PLANS APPROVAL DATE 7-15-22 DATE PROFESS IONAL KIN Y. CHAN No. 55391												
OR AG	THE STATE OF CALIFORNIA OR 11S OFFICERS OR AGENTS SHALL NOT BE RESPONSIBLE FOR THE ACCURACY OR COMPLETENESS OF SCANNED COPIES OF THIS PLAN SHEET.												
Y&C TRANSPORTATION CONSULTANTS, INC. 3250 RAMOS CIRCLE SACRAMENTO, CA 95827 CA 94303													

					POL	E A	ND EQUI	PMENT SCHEE	DULE
	S1	ANDARD			Veh S	ig M	†g		
No.	TYPE	SMA	LMA	Ø	ø MAST ø		POLE	LED Lum	REMARKS *
(A)	Exist 15		15′			5	SV-2-TA	Rdwy 1	ALL EXISTING EQUIPMENT TO REMAIN.
	15		1			OLA	JV Z TA	Nawy 1	ALL EXISTING EGGIT MENT TO REMAIN.
(B)	29-5-100	55′	15′	5	MAS	2	SV-2-TB	Rdwy 11	SEE LEGEND 7 . IS R73-6(CA).
	23 3 100	3	13	2	MAS	7	34-2-10	Nawy 11	SEE ELOUND 1 . [15] KYS O(CA).
(c)	19-4-100	25′	15′	7	MAS-4B	2	SV-2-TB	Rdwy 11	SEE LEGEND 7 . IS R73-6(CA) AND G7-1(CA).
	13 4 100	2 7	13	,	WAS 1B	7	34-2-10	Nawy 11	SEE ELOCIND 1 . [15] KITS O(CA) AND OT INCA).
(D)	29-5-100	50 <i>′</i>	15′	6	MAS	7	SV-1-T	Rdwy 11	SEE LEGEND 7 . IS R3-18.
	29 3 100	3	13	6	MAS	'	3 1 1	Nawy 11	SEE ELOCIND 1 . [13] NO 10.
E	Exist 1-B					OLA	TV-1-T		ALL EXISTING EQUIPMENT TO REMAIN.

MODIFYING SIGNAL AND LIGHTING SYSTEMS SCALE: 1" = 20'

LOCATION 3


E-9

PROJECT NUMBER & PHASE

STATE OF CALIFORNIA - DEPARTMENT OF TRANSPORTATION CONSULTANT FUNCTIONAL

GEOGRAPHICALS


DAN K. YAU

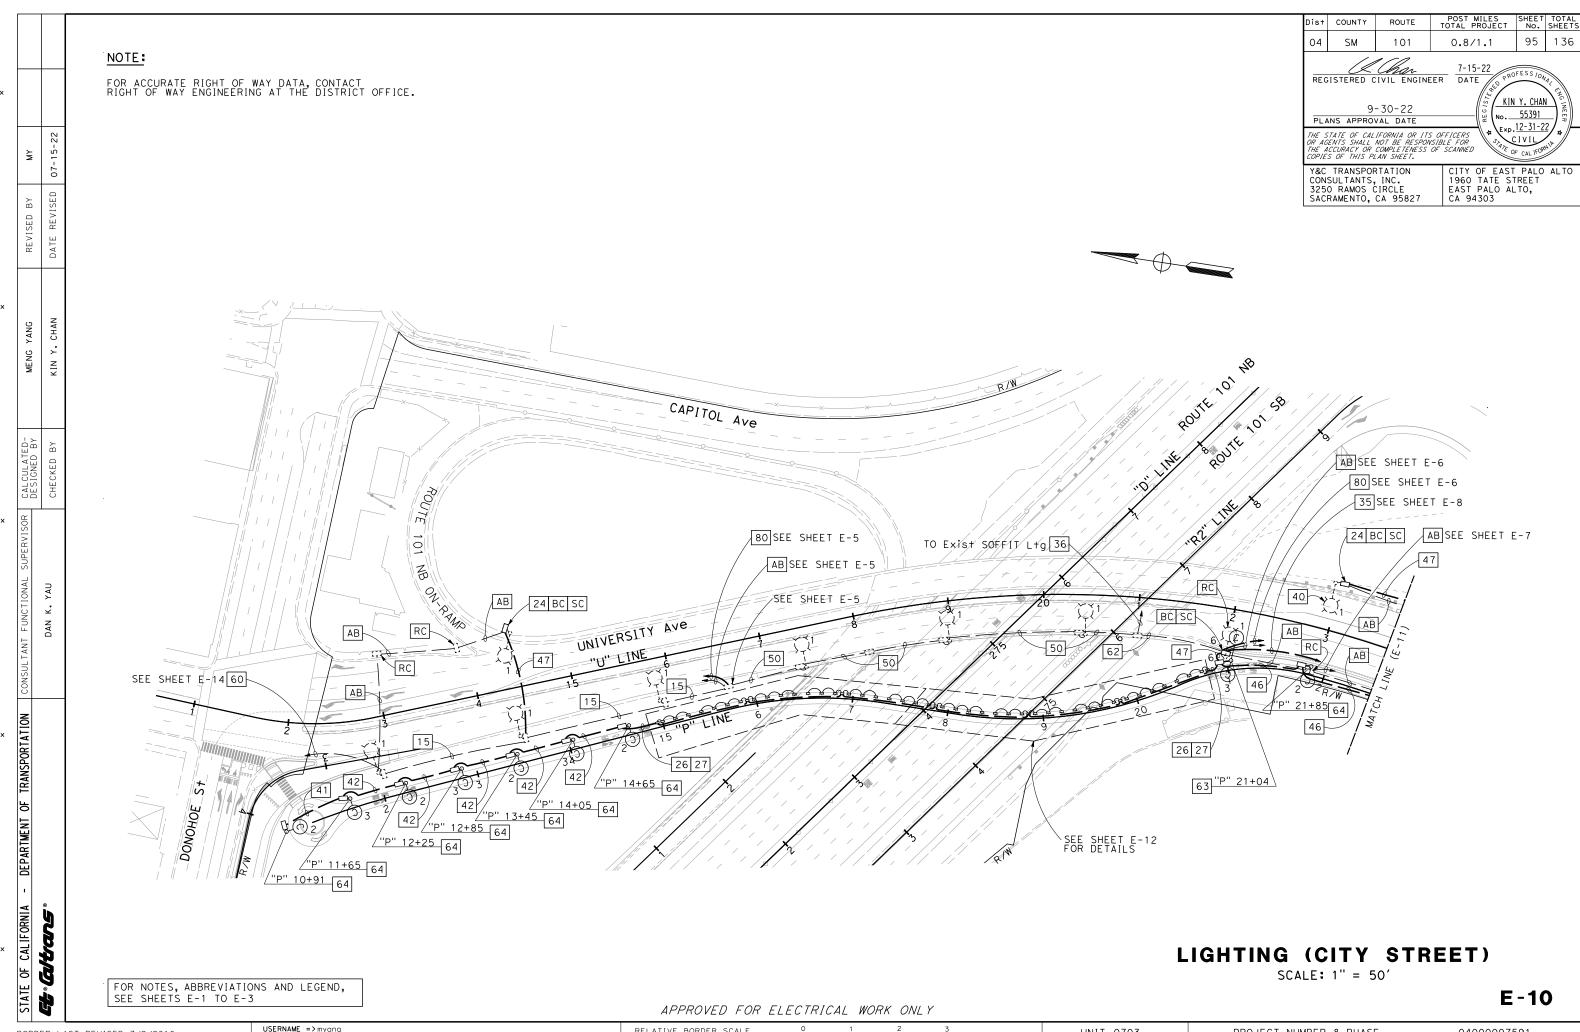

USERNAME => myang DGN FILE => E-10 Street Ltg1

UNIT 0703


PROJECT NUMBER & PHASE

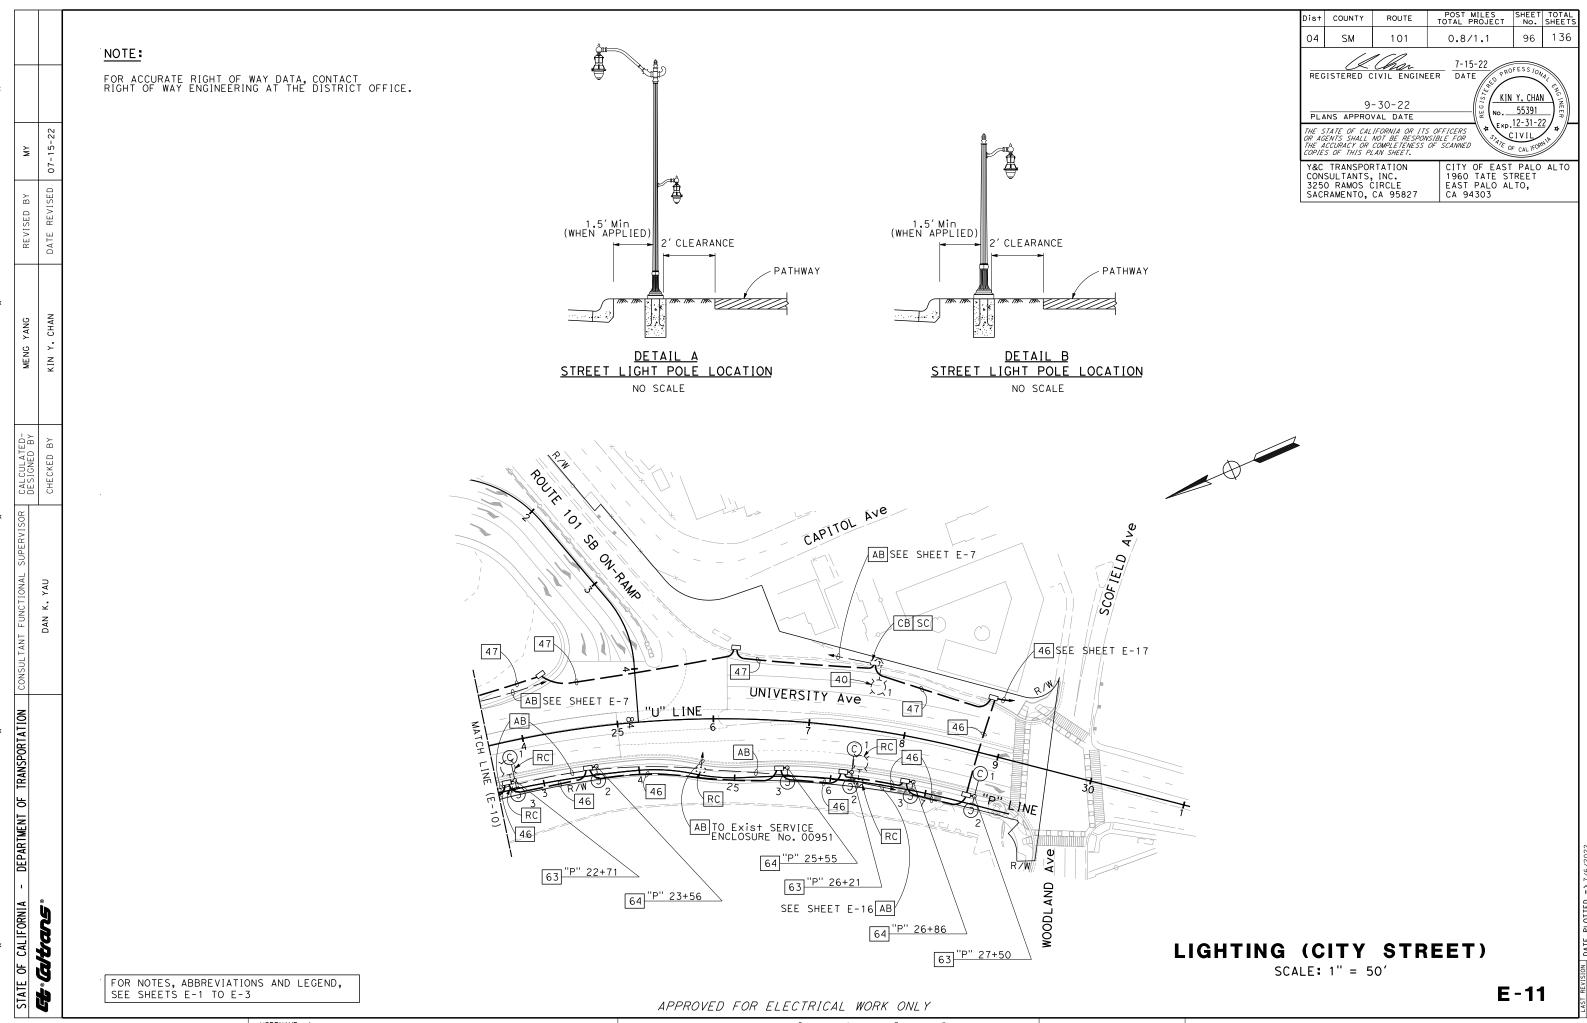

USERNAME => myang DGN FILE => E-11 Street Ltg2

04000007591

UNIT 0703 PROJECT NUMBER & PHASE

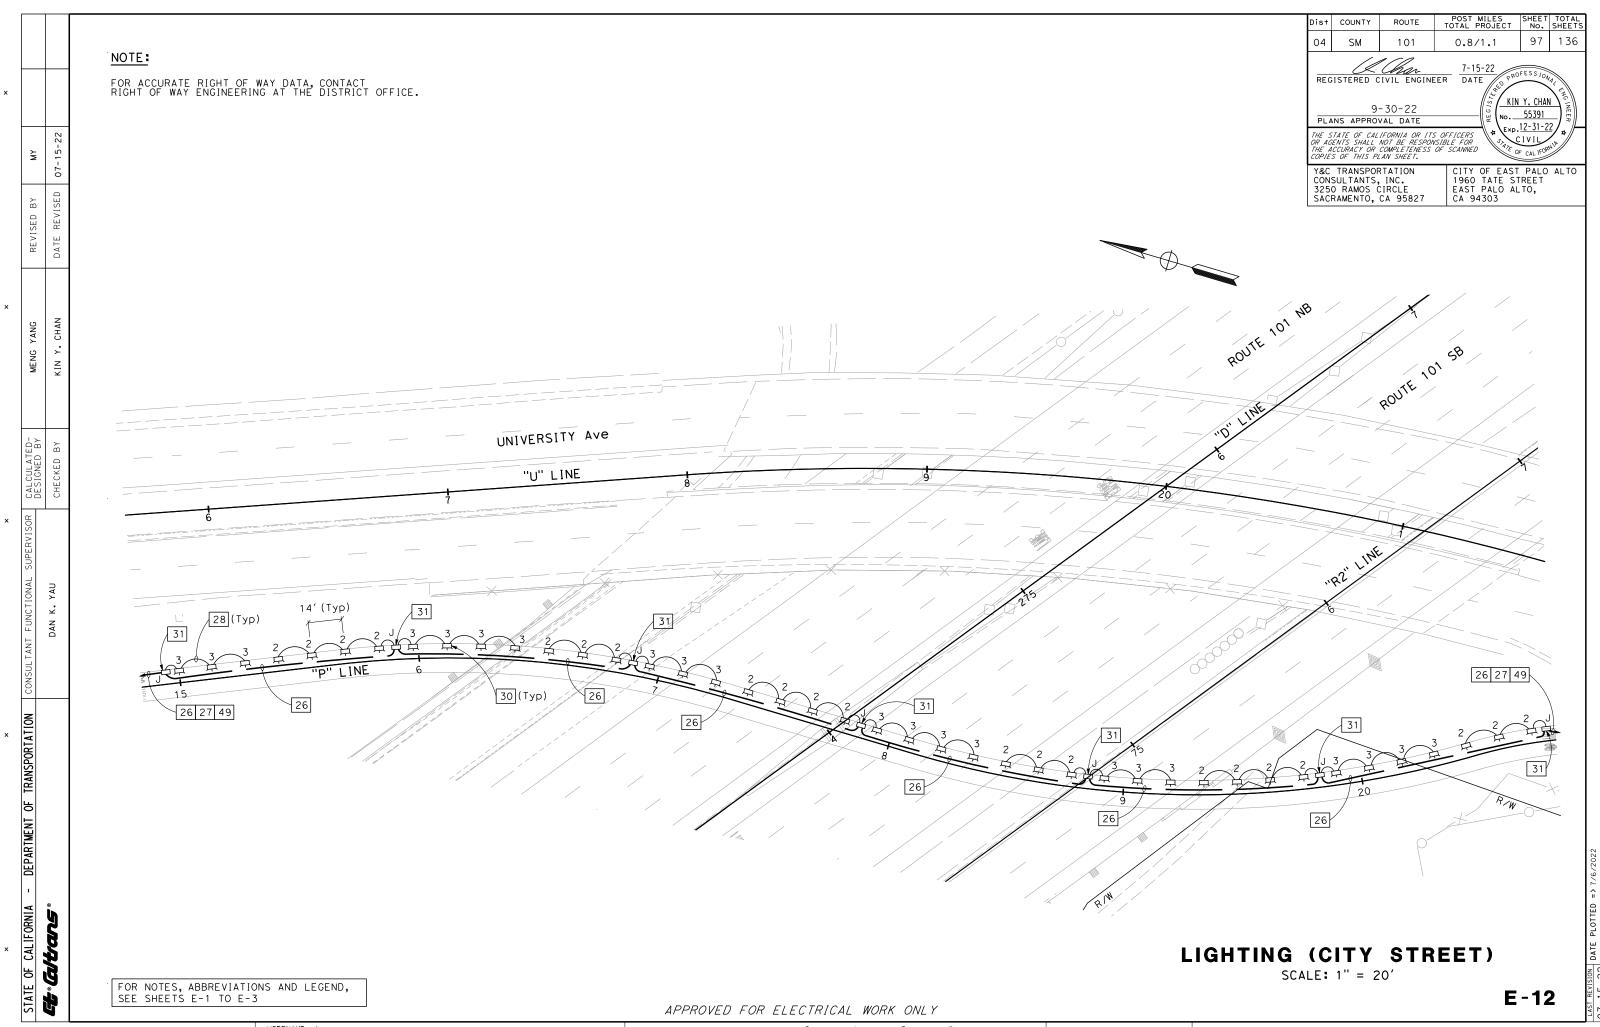



USERNAME => myang DGN FILE => E-12 POC L+g1 UNIT 0703 PROJECT NUMBER & PHASE

RELATIVE BORDER SCALE IS IN INCHES

04000007591

BORDER LAST REVISED 7/2/2010

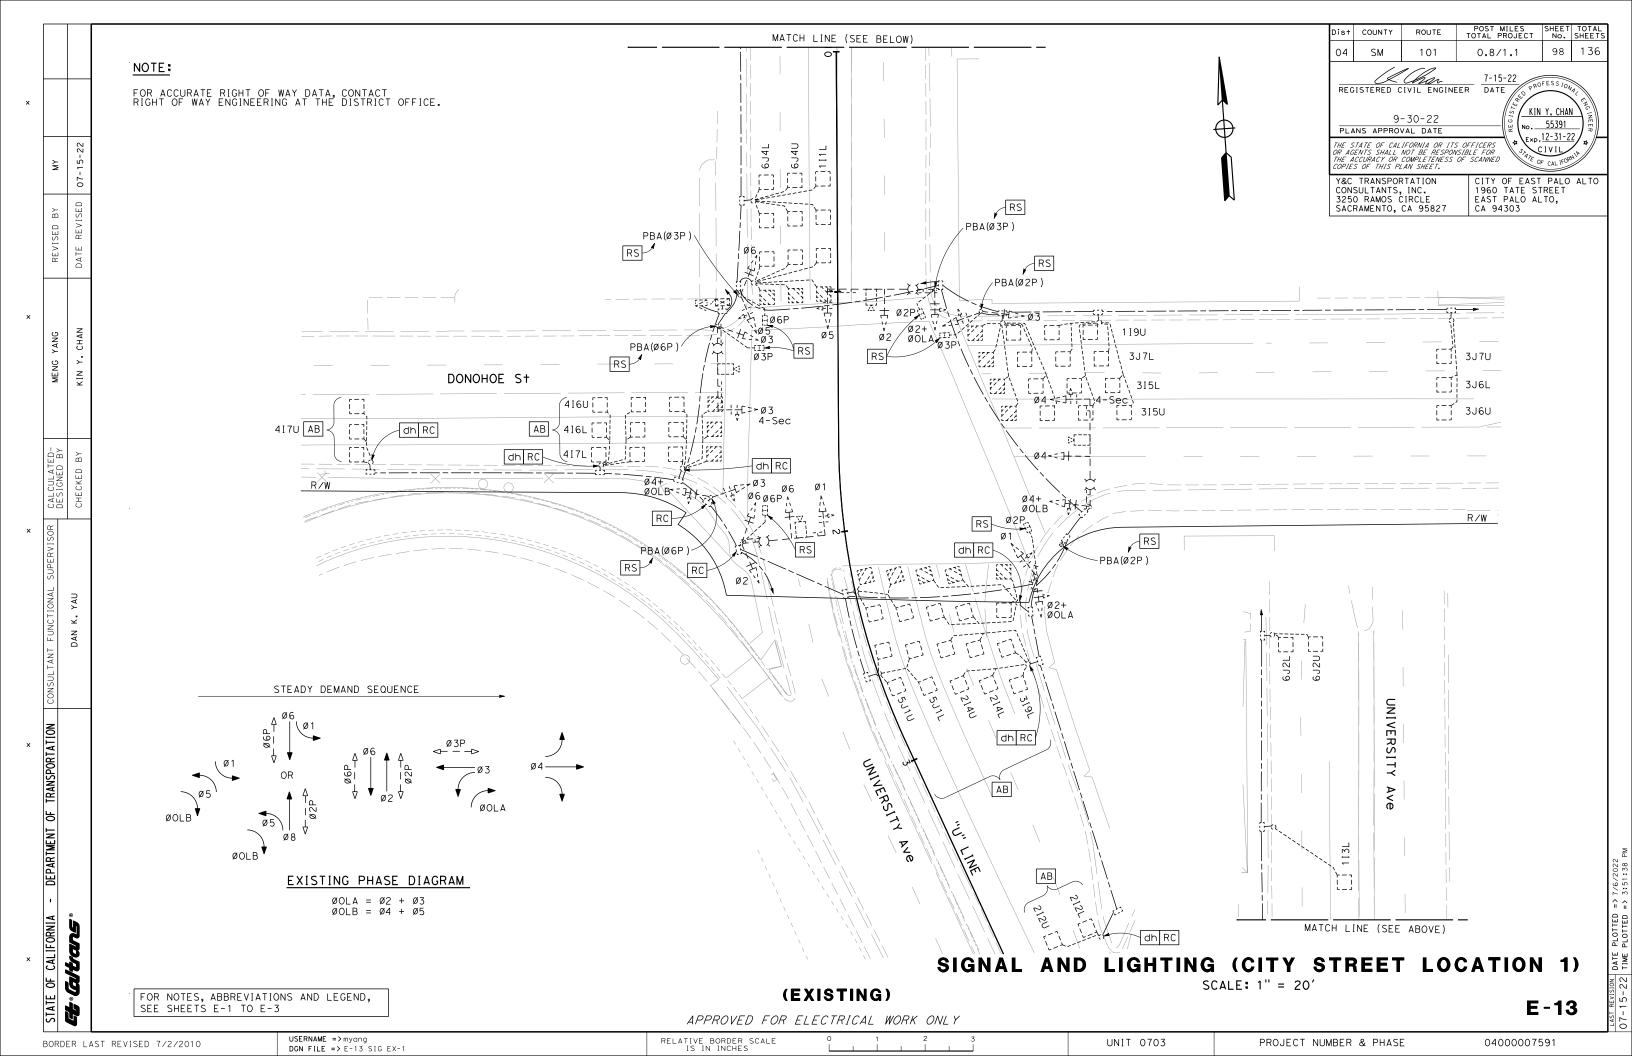

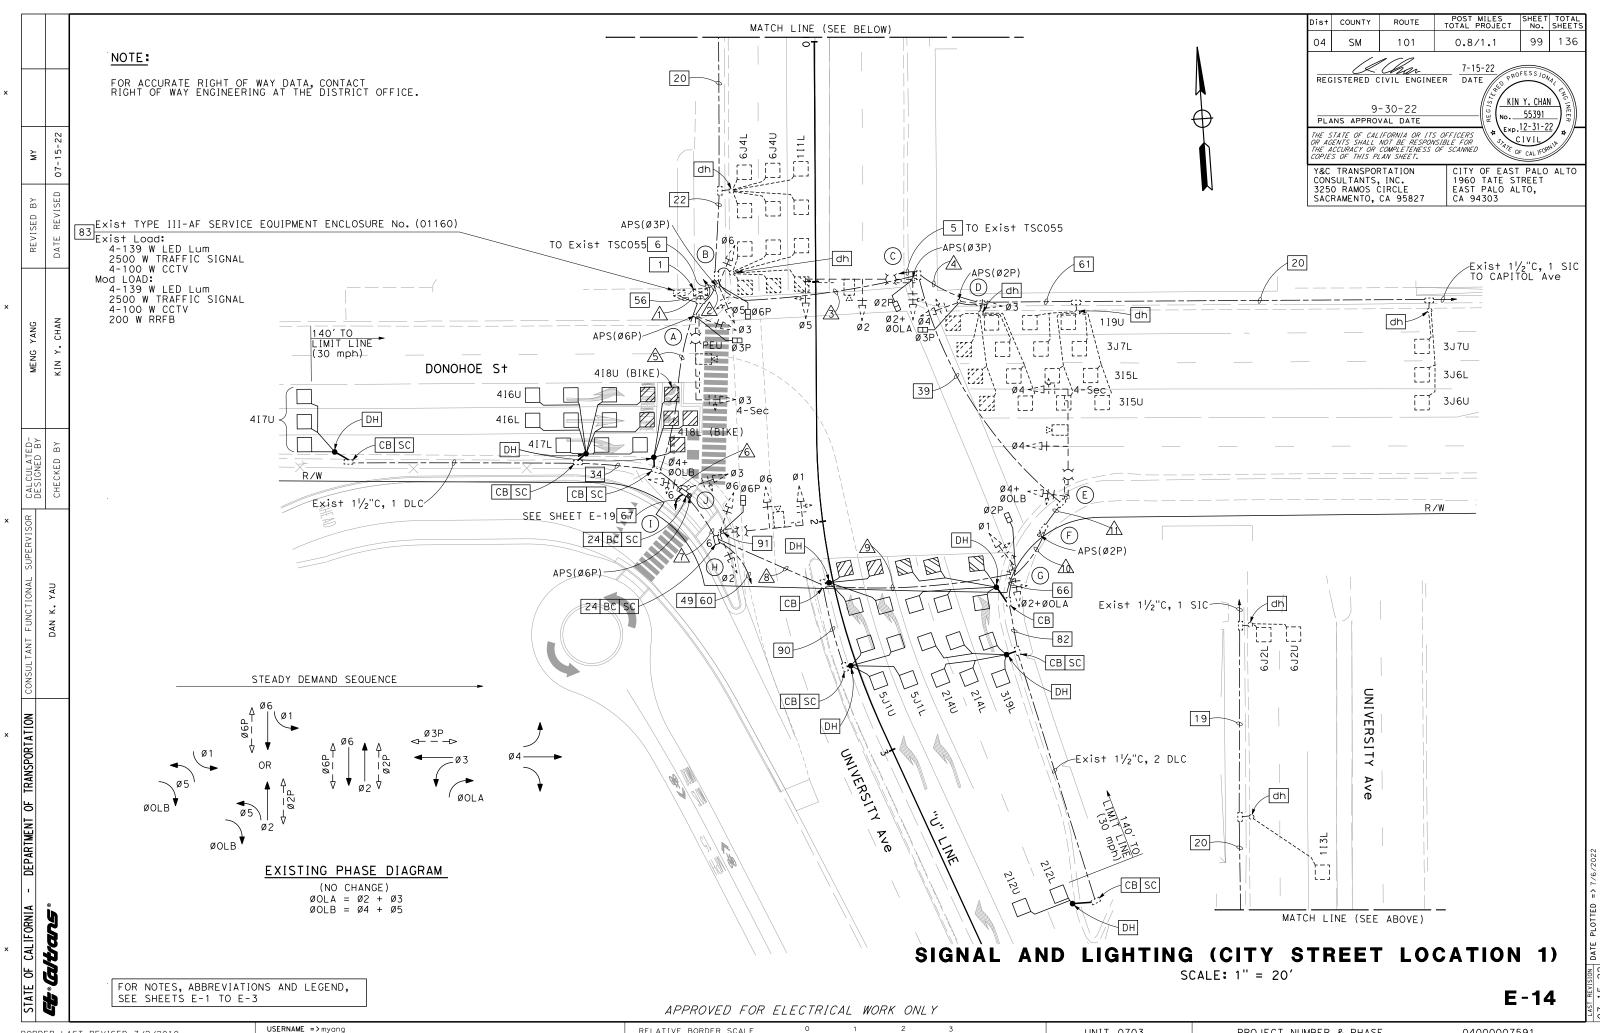

DGN FILE => E-14 SIG NEW-1

RELATIVE BORDER SCALE IS IN INCHES

UNIT 0703

PROJECT NUMBER & PHASE

CONDUCTOR AND CONDU	ΙΤ	SC	CHE	ΞDι	JLI	Ε					
				ΙΟ.							
CONDUCTOR DESIGNATION	L			DND						_	
	/1\	2	<u>/3\</u>	4	<u>/</u> 5\	<u></u>	$/\!\lambda$	<u>/8\</u>	<u>/9\</u>	19	<u>/ill</u>
No. 14 CONDUCTORS											
Ø1	3				3	3	3	3	3		
Ø2	6	3	3		3	3	3	3	3		
ø3	6	3	3	3	3	3					
ø4	6	3	3	3	3	3	3	3	3	3	3
ø5	3	3	3								
Ø6	6	3			3	3	3				
ØOLA	4	2	2		2	2	2	2	2		
ØOLB	2				2	2	2	2	2	2	2
Ø2P	4	2	2		2	2	2	2	2		
Ø3P	2	2	2	2		Ē	_		-		
Ø6P	4	2	_	-	2	2	2				
APS(Ø2P)	2	1	1	1	1	1	1	1	1	1	
APS(Ø3P)	1	1	1	H	_	<u> </u>		_			
APS(Ø6P)	1	<u> </u>	<u>'</u>		1	1					
	2	1	1	1			1	1	1	1	
APS COMMON	-	1	1	1	1	1	1	1	1	1	_
SPARES	6	3	3	3	3	3	3	3	3	3	3
TOTAL No. 14	58	29	24	13	29	29	25	20	20	10	8
No. 8 CONDUCTORS											
LIGHTING (240 V)		2	2		2	2	2	2	2	2	2
RRFB					2+	2+					
SIGNAL NEUTRAL	2	1	1	1	1	1	1	1	1	1	1
TOTAL No. 8	2	3	3	1	5	5	3	3	3	3	3
No. 6 CONDUCTORS											
SERVICE TO CONTROLLER (120 V)	2										
DETECTOR CABLES (DLC)											
1 I 1 L	1	1									
1 I 3 L	1	1									
119U	1	1	1	1							
212U/212L	2				2	2	2	2	2		
214U/214L	2				2	2	2	2	2		
315U/315L	2	2	2	2		Ē	_				
319L	1	-	-	_	1	1	1	1	1		
3J6U/3J6L	2	2	2	2			-	Ė	i i		
3J7U/3J7L	2	2	2	2							
416U/416L	2				2						
	2				2						
417U/417L 418U (BIKE)/418L (BIKE)	2+				2 ⁺						
	-				_		_	_			
5J1U/5J1L	2	<u> </u>			2	2	2	2			
6J2U/6J2L	2	-								\Box	
6J4U/6J4L	2	2	_	L			_	L	_		
TOTAL DETECTOR CABLES	26	13	7	7	13	7	7	7	5		
	<u> </u>					L.,					
SIGNAL INTERCONNECT CABLE	12/2		1	1	1*	1*	1*				
APS CABLE		2+		2+			1+			1+	
HYBRID CAMERA CABLE (HCC)								1	1	1	1
CONDUIT SIZE (INCHES)	2-	3	7	21⁄2	7	3	7	2 ¹ ⁄2	b1/	2	2
CONDUIT SIZE (INCHES)	<u> </u> 3''	L	L	K .5	ادا	ادا	ا	<u>~ '2</u>	F.5		۷
NEW/EXISTING CONDUIT (N/E)	E	Ε	Ε	Ε	Ε	Ε	Ε	Ε	Ε	Ε	Ε
% FILL	27	30	19	23	27	22	19	26	23	17	14

+ = ADD NEW CONDUCTORS/CABI	_ES.
-----------------------------	------

* = REMOVE Exist CONDUCTORS/CABLES. ADD NEW CONDUCTORS/CABLES.

Dist	COUNTY	ROUTE	POST MILES TOTAL PROJECT	SHEET No.	TOTAL SHEETS								
04	SM	101	0.8/1.1	100	136								
	PLANS APPROVAL DATE T-15-22 PATE												
OR AC	THE STATE OF CALIFORNIA OR 11S OFFICERS OR AGENTS SHALL NOT BE RESPONSIBLE FOR THE ACCURACY OR COMPLETENESS OF SCANNED COPIES OF THIS PLAN SHEET.												
CON 325	Y&C TRANSPORTATION CITY OF EAST PALO ALTO 1960 TATE STREET EAST PALO ALTO, CA 95827 CA 94303												

							POLE	AND	EQUIPMENT S	СНЕ	DULE		
	ST	ANDARD			Veh S	ig M	†g		Ped Sig		APS		
No.	TYPE	SMA	LMA	ø	MAST ARM	Ø	POLE	Ø	M +g	Ø	ARROW	LED Lum	REMARKS
A	Exist 24-4-113	35′	12′	3	MAS-4B	3	SV-1-T	3 +	SP-1-T +	6	-	139 W	
В	Exist 1-B					5 6	TV-2-T	6	SP-1-T +	3	-		
C	Exist 26-4-113	45′	12′	5 2	MAS MAS	2+ OLA	SV-1-T	2 +	SP-1-T +	3	-	139 W	
D	Exist 1-B					3 4	TV-2-T	3	SP-1-T	2	-		
E	Exist 26-4-113	45′	15′	4	MAS-4B MAS	4+ OLB	SV-1-T					139 W	ALL EXISTING EQUIPMENT TO REMAIN.
F	Exist PBA POST									2	-		
G	Exist 1-B					1 2+ OLA	TV-2-T	2 +	SP-1-T +				
Н	Exist 24-4-113	35′	12′	6	MAS MAS	2 6	SV-2-TA	6	SP-1-T +			139 W	SEE LEGEND 91.
1	Exist 1-B					3 4+ OLB	TV-2-T						ALL EXISTING EQUIPMENT TO REMAIN.
J	PBA POST									6			

⁺ INSTALL NEW EQUIPMENT TO Exist SIGNAL STANDARD

SIGNAL AND LIGHTING (CITY STREET LOCATION 1)

SCALE: 1" = 20'

E-15

USERNAME => myang DGN FILE => E-15 SCH 1


UNIT 0703

PROJECT NUMBER & PHASE

STATE OF CALIFORNIA - DEPARTMENT OF TRANSPORTATION CONSULTANT FUNCTIONAL

GEOGRAPHICALS


DAN K. YAU

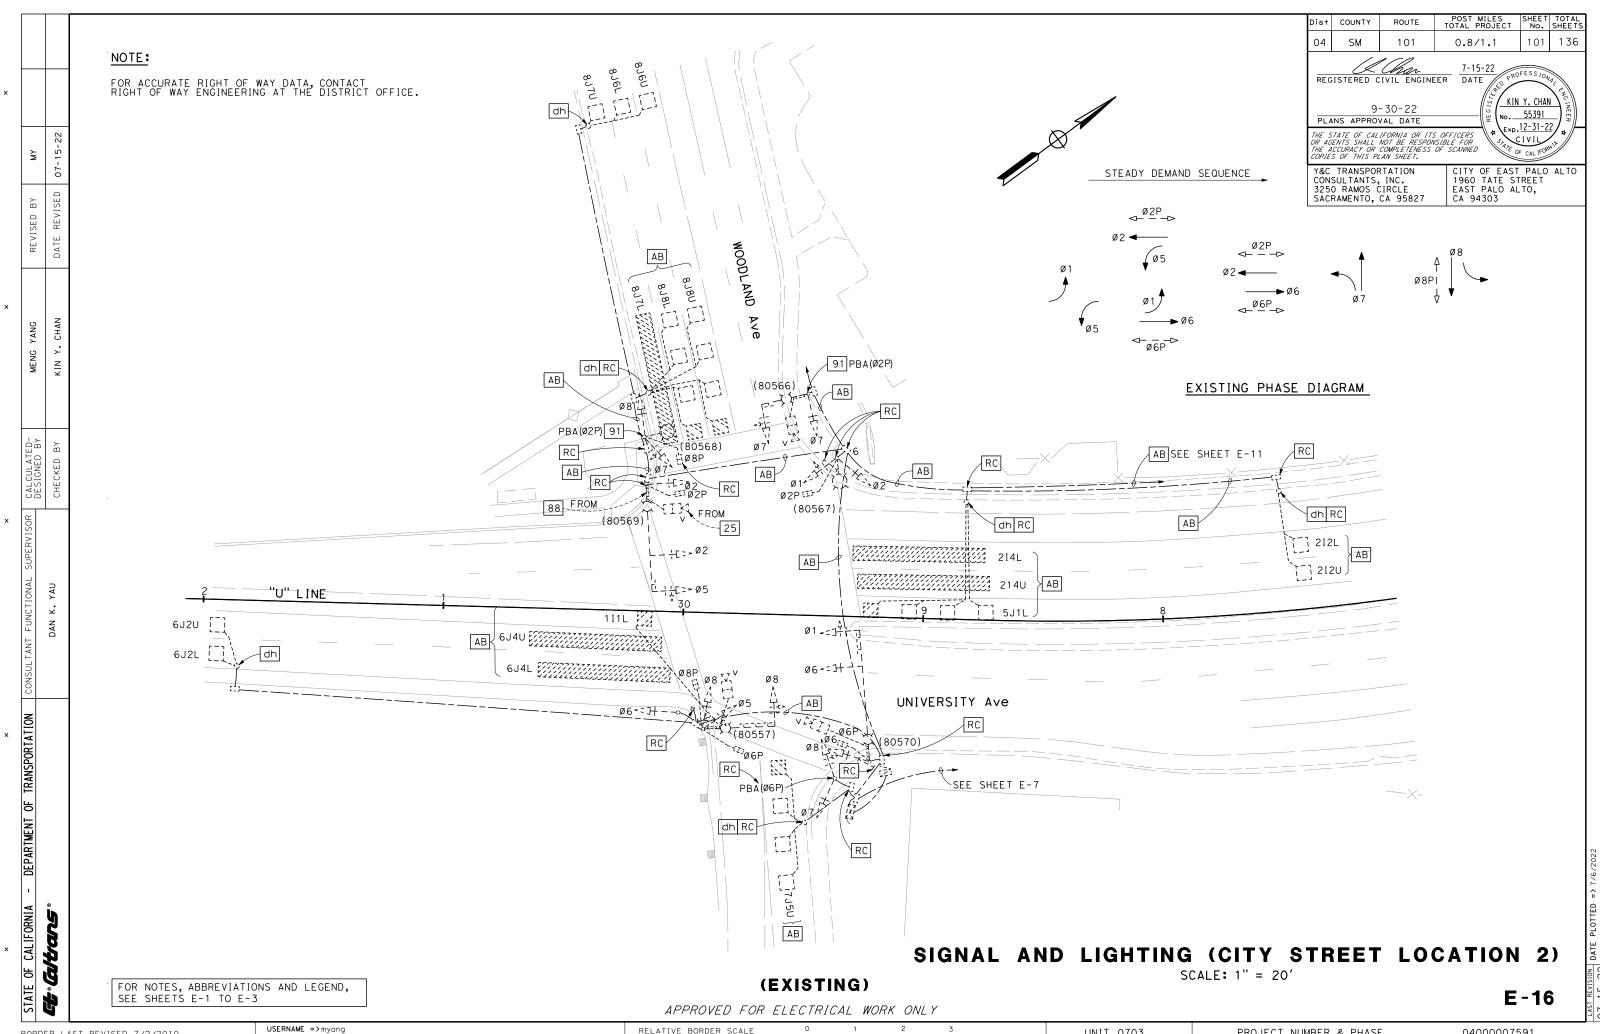

DGN FILE => E-16 SIG EX-2

04000007591

UNIT 0703

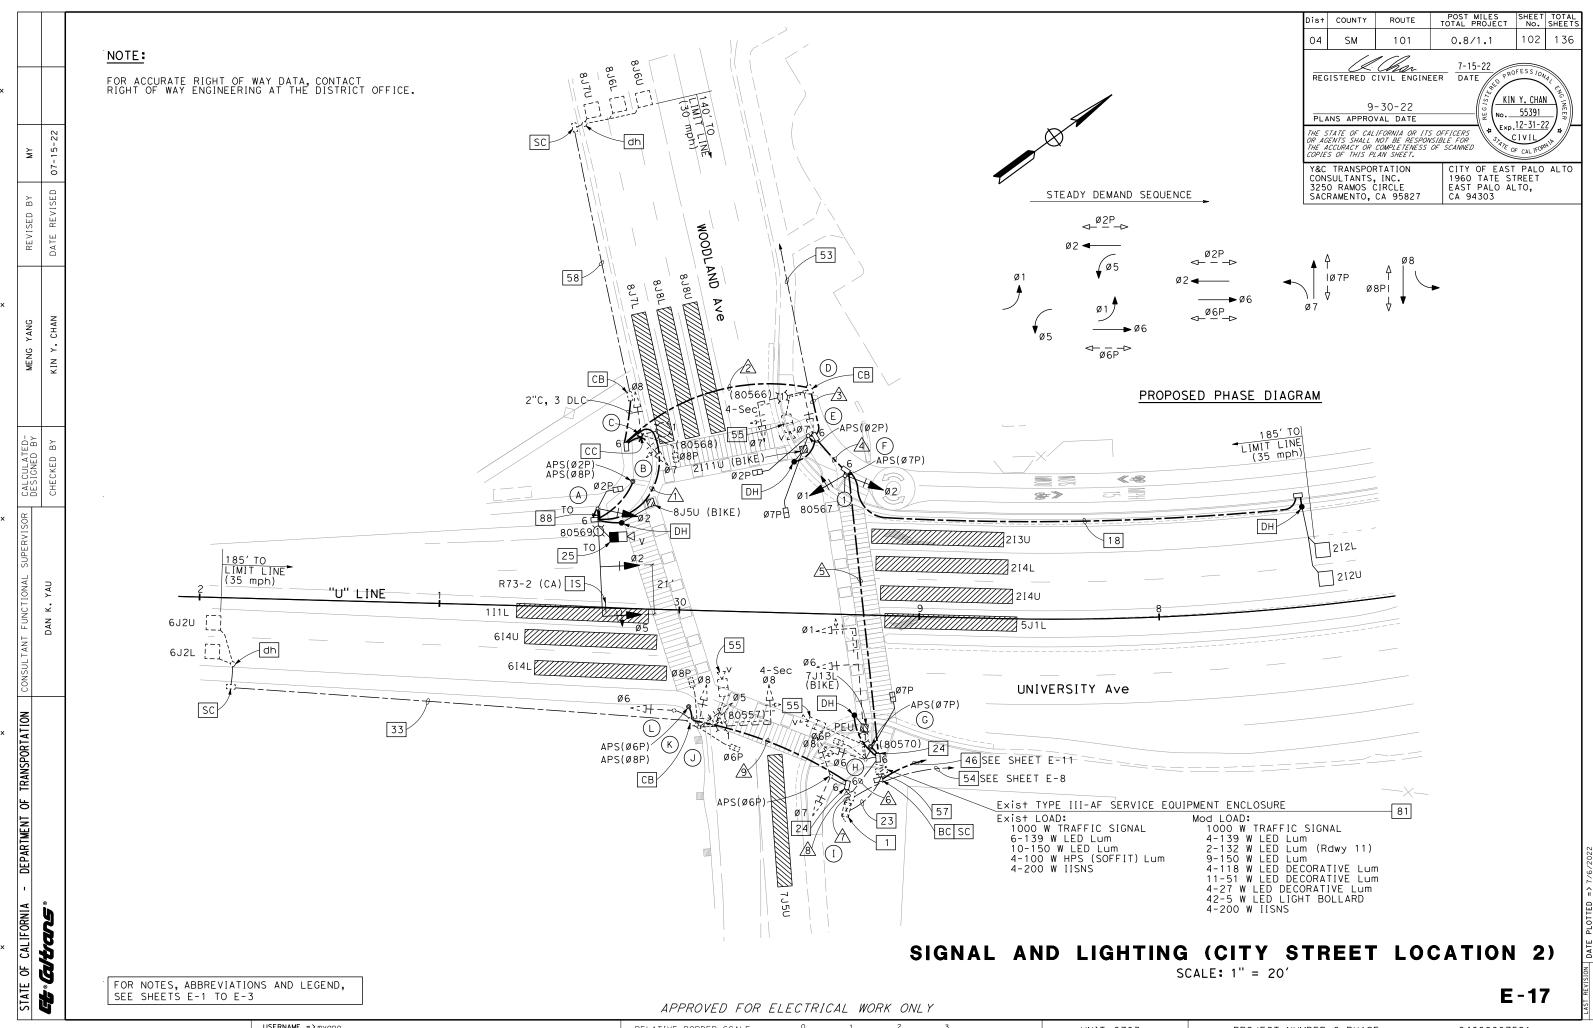

07-15-22

REVISED

STATE OF CALIFORNIA - DEPARTMENT OF TRANSPORTATION CONSULTANT FUNCTIONAL

GEOGRAPHICALES

DAN K. YAU

SCHEDULES: (FOR SHEET E-17)

	No. OF CONDUCTOR					ORS	RS		
CONDUCTOR SCHEDULE	(CONDUIT RUN NUMBER							
	1	/2\	/3\	4	/5\	1 6	$\sqrt{\lambda}$	/ 8\	/ 9\
No. 14 CONDUCTORS									
Ø1					3	3	3		
Ø2	3	3	3	3	3	3	3		
ø5	3	3	3	3	3	3	6	3	3
Ø6						3	6	3	3
Ø7		3	4	4	4	4	7	3	
Ø8		3	3	3	3	3	7	4	4
Ø2P	2	2	2	2	2	2	2		
Ø6P						2	4	2	2
Ø7P				2	2	2	2		
Ø8P		2	2	2	2	2	4	2	2
APS(Ø2P)	2	2	2	2	2	2	2		
APS(Ø6P)							2	2	2
APS(Ø7P)					2	2	2		
APS(Ø8P)	2	2	2	2	2	2	4	2	2
PEU						3	3		
SPARES	3	3	3	3	3	3	6	3	3
TOTAL No. 14	15	23	24	26	31	39	63	24	21
No. 10 CONDUCTORS									
IISNS	2	2	2	2	2	2	2	2	2
VIDEO DETECTION POWER	2	2	2	2	2	2	2	2	2
TOTAL No. 10	4	4	4	4	4	4	4	4	4
No. 8 CONDUCTORS									
LIGHTING	2	2	2	2	2	2	2	2	2
SIGNAL NEUTRAL	1	1	1	1	1	1	2	1	1
TOTAL No. 8	3	3	3	3	3	3	4	3	3
DETECTOR CABLES (DLC)									
2I11U (BIKE)				1	1	1	1		
212U/212L					2	2	2		
6J2U/6J2L							2	2	2
7J13L (BIKE)						1	1		
8J5U (BIKE)	1	1	1	1	1	1	1		
8J6U/8J6L		2	2	2	2	2	2		
8J7U		1	1	1	1	1	1		
TOTAL DETECTOR CABLES	1	4	4	5	7	8	10	2	2
VIDEO DETECTION COAX CABLE	1	1	2	2	2	3	4	1	1
SIGNAL INTERCONNECT CABLE			1	1	1	1	151		
APS CABLE	1			1		1			
CONDUIT SIZE (INCHES)	3	3	3	3	2- 3''	3	2- 3"	3	3
	N	N	N	N	N	E	E	Е	N
NEW/EXISTING CONDUIT (N/E)	IN	111	1.4						

NOTE: REMOVE ALL Exist CONDUCTORS/CABLES.
ADD ALL NEW CONDUCTORS/CABLES, UNLESS OTHERWISE NOTED.

= Exist CABLE TO REMAIN

Dist	COUNTY	ROUTE	POST MILES TOTAL PROJECT	SHEET No.	TOTAL SHEETS								
04	SM	101	101 0.8/1.1 103 1										
REG	REGISTERED CIVIL ENGINEER 9-30-22 7-15-22 PROFESS JONAGE (NO. 1975) KIN Y. CHAN (NO. 1975) REGISTERED CIVIL ENGINEER (NO. 1975) STORY (NO. 1975) REGISTERED CIVIL ENGINEER (NO. 1975) REGISTERED CIVIL ENGINEER (NO. 1975) 9-30-22												
THE S OR AG THE A	PLANS APPROVAL DATE THE STATE OF CALIFORNIA OR ITS OFFICERS OR AGENTS SHALL NOT BE RESPONSIBLE FOR THE ACCURACY OR COMPLETENESS OF SCANNED COPIES OF THIS PLAN SHEFT.												
Y&C TRANSPORTATION CITY OF EAST PALO ALTO CONSULTANTS, INC. 1960 TATE STREET EAST PALO ALTO, CA 94303													

							POLE	AND	EQUIPMENT S	СНЕ	DULE		
	STANDARD		Veh Sig Mtg				Ped Sig		APS				
No.	TYPE	SMA	LMA	ø	MAST ARM	Ø	POLE	Ø	M+g	Ø	ARROW	LED Lum	REMARKS
A	26-4-100	45′	15′	5	MAS	2	SV-1-T	2	SP-1-T			Rdwy 11	SEE LEGEND 25 AND 88. IS R73-2(CA).
				2	MAS								
B	PBA POST				-	2 8				2 8	—		
	Fyic+					7				0			
©	Exist 15				-	8	SV-2-TA	8	SP-1-T			139 W	SEE LEGEND 91.
D	Exist 17-3-129	20′	15′	7	MAS-4B	7	SV-1-T					139 W	SEE LEGEND 55 AND 91.
E	1-B (7')							2 7	TP-2-T	2			
F	15TS		15′			1	SV-2-TA			7		Rdwy 11	
G	PBA POST									7			
H	Exist 29-5-29	55′	15′	1 6	MAS MAS	6	SV-1-T	6 7+	SP-2-T			139 W	SEE LEGEND 55.
<u> </u>	Exist 1-B					7	TV-2-T			6			
J	Exist 19-3-129	30′	15′	8	MAS-4B	5 8	SV-2-TA	6 8	SP-2-T			139 W	SEE LEGEND 55.
K	PBA POST									6 8	←		
L	Exist 1-B					6	TV-1-T						ALL EXISTING EQUIPMENT TO REMAIN.
	INICTALL NEW		TO F :								•		


⁺ INSTALL NEW EQUIPMENT TO Exist SIGNAL STANDARD

SIGNAL AND LIGHTING (CITY STREET LOCATION 2)

SCALE: 1" = 20'

E-18

USERNAME => myang DGN FILE => E-18 SCH 2 UNIT 0703 PROJECT NUMBER & PHASE 04000007591 BORDER LAST REVISED 7/2/2010

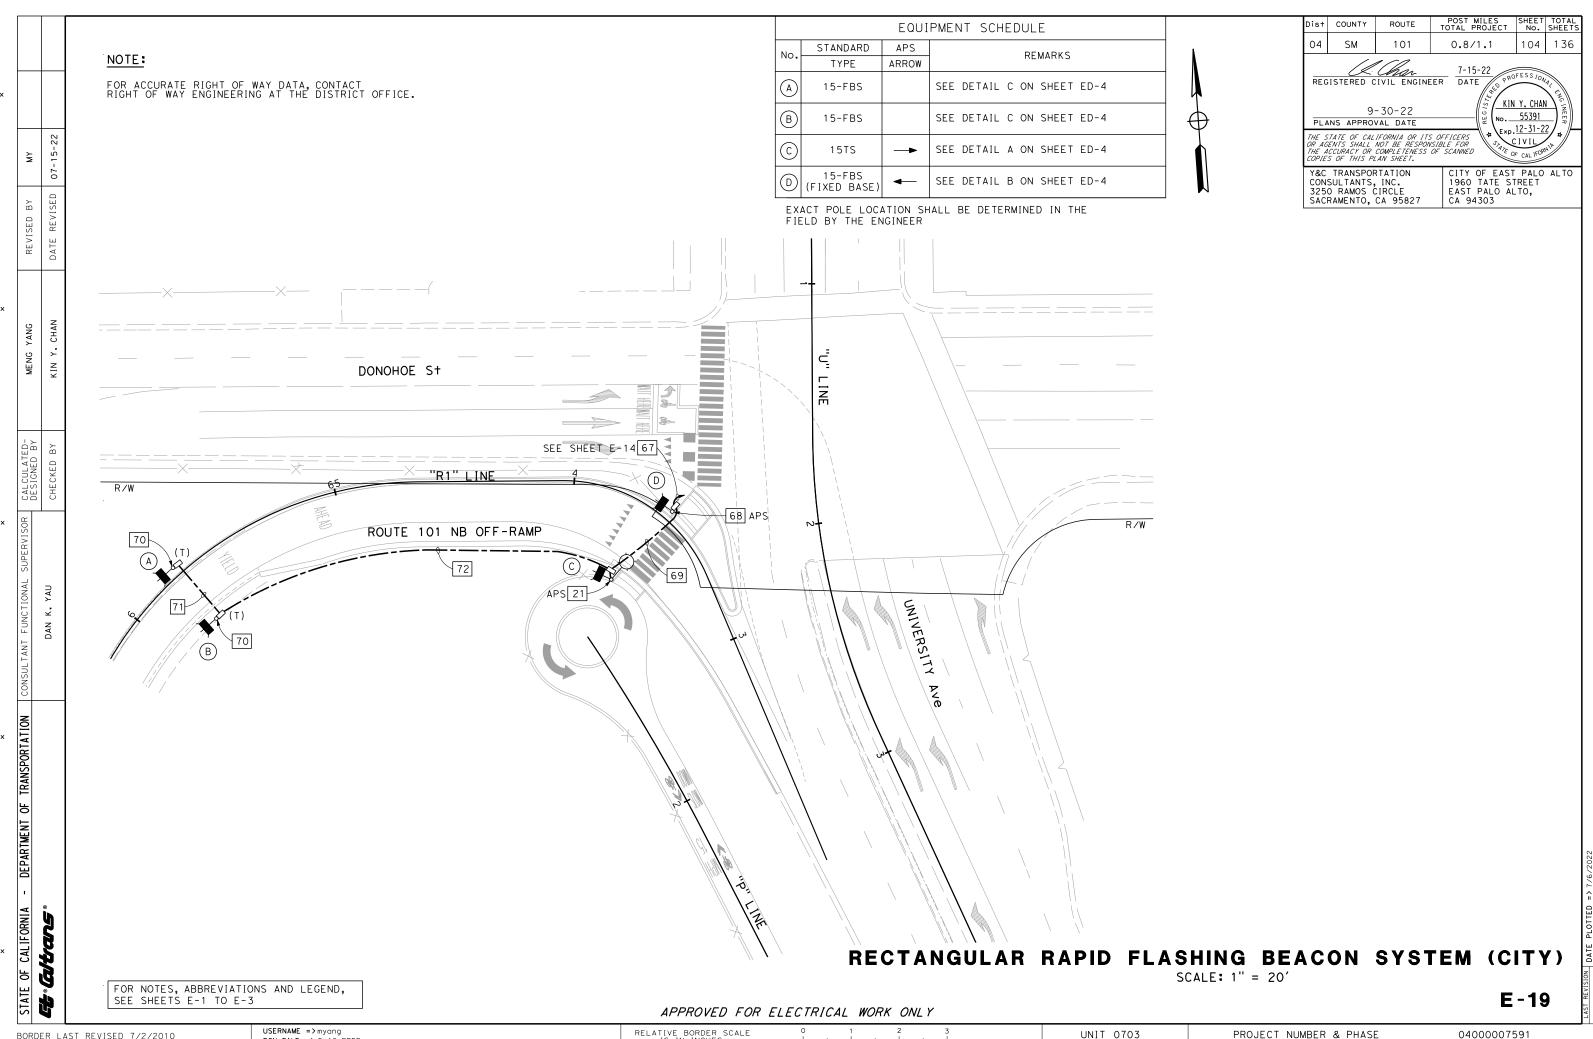

DGN FILE => E-19 RRFB

RELATIVE BORDER SCALE IS IN INCHES

UNIT 0703

VΩ	TE	C	•
v	1 🗅	J	•

- 1. WELDING MUST COMPLY WITH STANDARD SPECIFICATION SECTION 75.
- 2. CONDUITS ENTERING THE PULL BOX MUST BE ENCASED IN PCC (3" ALL AROUND), PCC ENCASEMENT MUST EXTEND 5'-6" FROM THE PULL BOX.
- 3. FOR ADDITIONAL NOTES AND DETAILS, SEE STANDARD PLANS RSP ES-8B.

st	COUNTY	ROUTE	POST MILES TOTAL PROJECT	SHEET No.	TOTAL SHEETS					
)4	SM	101	0.8/1.1	105	136					
11 Chan 7-15-22 OROFESS 100										

REGISTERED CIVIL ENGINEER

9-30-22

PLANS APPROVAL DATE


THE STATE OF CALIFORNIA OR ITS OFFICERS
REAGENTS SHALL NOT BE RESPONSIBLE FOR

THE STATE OF CALIFORNIA OR ITS OFFICERS
OR AGENTS SHALL NOT BE RESPONSIBLE FOR
THE ACCURACY OR COMPLETENESS OF SCANNED
COPIES OF THIS PLAN SHEET.

YAC TRANSPORTATION
CITY OF FAST

Y&C TRANSPORTATION
CONSULTANTS, INC.
3250 RAMOS CIRCLE
SACRAMENTO, CA 95827

CA 94303

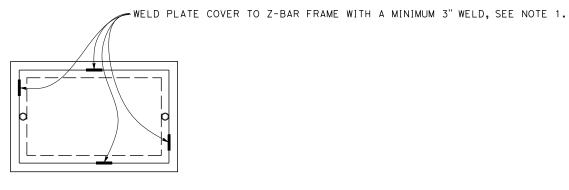

TOP VIEW

TRAFFIC PULL BOX WELDING DETAIL

ELECTRICAL SYSTEMS DETAILS

NO SCALE

ED-1

(TRAFFIC PULL BOX DETAIL)


BORDER LAST REVISED 7/2/2010


USERNAME => myang
DGN FILE => ED-1

RELATIVE BORDER SCALE
0 1 2 3
UNIT 0703

PROJECT NUMBER & PHASE 0400007591

106 136 101 0.8/1.1 7-15-22 DATE REGISTERED CIVIL ENGINEER KIN Y. CHAN 9-30-22 55391 PLANS APPROVAL DATE Exp. 12-31-22 THE STATE OF CALIFORNIA OR ITS OFFICERS
OR AGENTS SHALL NOT BE RESPONSIBLE FOR
THE ACCURACY OR COMPLETENESS OF SCANNED
TOPIES OF THIS PLAN SHEET. . CIVIL CITY OF EAST PALO ALTO 1960 TATE STREET EAST PALO ALTO, CA 94303 SACRAMENTO, CA 95827

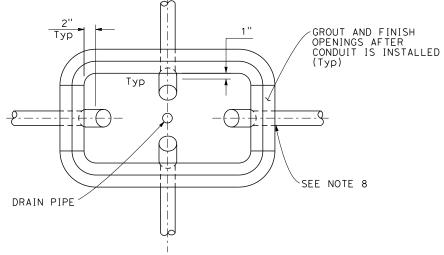

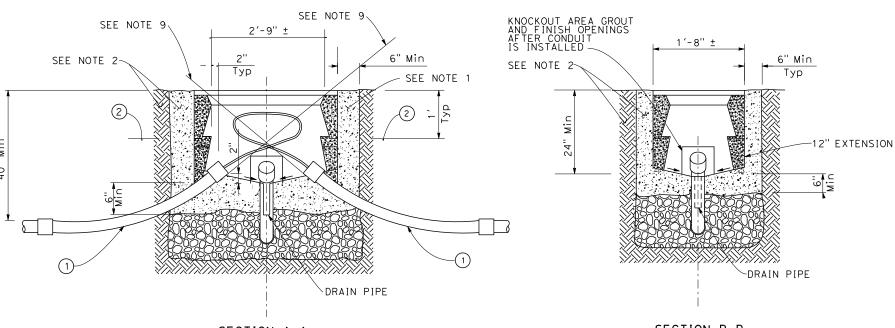

ELECTRICAL SYSTEMS DETAILS


ED-2


BORDER LAST REVISED 7/2/2010

DGN FILE => ED-2

UNIT 0703

PROJECT NUMBER & PHASE

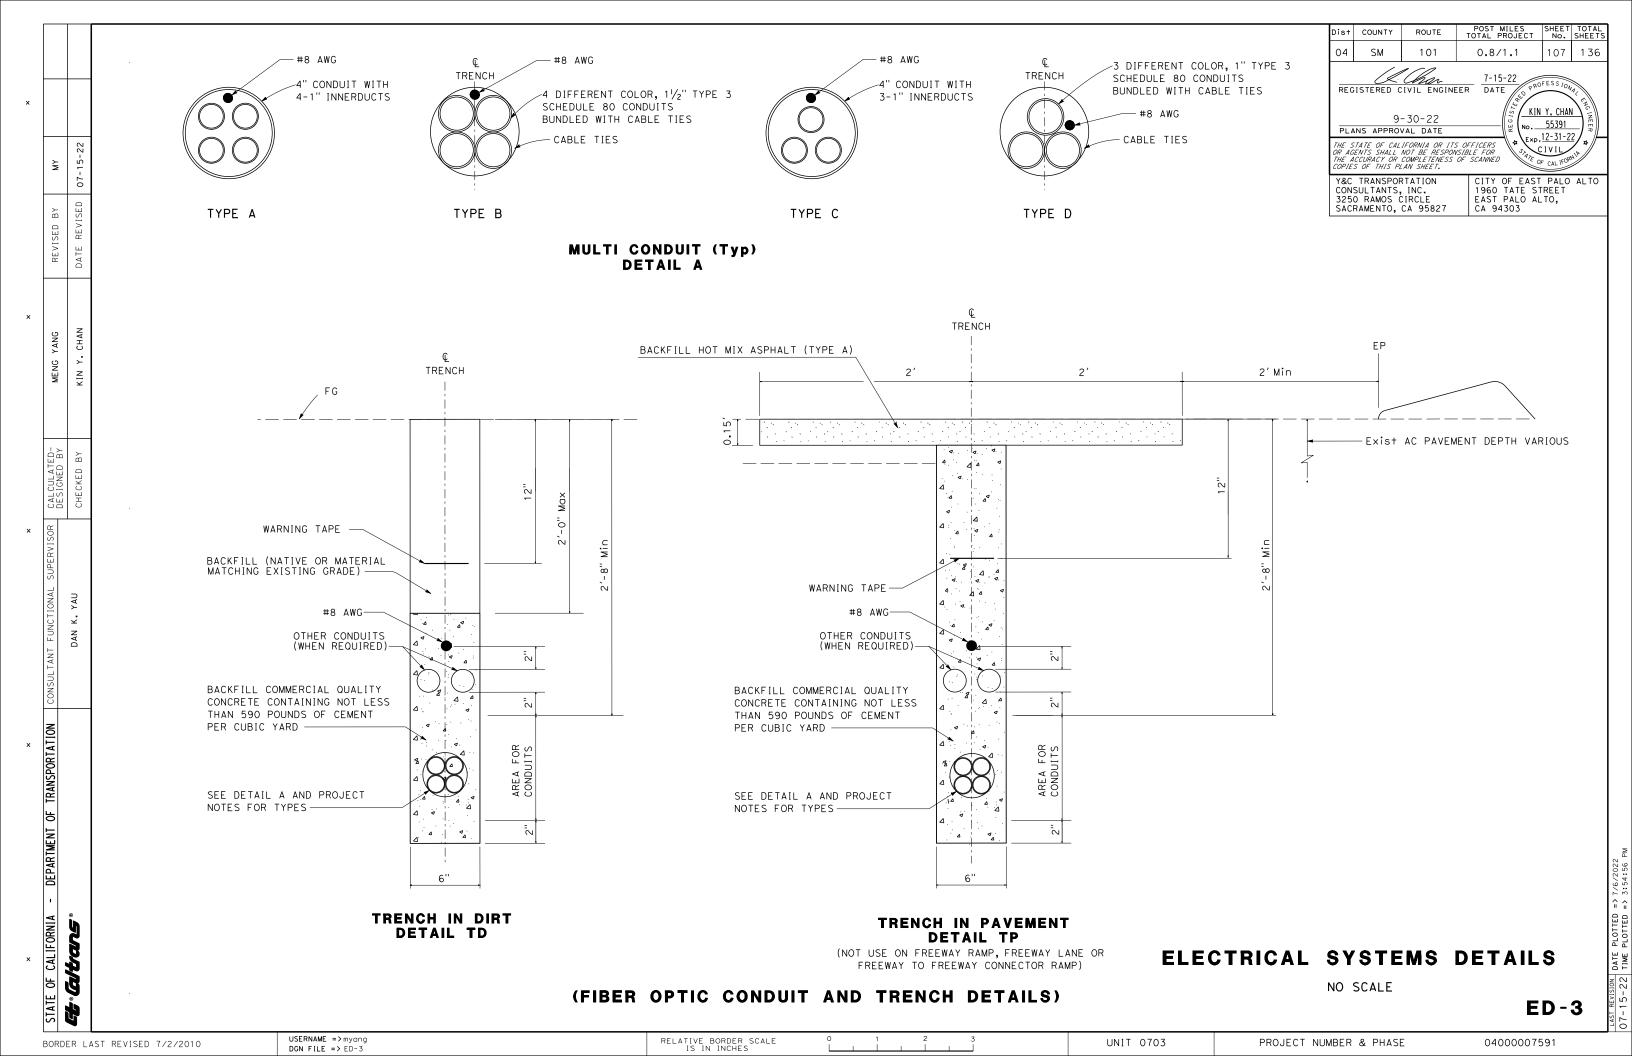

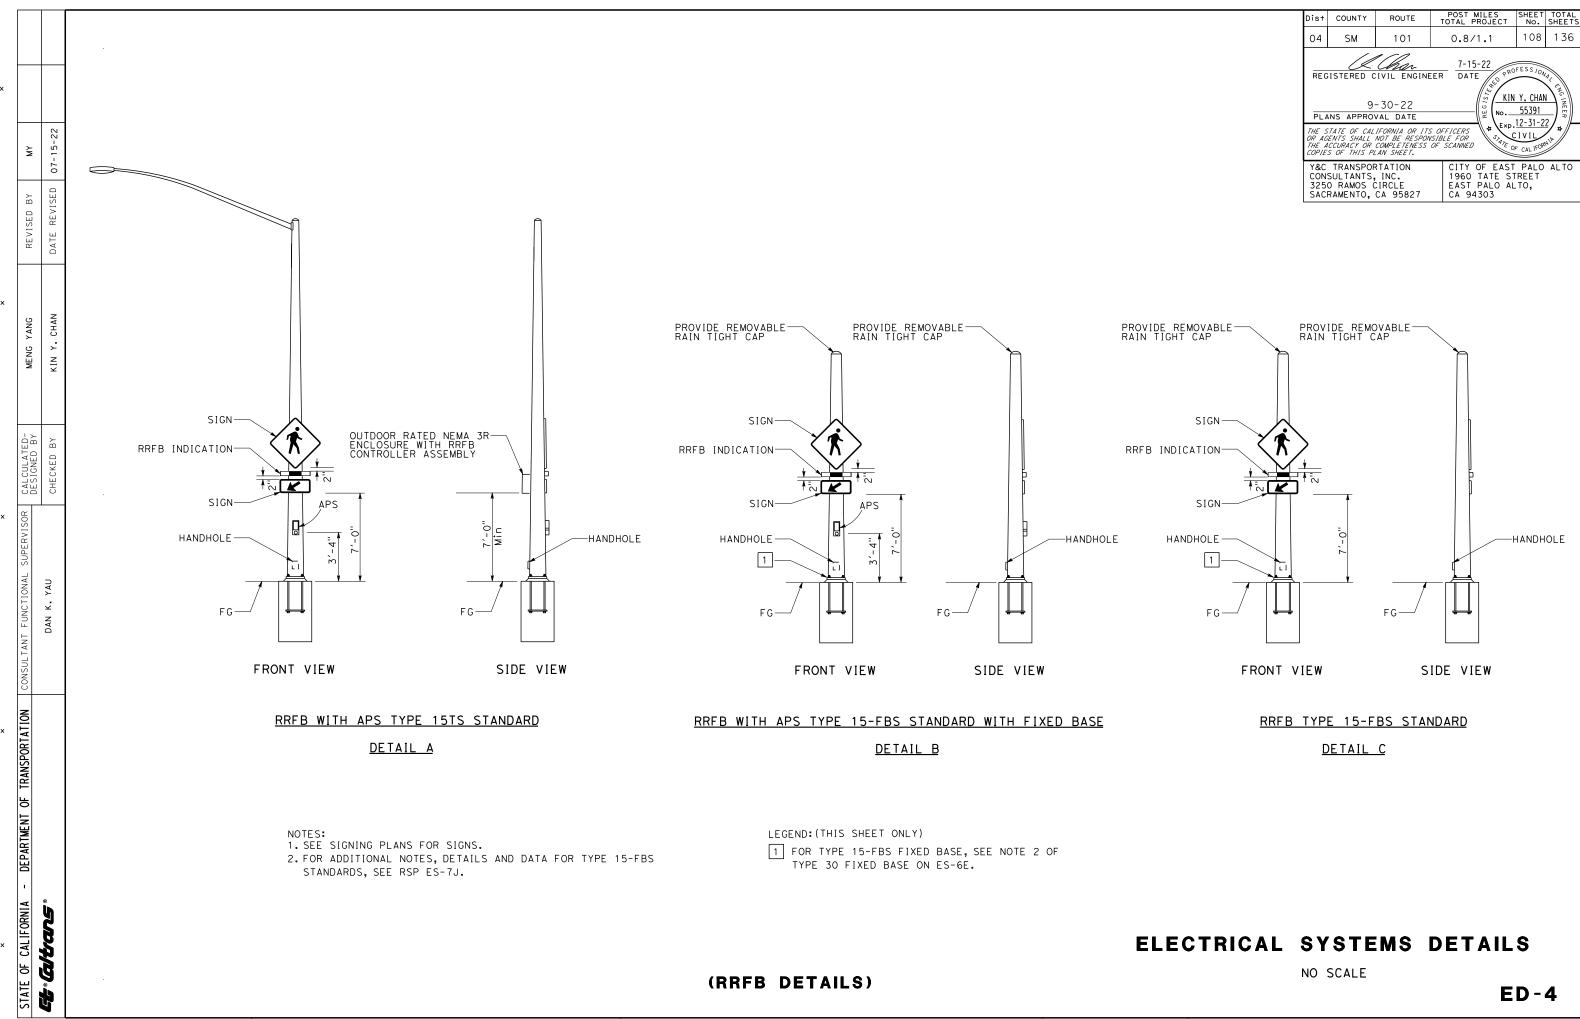

DGN FILE => ED-4

UNIT 0703

PROJECT NUMBER & PHASE

10	T	Ε	:	
			_	

ELECTRICAL SYSTEMS QUANTITY TABLES SUMMARIZE SIGNIFICANT COMPONENTS. SEE ELECTRICAL SYSTEMS PLANS AND SPECIFICATIONS TO DETERMINE ALL MATERIALS NEEDED FOR EACH SYSTEM.

ist	COUNTY	ROUTE	POST MILES TOTAL PROJECT	SHEET No.	TOTAL SHEETS
)4	SM	101	0.8/1.1	109	136

KIN Y. CHAN

55391

REGISTERED CIVIL ENGINEER 7-15-22
DATE

9-30-22 PLANS APPROVAL DATE

Y&C TRANSPORTATION
CONSULTANTS, INC.
3250 RAMOS CIRCLE
SACRAMENTO, CA 95827

CA 94303

MODIFYING LIGHTING SYSTEMS

E-4		SHEET NO.
4		No. 5(T) PB
1		No. 6(T) PB
2	EΑ	Rdwy 12 LED Lum
1		TYPE 30 POLE WITH 15' LMA AND Fdn
1		TYPE 31 POLE WITH 20' LMA E S
150		11/2" TYPE 3 CONDUIT
645	L	2" TYPE 3 CONDUIT
1260	F	#14 AWG
1590		#6 AWG

(N) - NOT A SEPARATE BID ITEM

MODIFYING SIGNAL AND LIGHTING SYSTEMS

											(N)										
SHEET NO.	OCATION	No. 5 PB	No. 6 PB	LOOP DETECTOR, TYPE A	LOOP DETECTOR, TYPE D	Rdwy 11 LED Lum	TYPE 29-5-100 POLE WITH 55' SMA, 15' LMA & Fdn	TYPE 29-5-100 POLE WITH 50' SMA, 15' LMA & Fdn	TYPE 19-4-100 POLE WITH 25' SMA, 15' LMA & Fdn	SIGNAL 3-12" (HOUSING, BACKPLATE, LED)	SIGNAL 4-12" (HOUSING, BACKPLATE, LED)	DETECTOR HANDHOLE	SV-1-T M+g	SV-2-TB M+9	2" TYPE 3 CONDUIT	3" TYPE 3 CONDUIT	#14 AWG	#8 AWG	#6 AWG	SIC	DLC
							ΕA											LF			
E-8	3	6	6	46	13	3	1	1	1	9	1	9	2	2	530	350	3050	300	950	500	4150

(N) - NOT A SEPARATE BID ITEM

MODIFYING FIBER OPTIC CABLE SYSTEMS

		1)	۷)	
SHEET NO.	FO PB	11/2" TYPE 3 CONDUIT	12-STRAND SMFO CABLE	#8 AWG
	EΑ		LF	
E-5	1	3260	865	815
E-6	1	1520	525	380
E-10			525	

(N) - NOT A SEPARATE BID ITEM

LIGHTING (CITY STREET)

					۷)					
SHEET No.	No. 5 PB	No. 6 PB	NEMA 4 JUNCTION BOX	PEDESTRIAN LIGHT WITH S+d & Fdn	STREET/PEDESTRIAN LIGHT WITH S+d & Fdn	LIGHT BOLLARD	/2" TYPE 1 CONDUIT	2" TYPE 1 CONDUIT	2" TYPE 3 CONDUIT	#4 AWG
			E	Α				L	.F	
E-10	10	2		8	1	·			900	1800
E-11	9			3	3				1200	2400
E-12			6			42	550	600		1800

(N) - NOT A SEPARATE BID ITEM

ELECTRICAL SYSTEMS QUANTITIES

EQ-1

BORDER LAST REVISED 7/2/2010

USERNAME =>myang DGN FILE => EQ-1 RELATIVE BORDER SC. IS IN INCHES 0 1 2 3

UNIT 0703

PROJECT NUMBER & PHASE

1000007501

OTE	:
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ELECTRICAL SYSTEMS QUANTITY TABLES SUMMARIZE SIGNIFICANT COMPONENTS. SEE ELECTRICAL SYSTEMS PLANS AND SPECIFICATIONS TO DETERMINE ALL MATERIALS NEEDED FOR EACH SYSTEM.

DGN FILE => EQ-2

SIGNAL AND LIGHTING (CITY STREET LOCATION 1)

							(N	1)				
SHEET NO.	TYPE A LOOP DETECTOR	TYPE D LOOP DETECTOR	DETECTOR HANDHOLE	No. 6 PB	PBA POST AND Fdn	SAA	PEDESTRIAN SIGNAL HEAD	3" TYPE 3 CONDUIT	#8 AWG	APS CABLE	SIC	DLC
				EΑ					LF			
E-14	29	11	8	2	1	6	6	160	190	245	115	160

(N) - NOT A SEPARATE BID ITEM

SIGNAL AND LIGHTING (CITY STREET LOCATION 2)

													(N)										
SHEET NO.	26-4-100 Std AND Fdn	TYPE 15 Std AND Fdn	TYPE 1 S+d AND Fdn	PBA POST AND Fdn	TYPE A LOOP DETECTOR	TYPE D LOOP BIKE DETECTOR	Rdwy 11 LED Lum	3-SECTION 12" SIGNAL HEADS	MAS M+g	SV-2-TA Mtg	SV-1-T M+9	SP-2-T M+9	SP-1-T M+9	TP-2-T M+9	DE TECTOR HANDHOLE	No. 5 PB	No. 6 PB	2" TYPE 3 CONDUIT	3" TYPE 3 CONDUIT	#8 AWG	#10 AWG	#14 AWG	DLC
									E	Α										L	.F		
E-17	1	1	1	3	2	3	1	5	2	1	1	1	3	1	4	1	7	250	550	1350	1800	11050	3000

(N) - NOT A SEPARATE BID ITEM

RECTANGULAR RAPID FLASHING BEACON SYSTEM (CITY)

				·			(N))				
SHEET NO.	RRFB CONTROLLER ASSEMBLY	TYPE 15 S+d AND Fdn	TYPE 15-FBS S+d AND Fdn	Rdwy 11 LED Lum	RRFB LIGHT BAR	APS	No. 5 PB	No. 5(T) PB	11/2" TYPE 3 CONDUIT	#8 AWG	RRFB APS CABLE	RRFB LIGHT BAR CABLE
		<u>EA</u> <u>LF</u>										
E-19	1	1	3	1	4	2	2	2	260	160	50	200

(N) - NOT A SEPARATE BID ITEM

ELECTRICAL SYSTEMS QUANTITIES

Dist COUNTY

SM

101

REGISTERED CIVIL ENGINEER DATE

9-30-22

THE STATE OF CALIFORNIA OR ITS OFFICERS OR AGENTS SHALL NOT BE RESPONSIBLE FOR THE ACCURACY OR COMPLETENESS OF SCANNED COPIES OF THIS PLAN SHEET.

PLANS APPROVAL DATE

Y&C TRANSPORTATION

CONSULTANTS, INC.
3250 RAMOS CIRCLE
SACRAMENTO, CA 95827

04

04000007591

110

KIN Y. CHAN

55391


Exp. 12-31-22 CIVIL


CITY OF EAST PALO ALTO 1960 TATE STREET EAST PALO ALTO, CA 94303

0.8/1.1

7-15-22

136

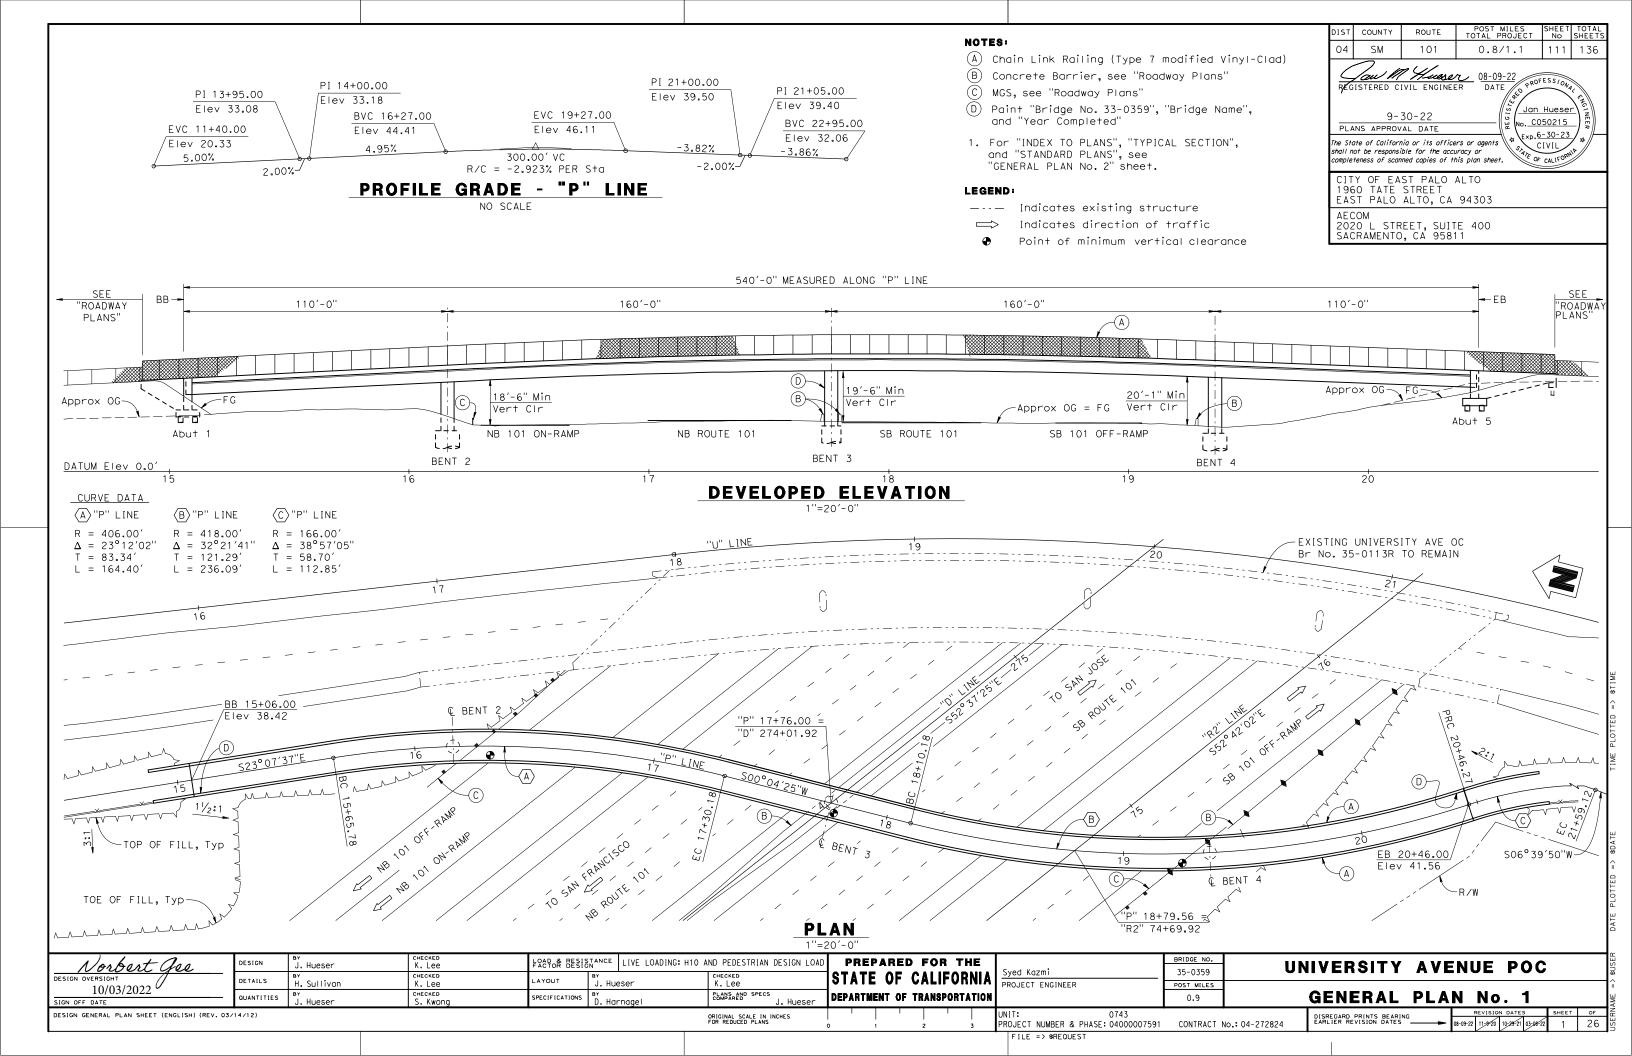

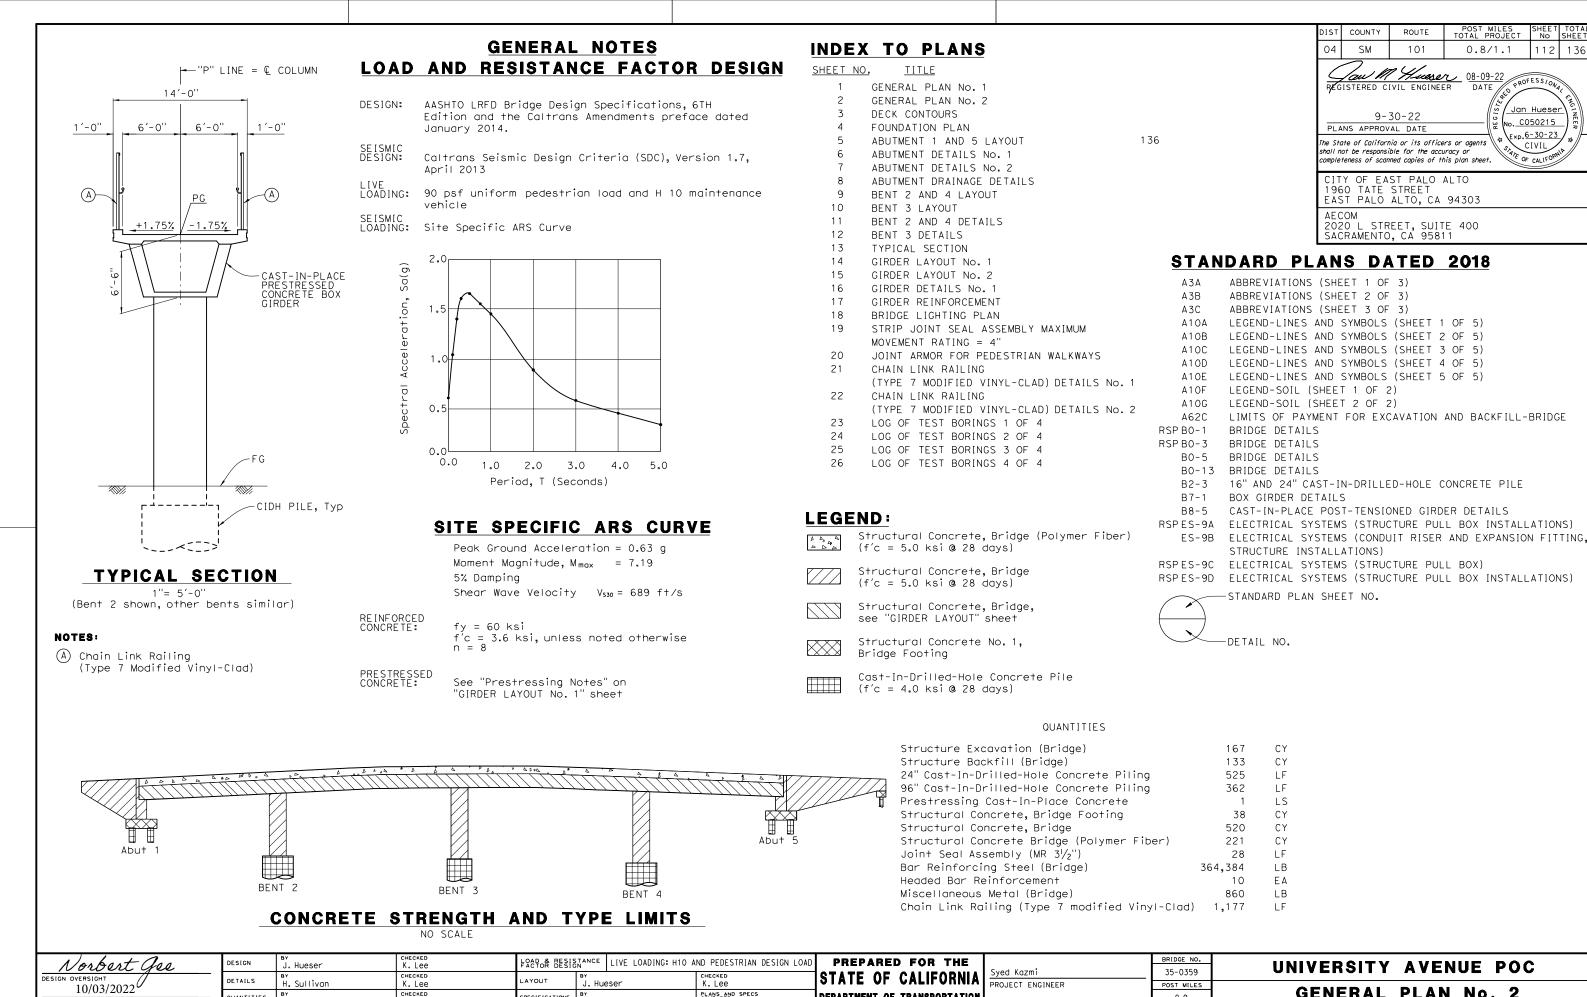

PLANS AND SPECS

ORIGINAL SCALE IN INCHES FOR REDUCED PLANS

SPECIFICATIONS | BY D. Harnagel

вү J. Hueser

QUANTITIES

SIGN OFF DATE

DESIGN GENERAL PLAN SHEET (ENGLISH) (REV. 03/14/12)

PROJECT NUMBER & PHASE: 04000007591 CONTRACT No.: 04-272824 FILE => \$REQUEST

0.9

DEPARTMENT OF TRANSPORTATION

GENERAL PLAN No. 2 REVISION DATES 08-09-22 11-9-20 10-29-21 03-08-22 DISREGARD PRINTS BEARING EARLIER REVISION DATES

0.8/1.1

112

Jan Hueser


. C050215

×p.6-30-23

CIVIL

OF CALIFOR

136

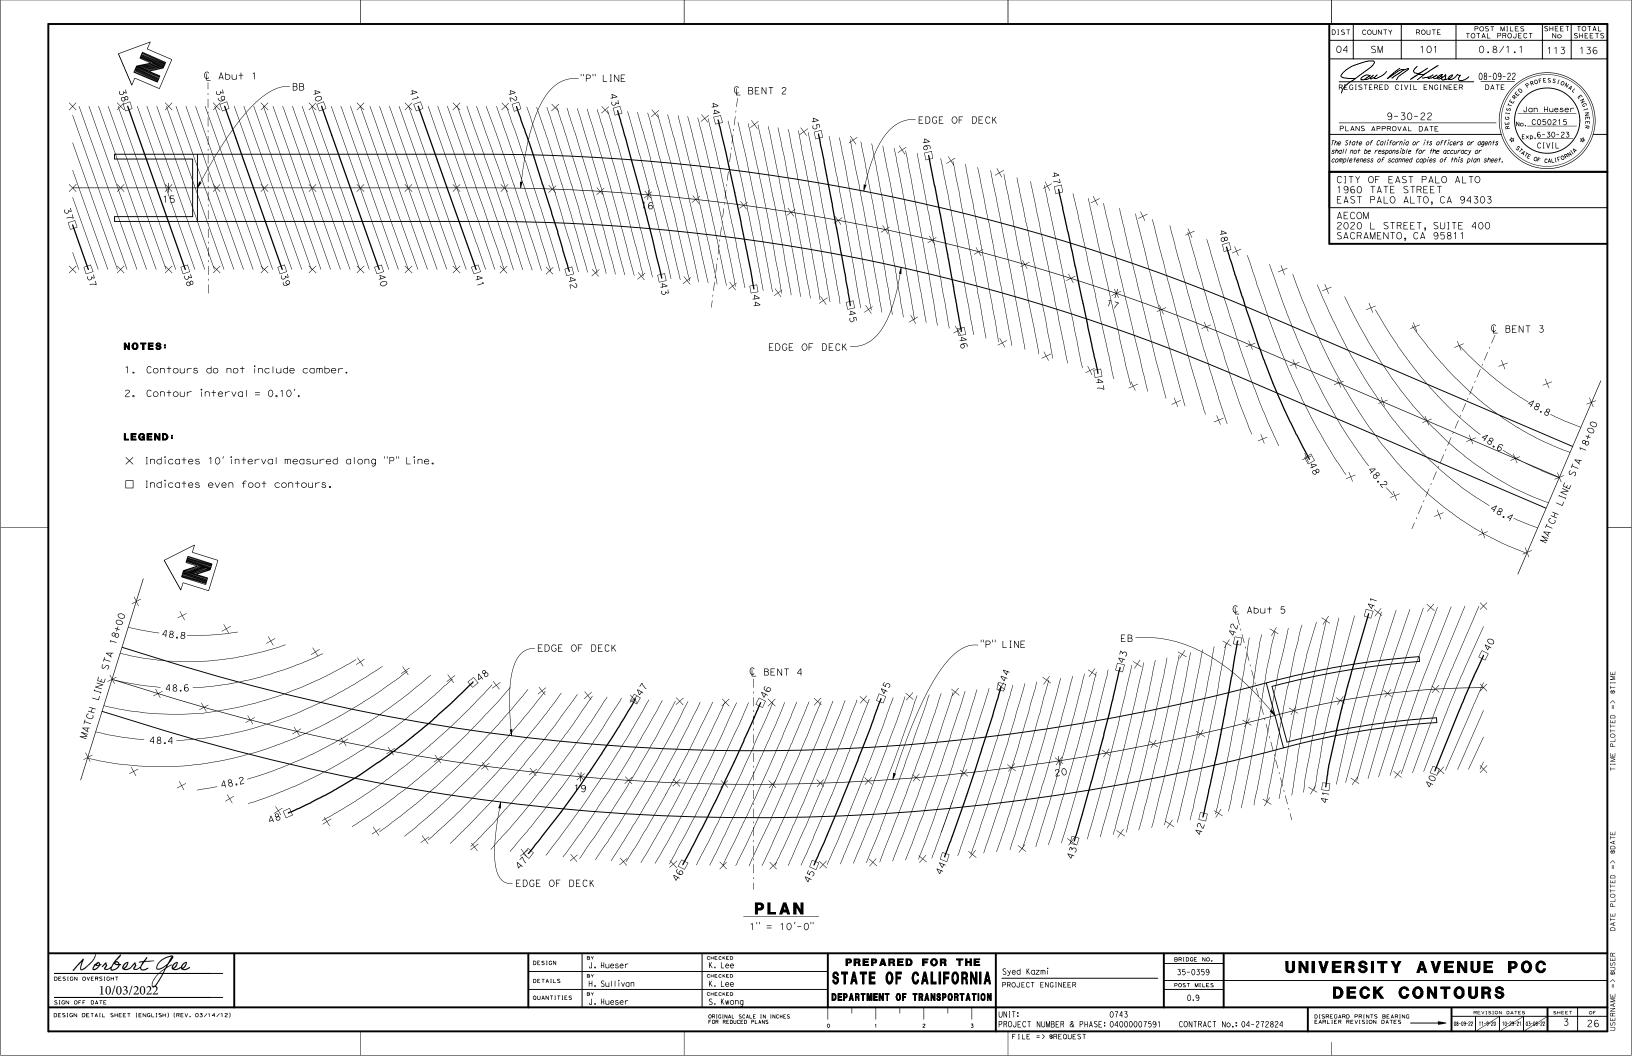

LOCATION	PILE TYPE	NOMINAL RES (kips		DESIGN TIP ELEVATION	SPECIFIED TIP ELEVATION	SPECIFIED STEEL CASING TIP ELEVATION
		COMPRESSION TENSION		(f+)	(f+)	(f+)
Abut 1	24"Ø CIDH	230	0	-15(A), 4(C), 1(D)	-15	NA
BENT 2	96"Ø CIDH WITH PERMANENT STEEL CASING	1,830	0	-74(A), -120(C), -13(D)	-120	0
BENT 3	96"Ø CIDH WITH PERMANENT STEEL CASING	1,940	0	-76(A), -95(C), -15(D)	- 95	8
BENT 4	96"Ø CIDH WITH PERMANENT STEEL CASING	1,840	0	-74(A), -106(C), -13(D)	-106	0
Abut 5	24"Ø CIDH	250	0	-15(A), 9(C), O(D)	-15	NA
Abut 5 WW Lt	24"Ø CIDH	60	0	12(A)	12	NA
Abut 5 WW Rt	24"Ø CIDH	60	0	12(A)	12	NA

10/03/2022

FOUNDATION PLAN SHEET (ENGLISH) (REV. 03/14/12)

		В	ENCH	MARK
BENCH MARK	Ν	E	ELEV	DESCRIPTION
93	1995150	6085242	17.32	MAG NAIL AND SHINER IN AC @ SE CORNER OF UINIVERSITY AVE AND WOODLAND AVE, NEXT TO "NO PED CROSSING" SIGN
92	1993359	6085190	33.63	CUT "X" IN SIDEWALK @ NE CORNER OF UNIVERSITY AVE AND DONOHOE STREET

PROJECT ENGINEER

FILE => \$REQUEST

UNIT: 0743 PROJECT NUMBER & PHASE: 04000007591

DEPARTMENT OF TRANSPORTATION

SURVEY CONTROL HORIZONTAL CONTROL FOR THIS SURVEY IS BASED ON THE CALIFORNIA COORDINATE SYSTEM, ZONE 3, US SURVEY FEET, NORTH AMERICAN DATUM OF 1983 (NAD83 2007), VERTICAL CONTROL IS THE NORTH AMERICAN VERTICAL DATUM (NAVD88 RCFCD).

The State of California or its officers or agents shall not be responsible for the accuracy or completeness of scanned copies of this plan sheet.	
CITY OF EAST PALO ALTO 1960 TATE STREET EAST PALO ALTO, CA 94303	
AECOM 2020 L STREET, SUITE 400 SACRAMENTO, CA 95811	

0.8/1.1

114 | 136

Jan Hueser

o. C050215

xp.6-30-23 CIVIL

CURVE DATA					
CURVE	R	Δ	T	L	
A	406.00′	23°12′02"	83.34′	164.40′	
B	418.00′	32°21′41"	121.29′	236.09′	
(C)	166.00′	38°57′05"	58.70′	112.85′	

LEGEND:

04

 SM

---- Indicates existing structure Indicates CIDH Pile

9-30-22

PLANS APPROVAL DATE

Indicates bottom of footing elevation


Approximate location of Settlement Monitoring Point

FOUNDATION PLAN

DISREGARD PRINTS BEARING EARLIER REVISION DATES

CONTRACT No.: 04-272824

REVISION DATES 08-09-22 11-9-20 10-29-21 03-08-22

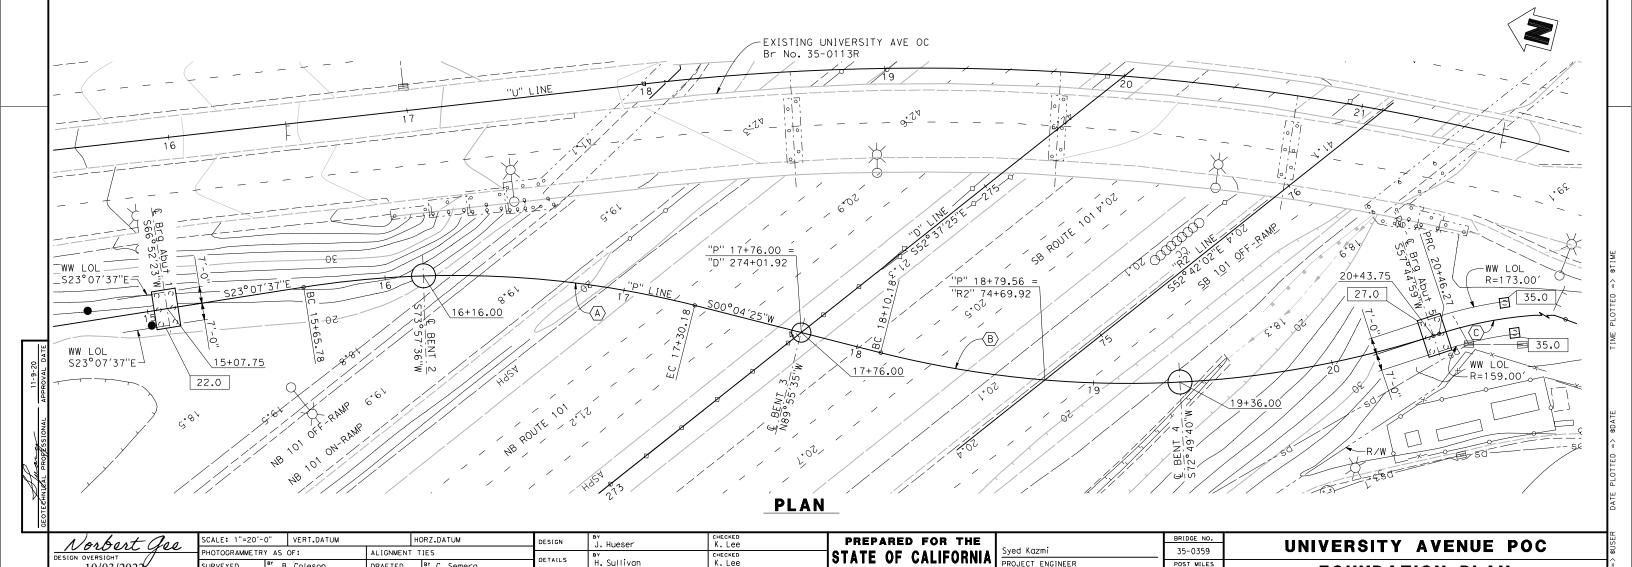

DETAILS

QUANTITIES

BY C. Semera

BY D. Scott

DRAFTED

CHECKED


B. Coleson


D. Scott


H. Sullivan


CHECKED S. Kwong


ORIGINAL SCALE IN INCHES FOR REDUCED PLANS

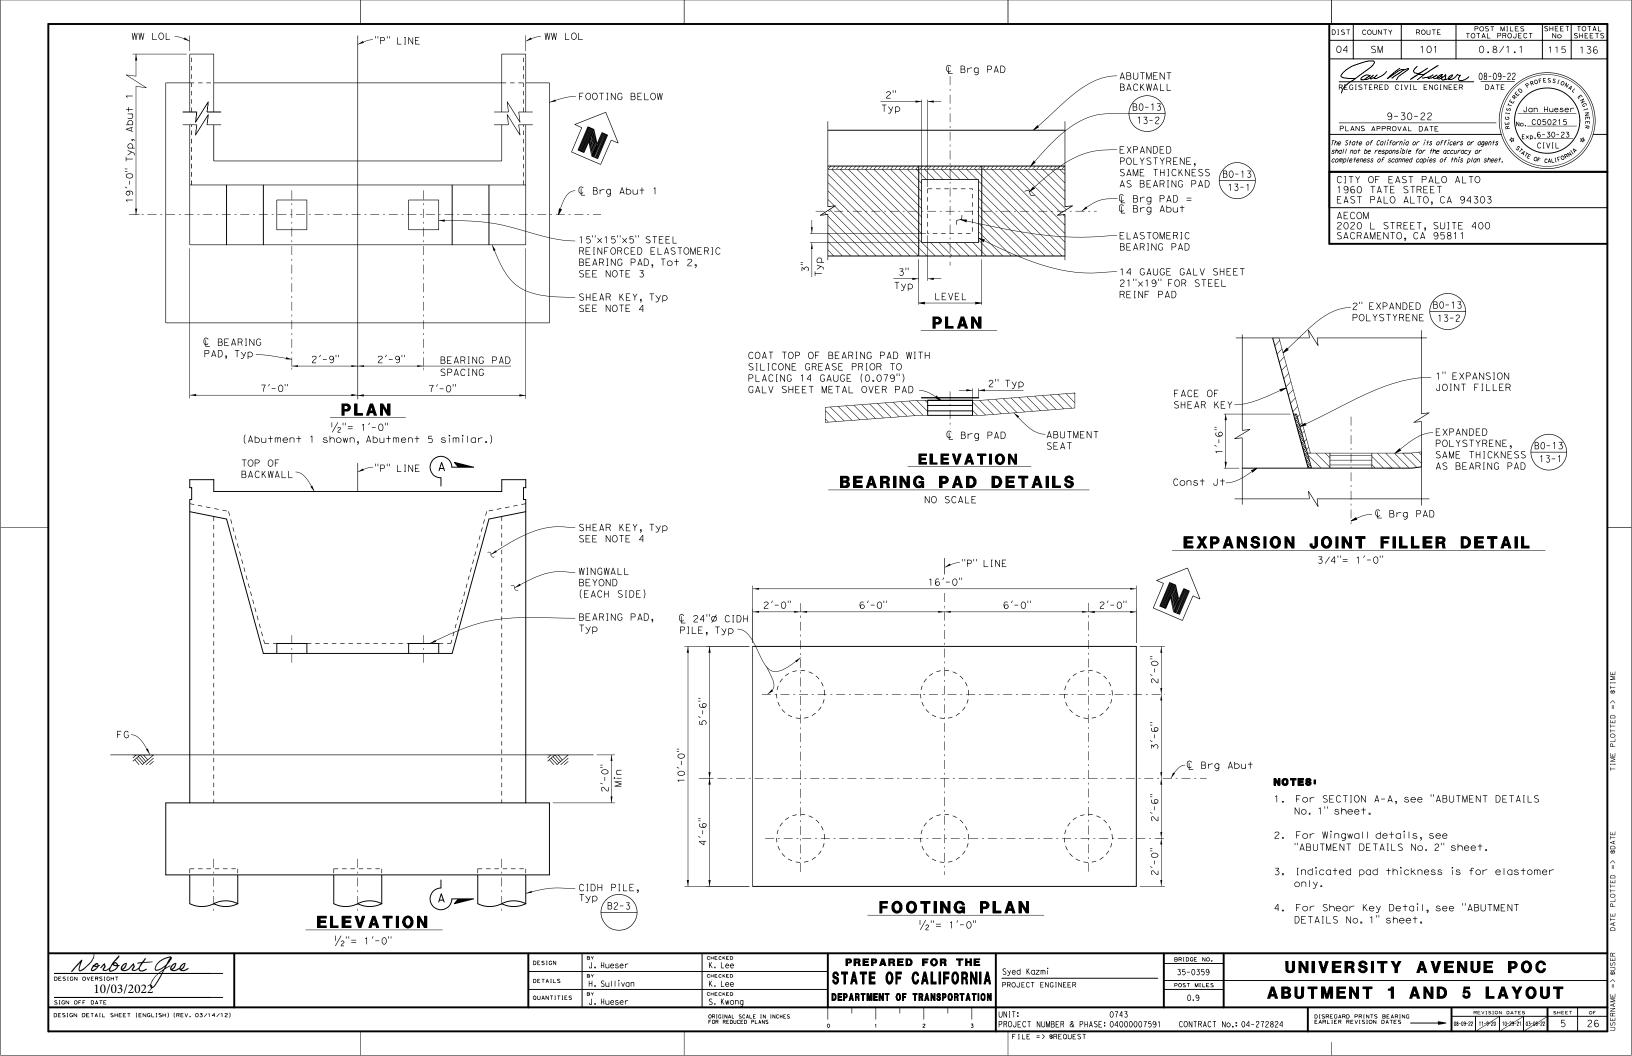


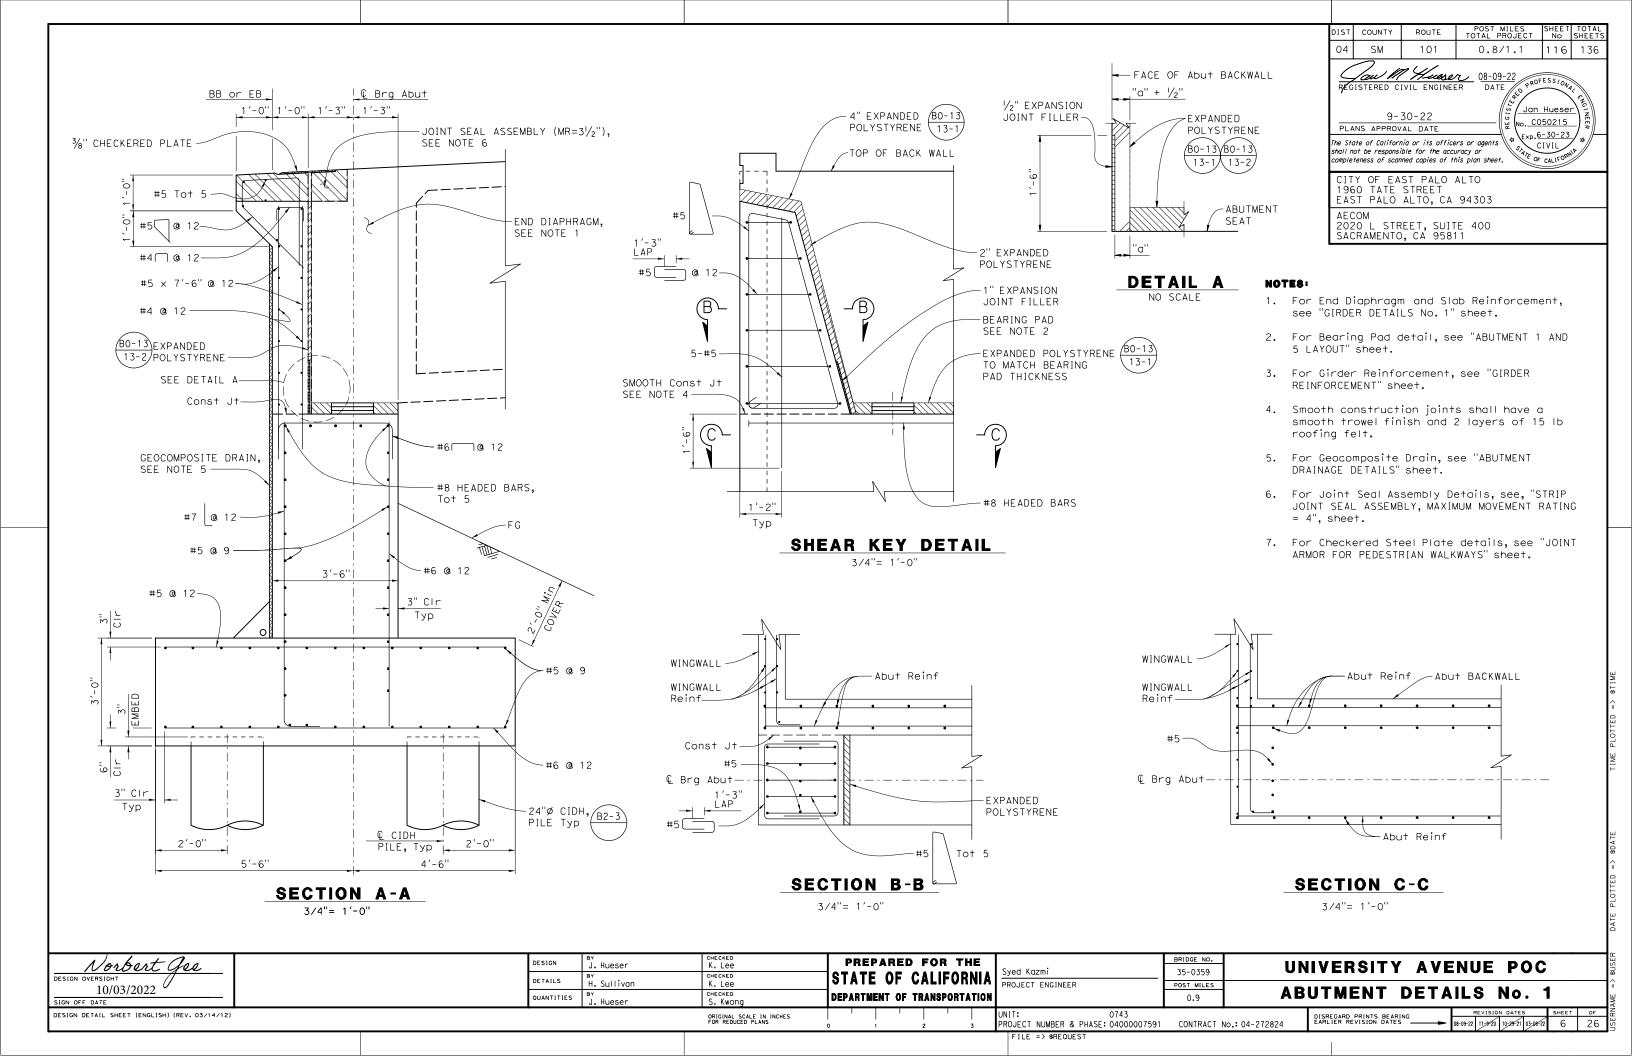

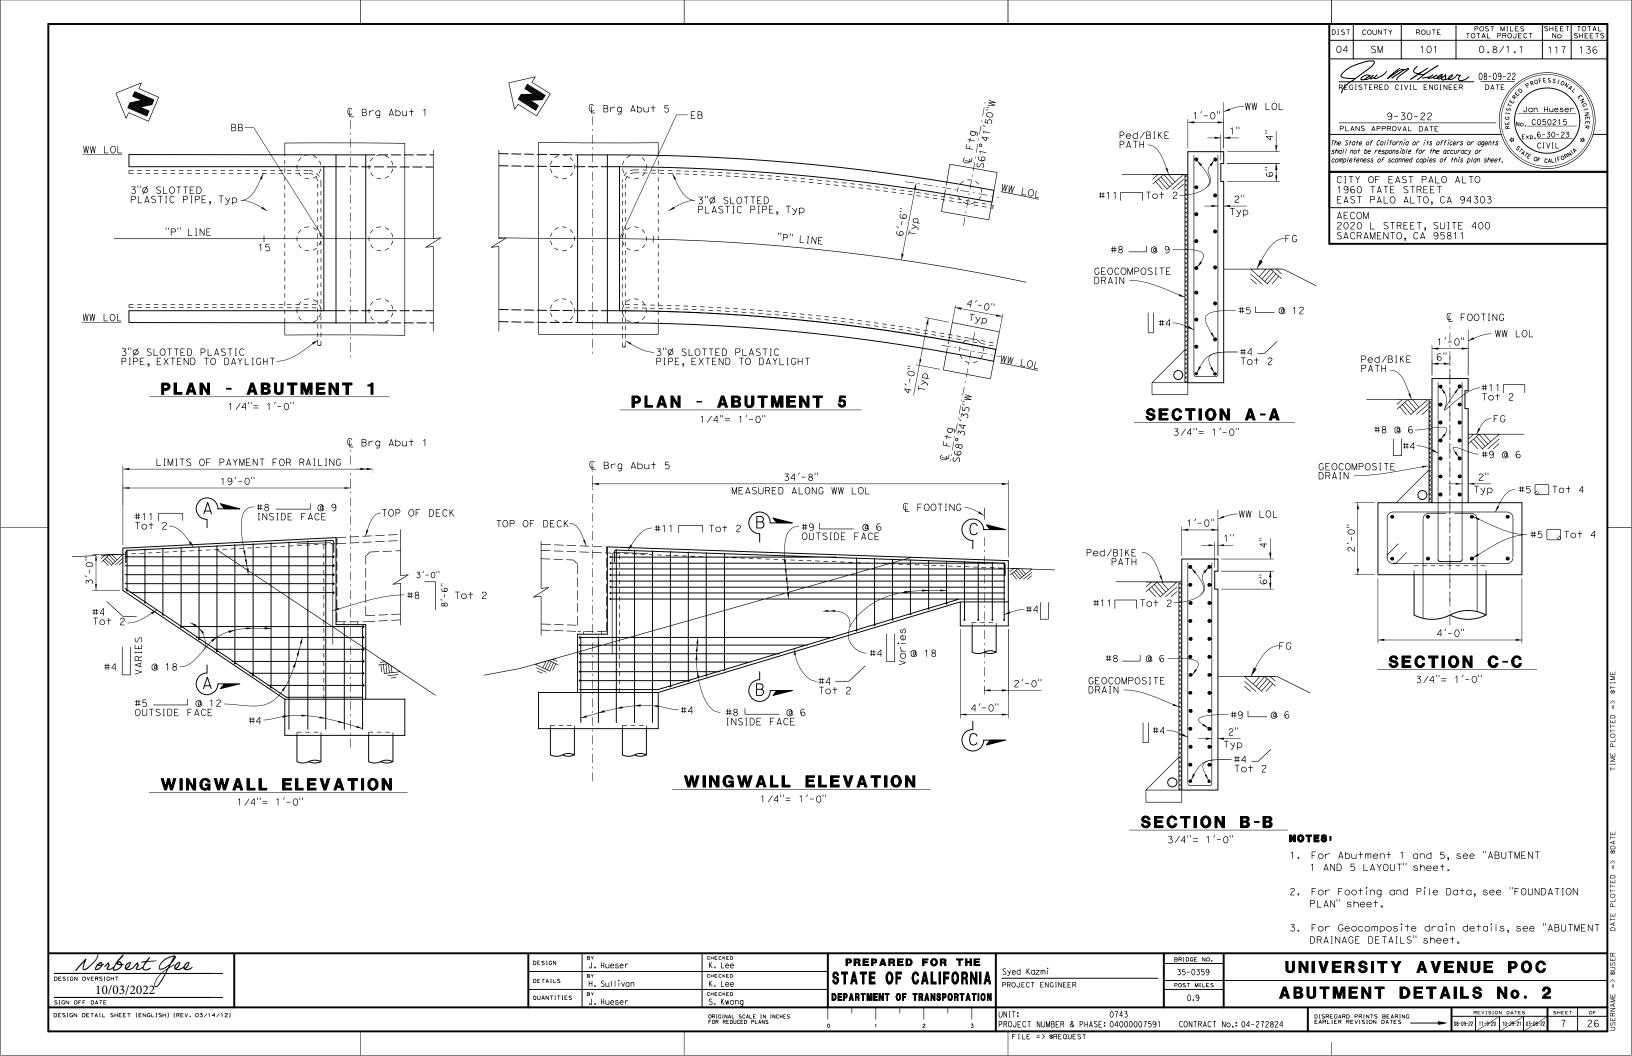

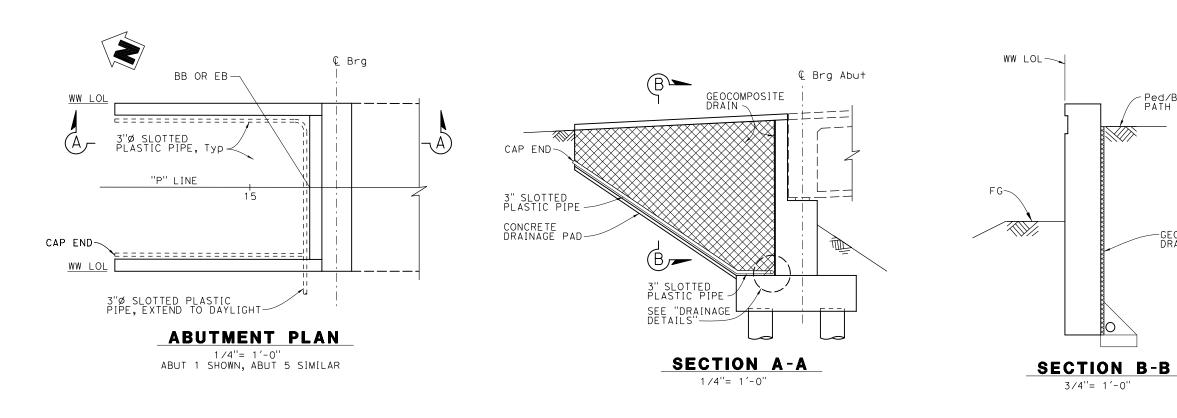

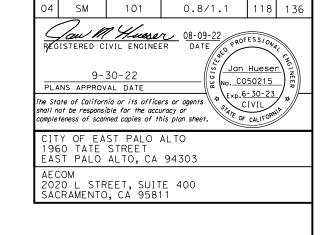

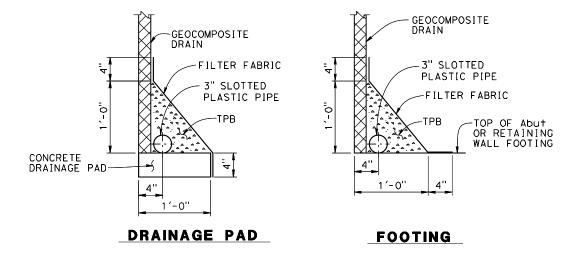

DRAINAGE DETAILS

NOTES:

CONTRACT No.: 04-272824

Ped/BIKE


-GEOCOMPOSITE DRAIN


- 1. For Abutment 1 and 5 layout, see "ABUTMENT 1 AND 5 LAYOUT" sheet.
- 2. For Footing and Pile Data, see "FOUNDATION PLAN" sheet.


PREPARED FOR THE BRIDGE NO. Norbert Gee K. Lee DESIGN UNIVERSITY AVENUE POC Syed Kazmi 35-0359 STATE OF CALIFORNIA CHECKED K. Lee 10/03/2022 DETAILS H. Sullivan PROJECT ENGINEER POST MILES ABUTMENT DRAINAGE DETAILS QUANTITIES BY J. Hueser DEPARTMENT OF TRANSPORTATION DESIGN DETAIL SHEET (ENGLISH) (REV. 03/14/12) UNIT: 0743 PROJECT NUMBER & PHASE: 04000007591 ORIGINAL SCALE IN INCHES FOR REDUCED PLANS DISREGARD PRINTS BEARING EARLIER REVISION DATES


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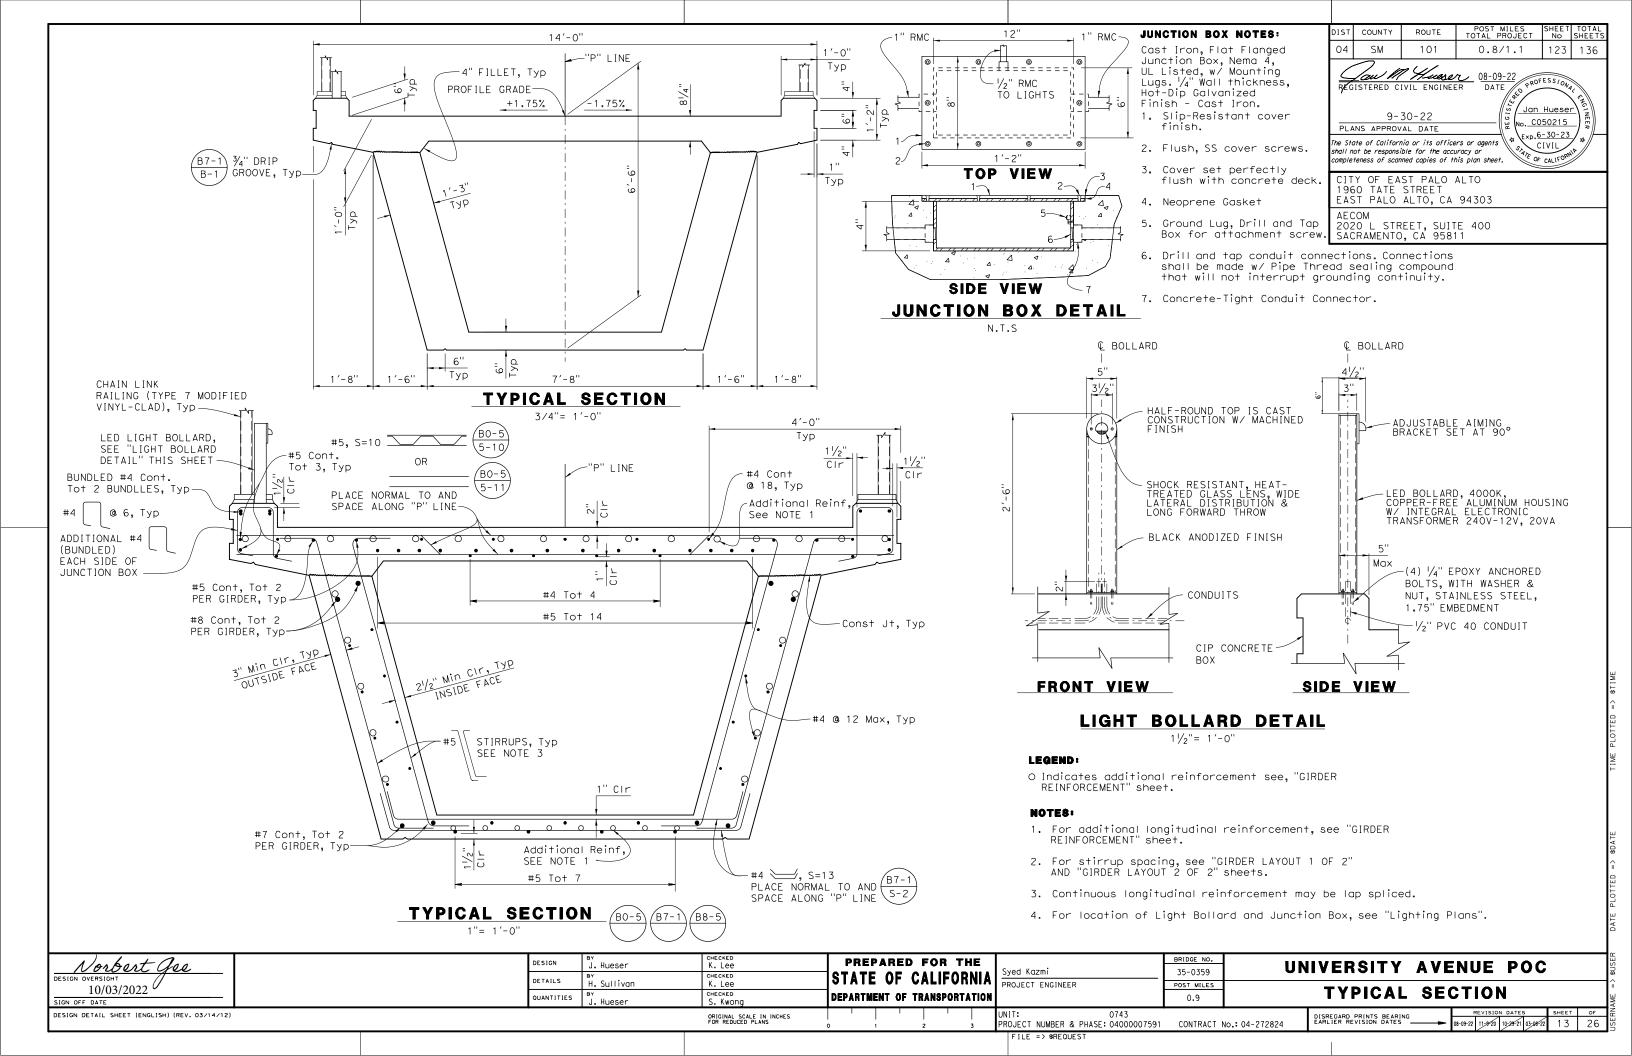
REVISION DATES SHEET OF 08-09-22 11-9-20 10-29-21 03-08-22 8 26




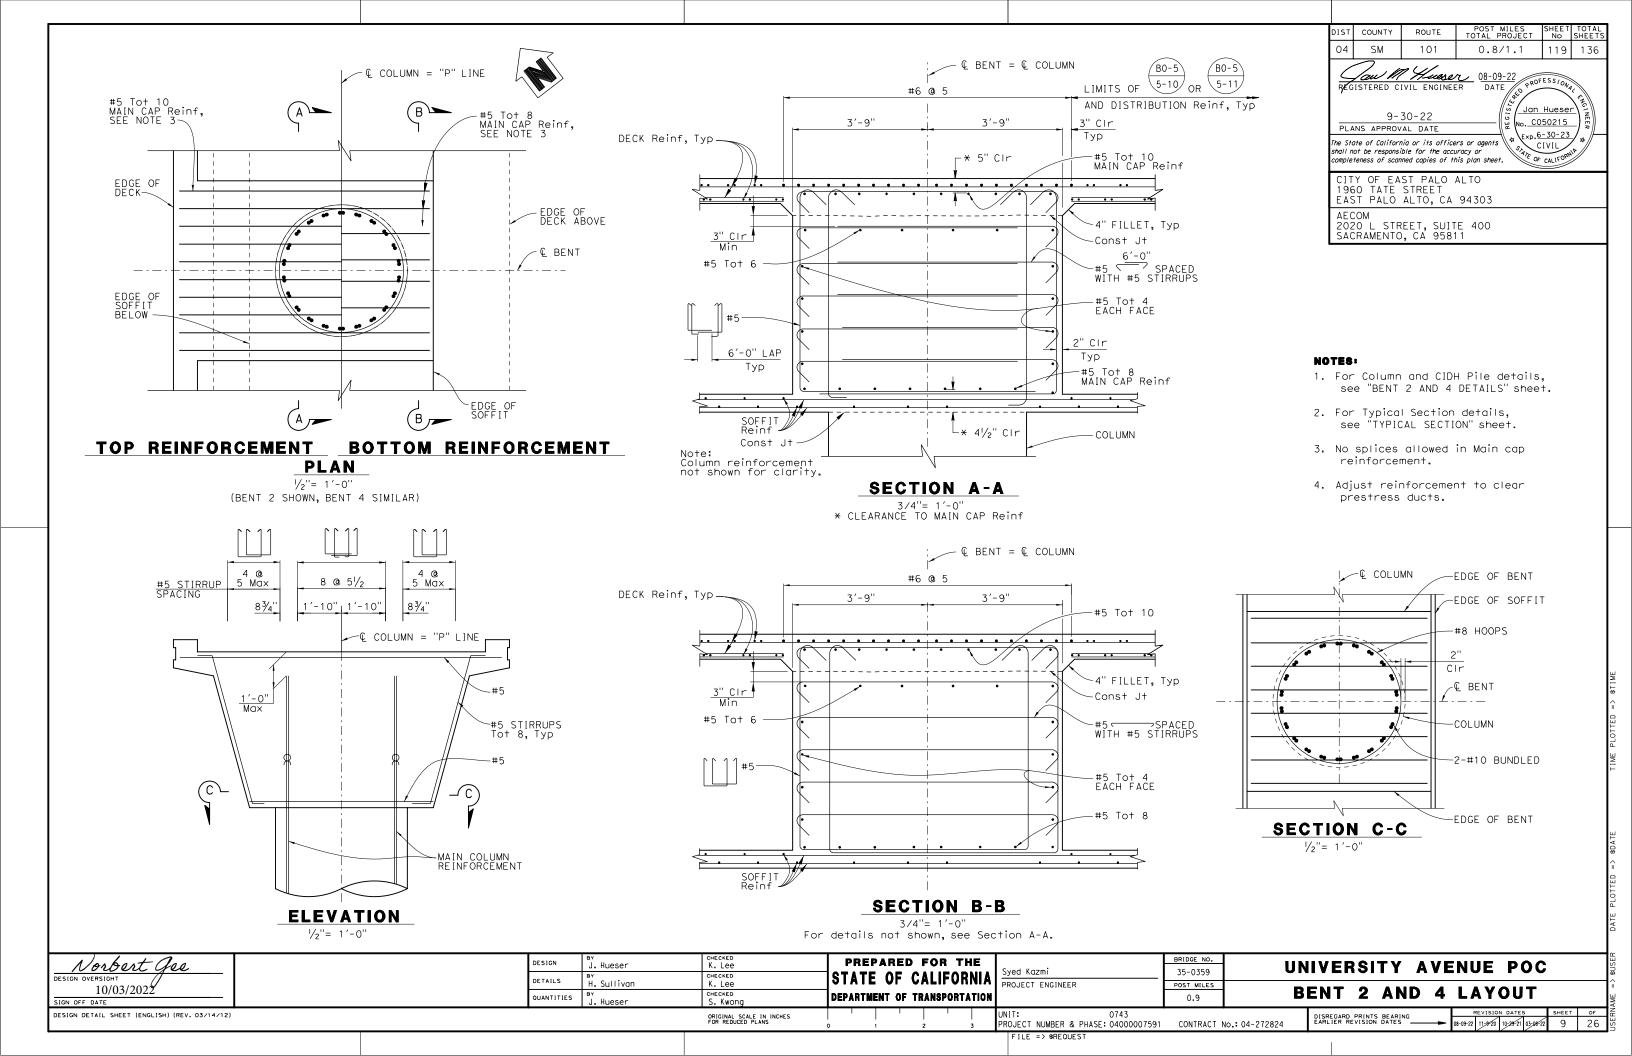


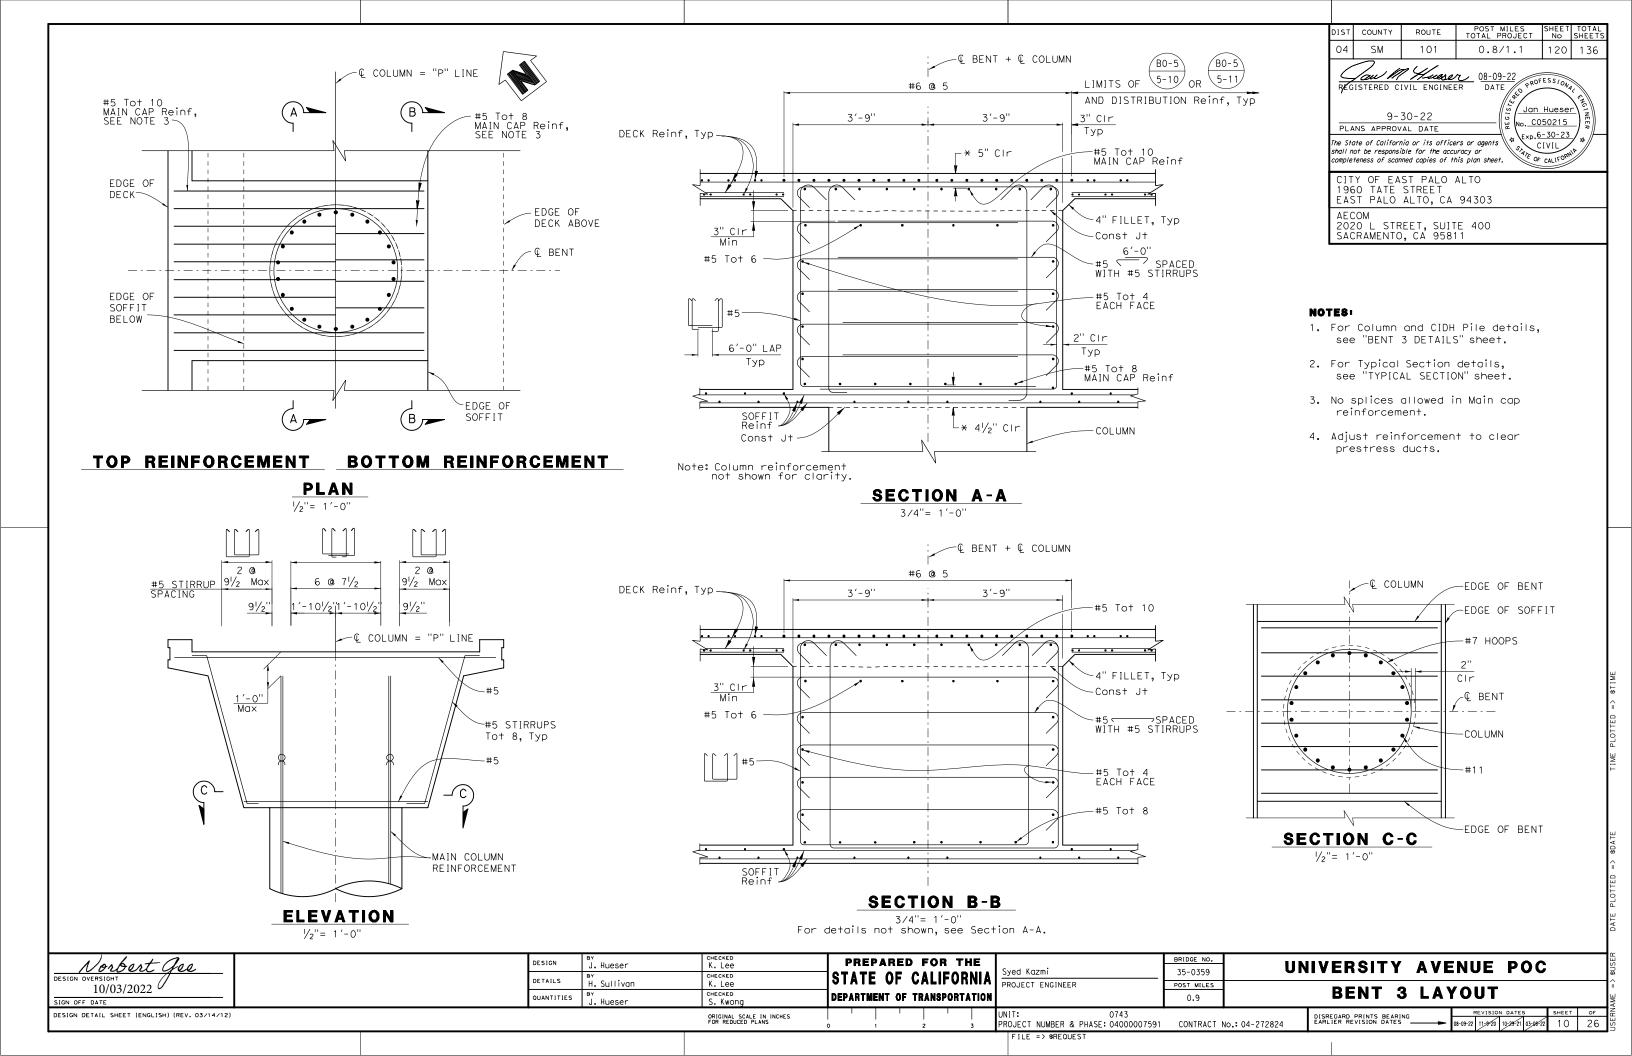


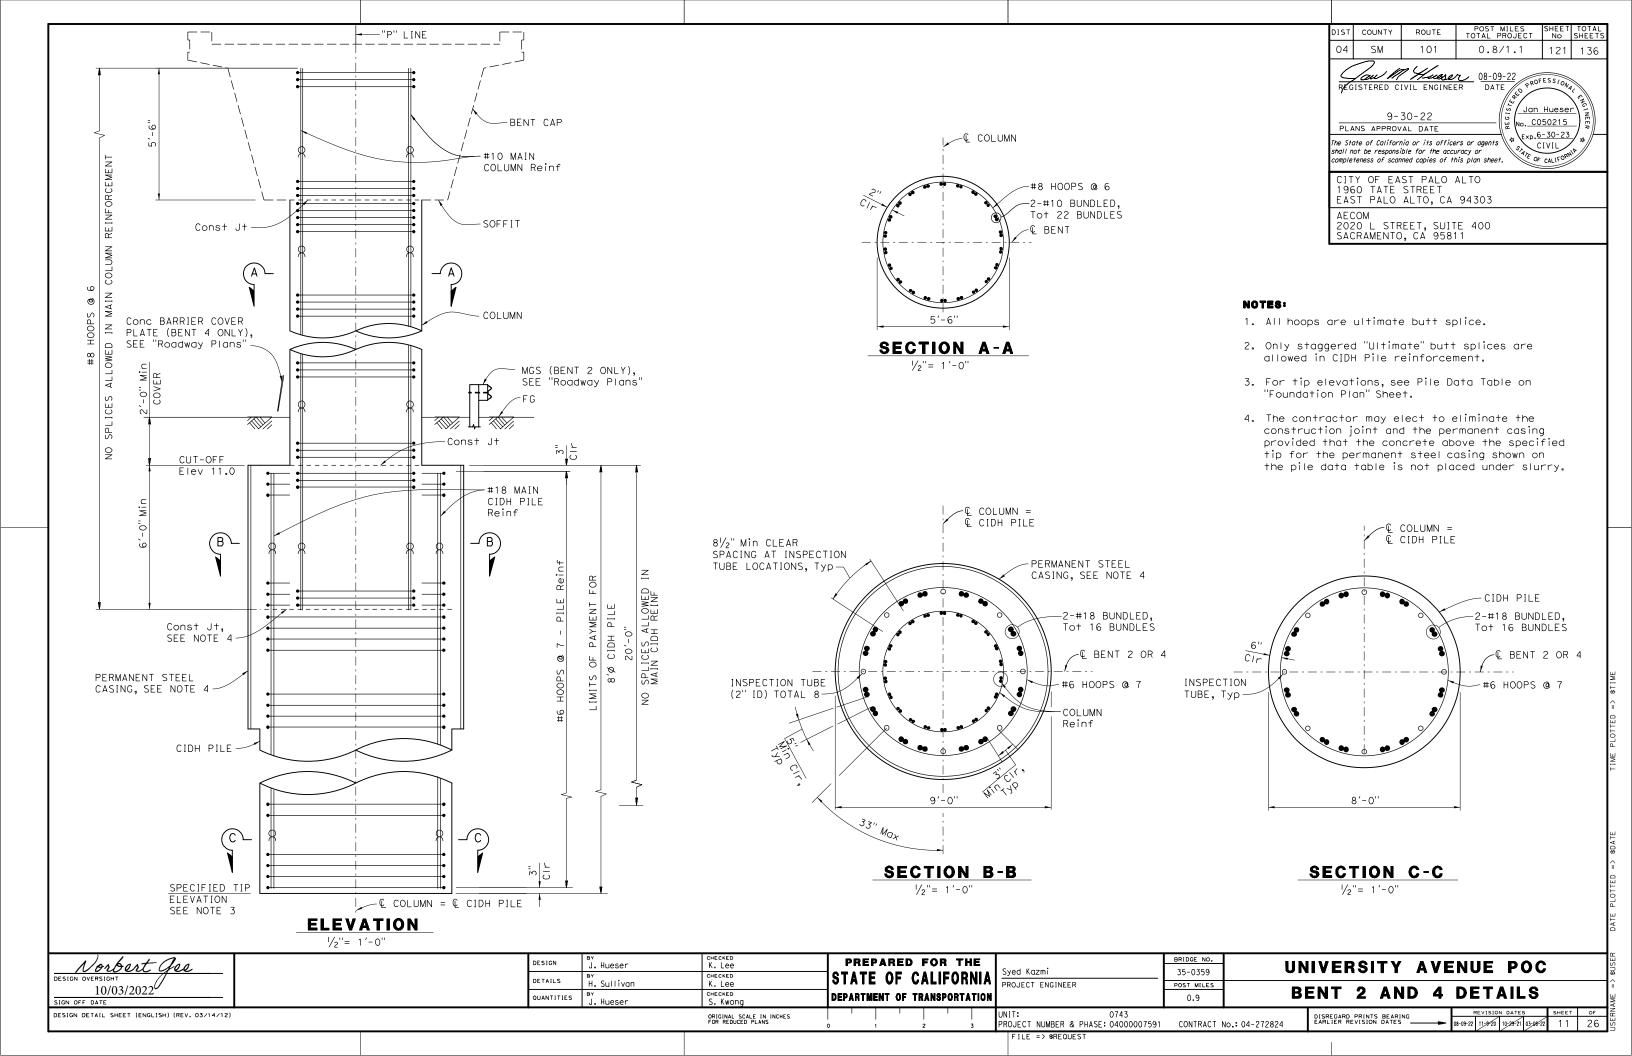

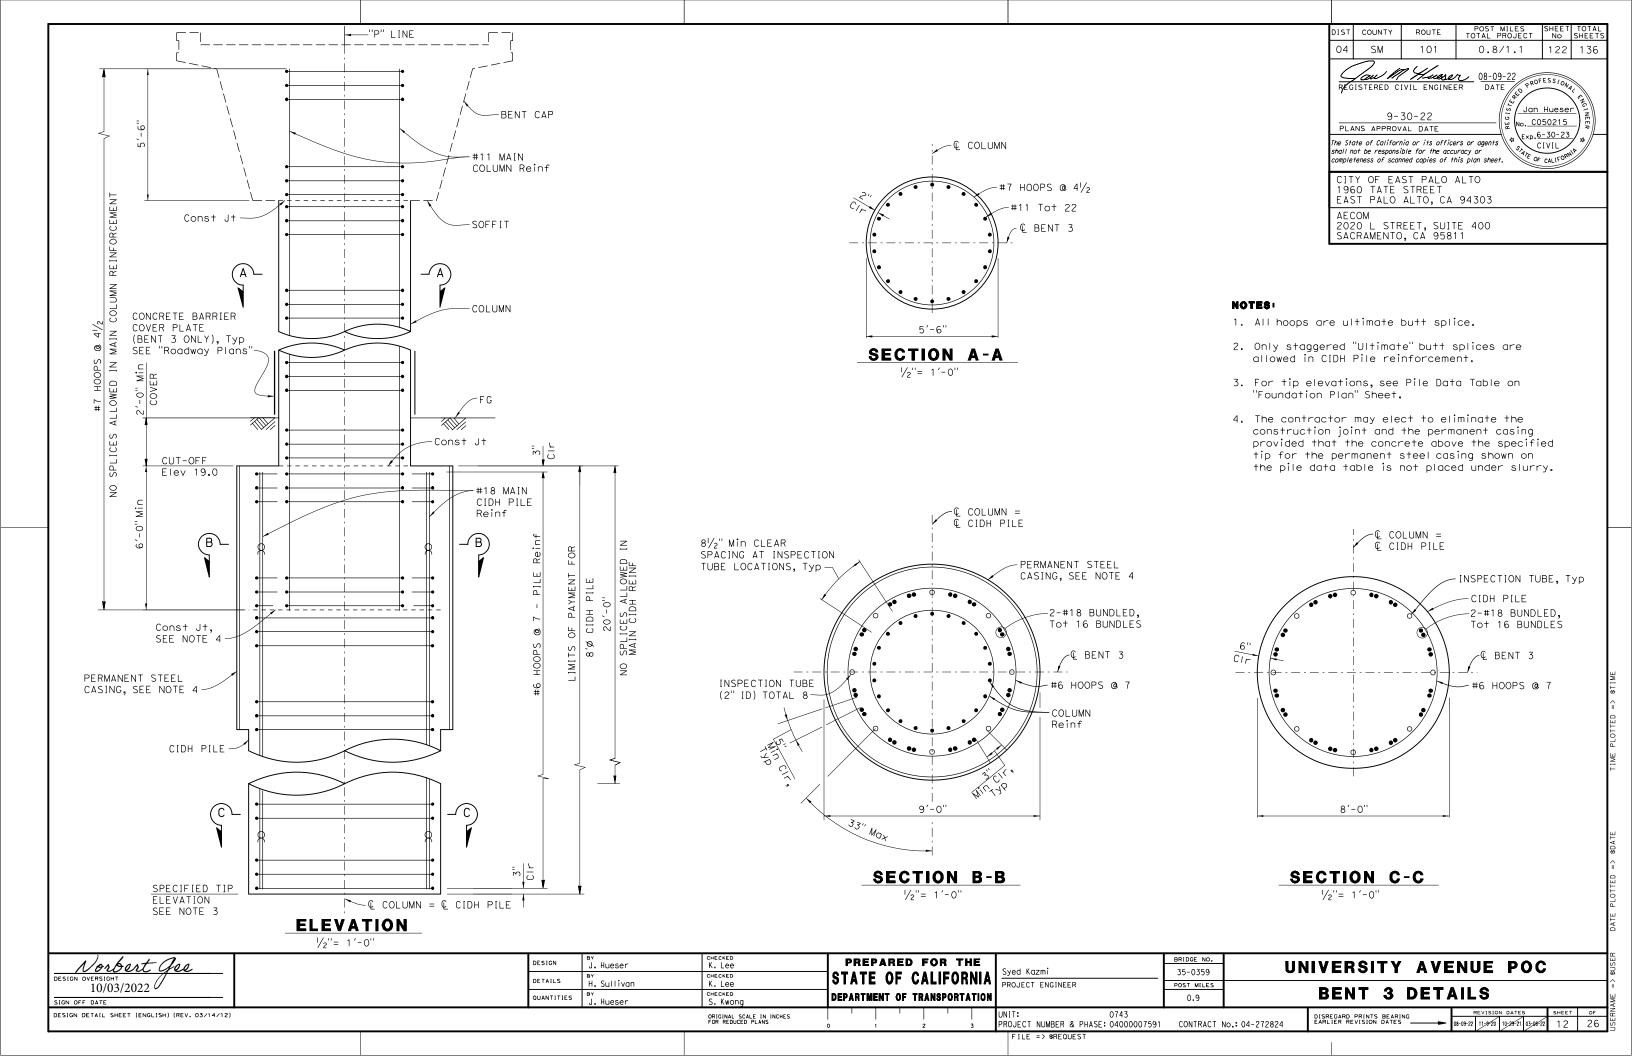


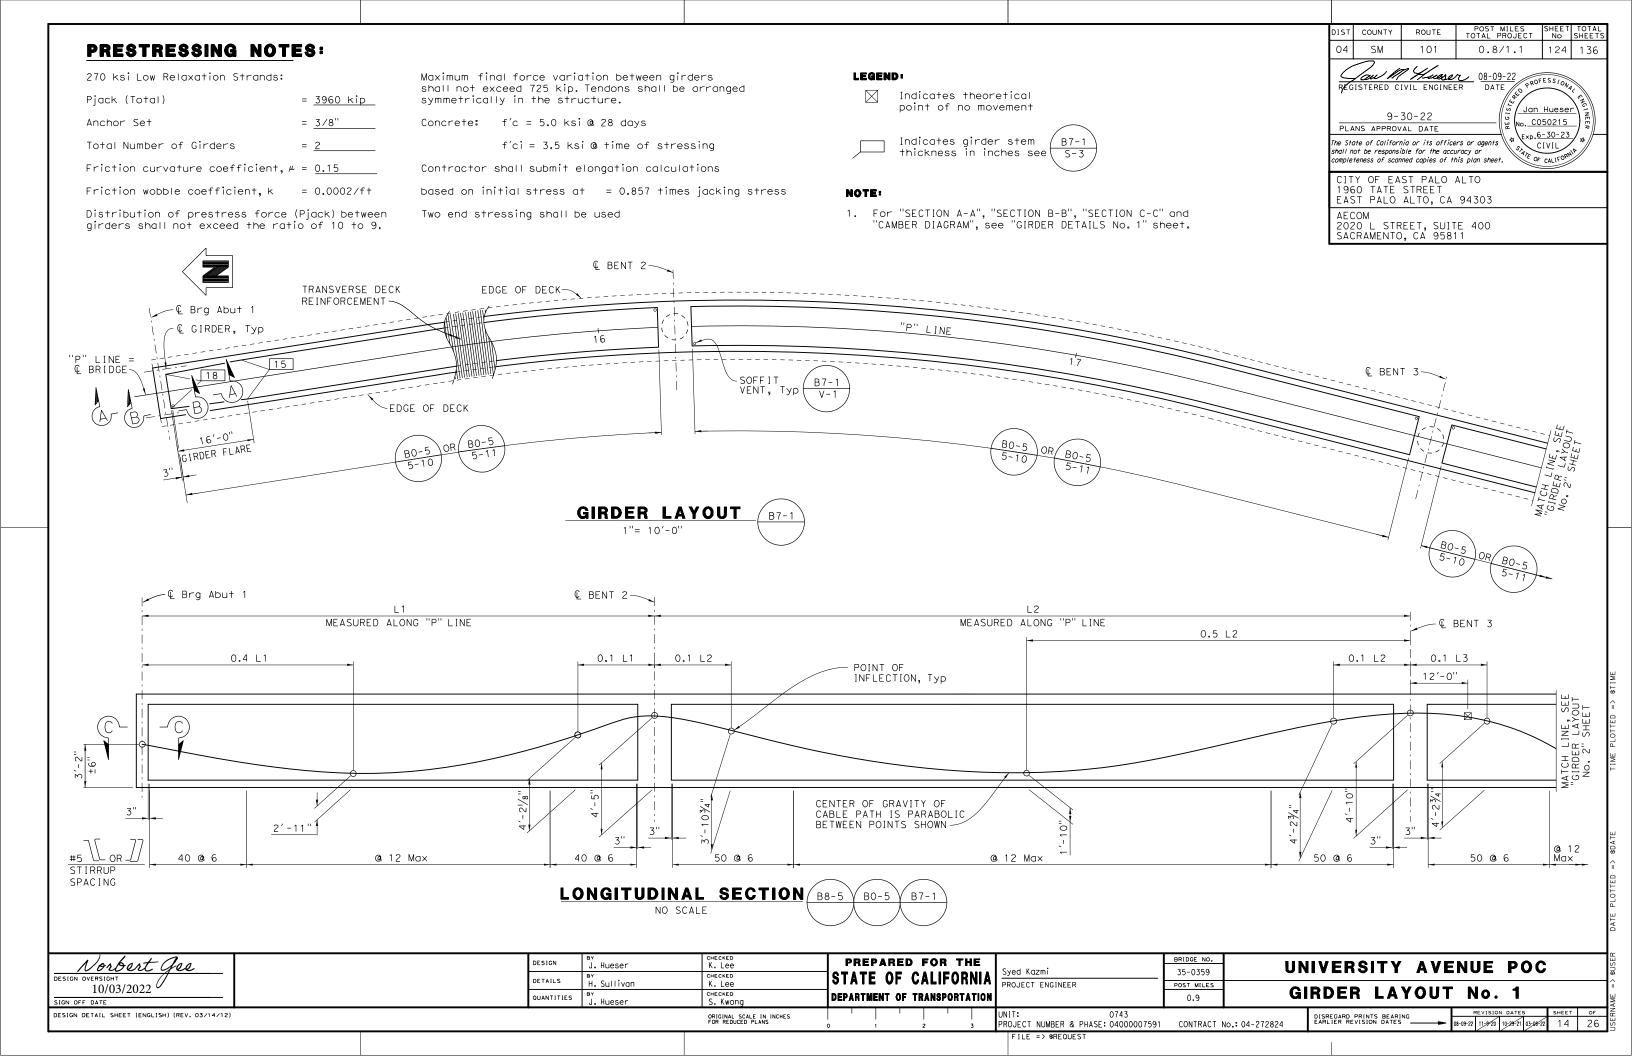


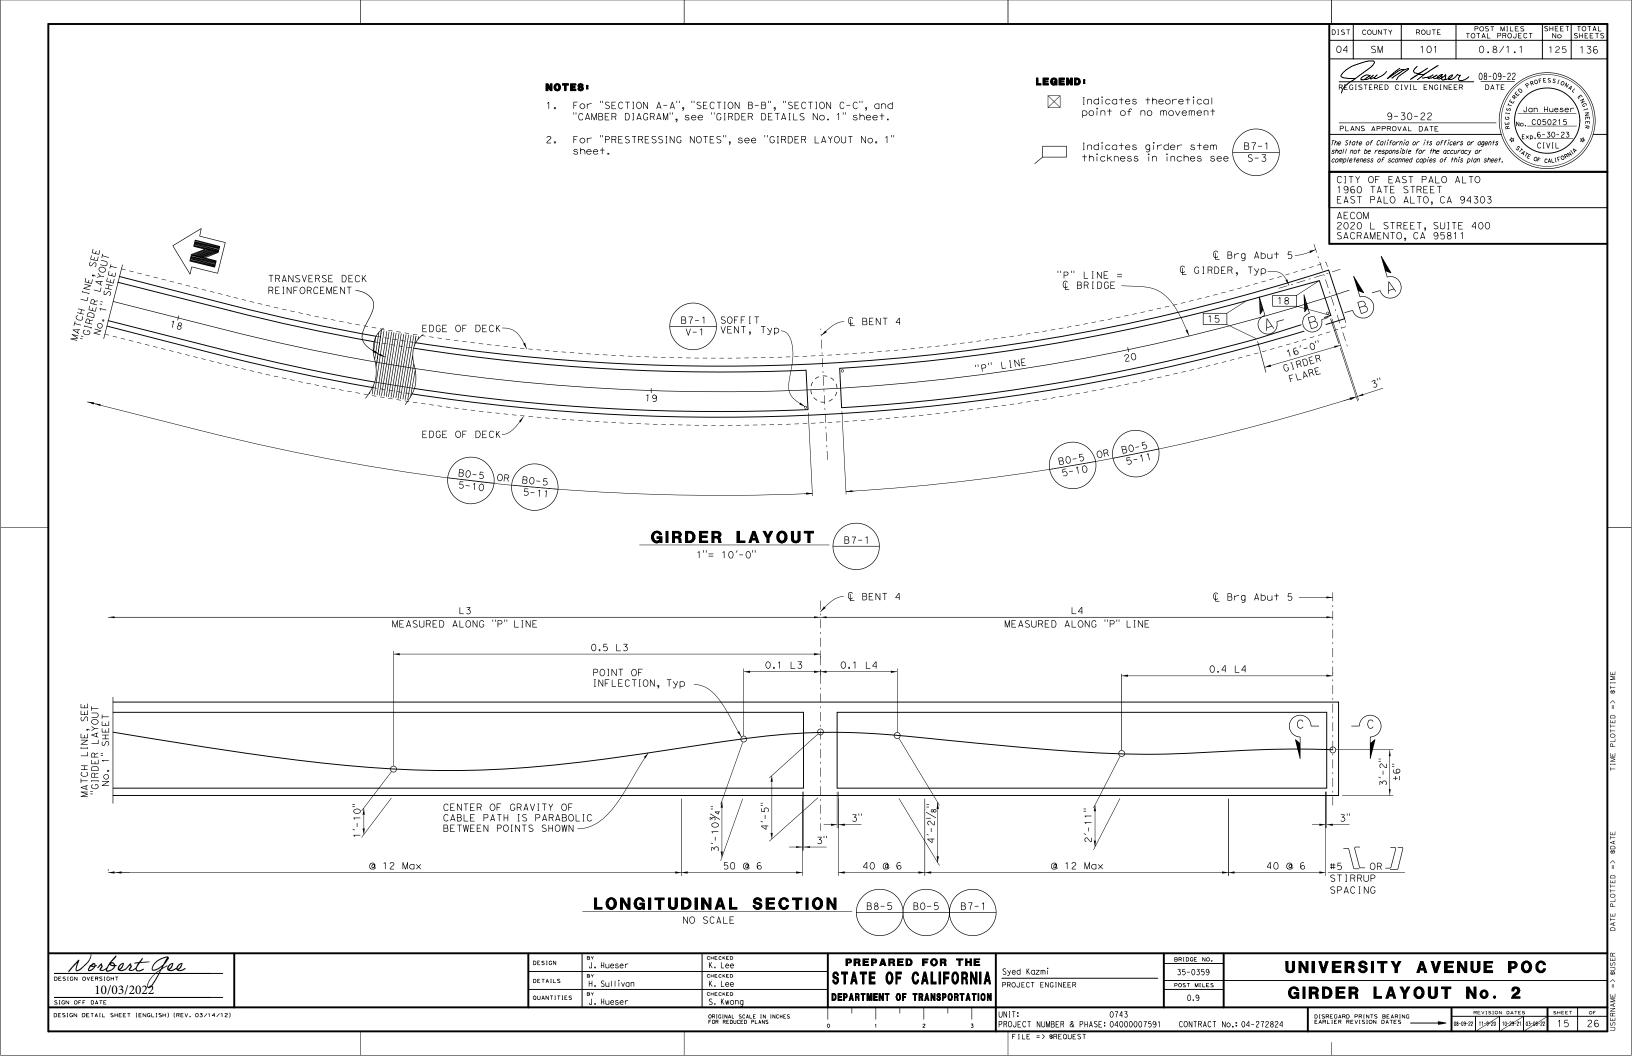


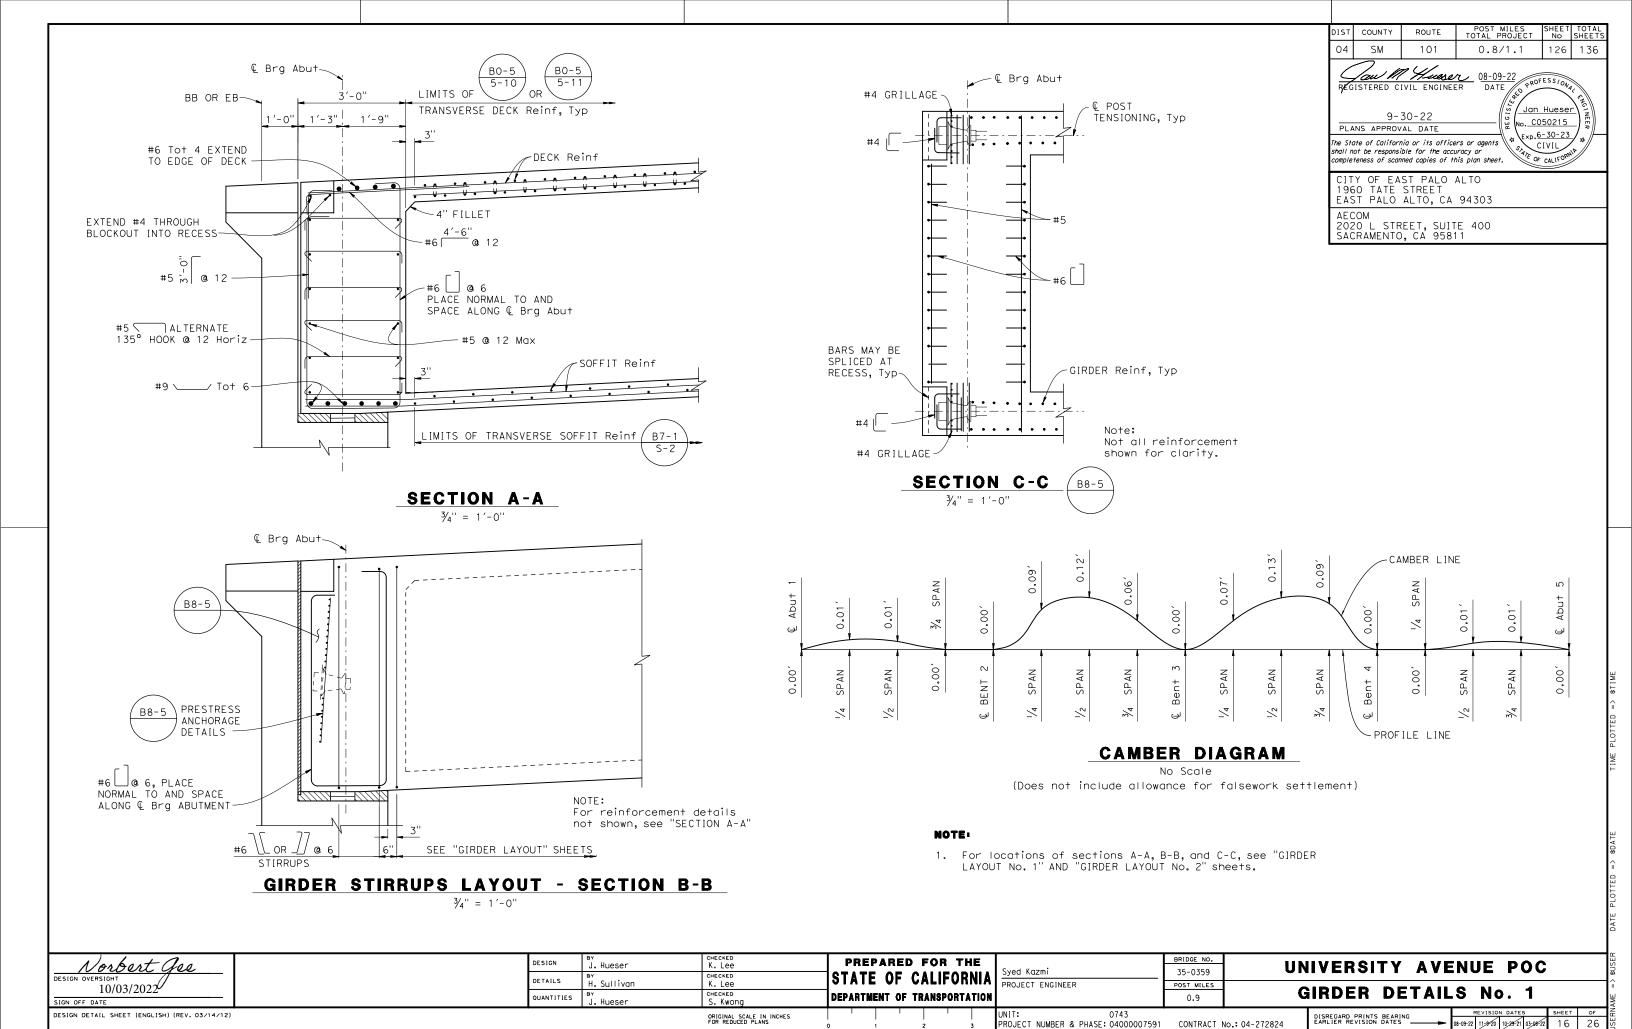



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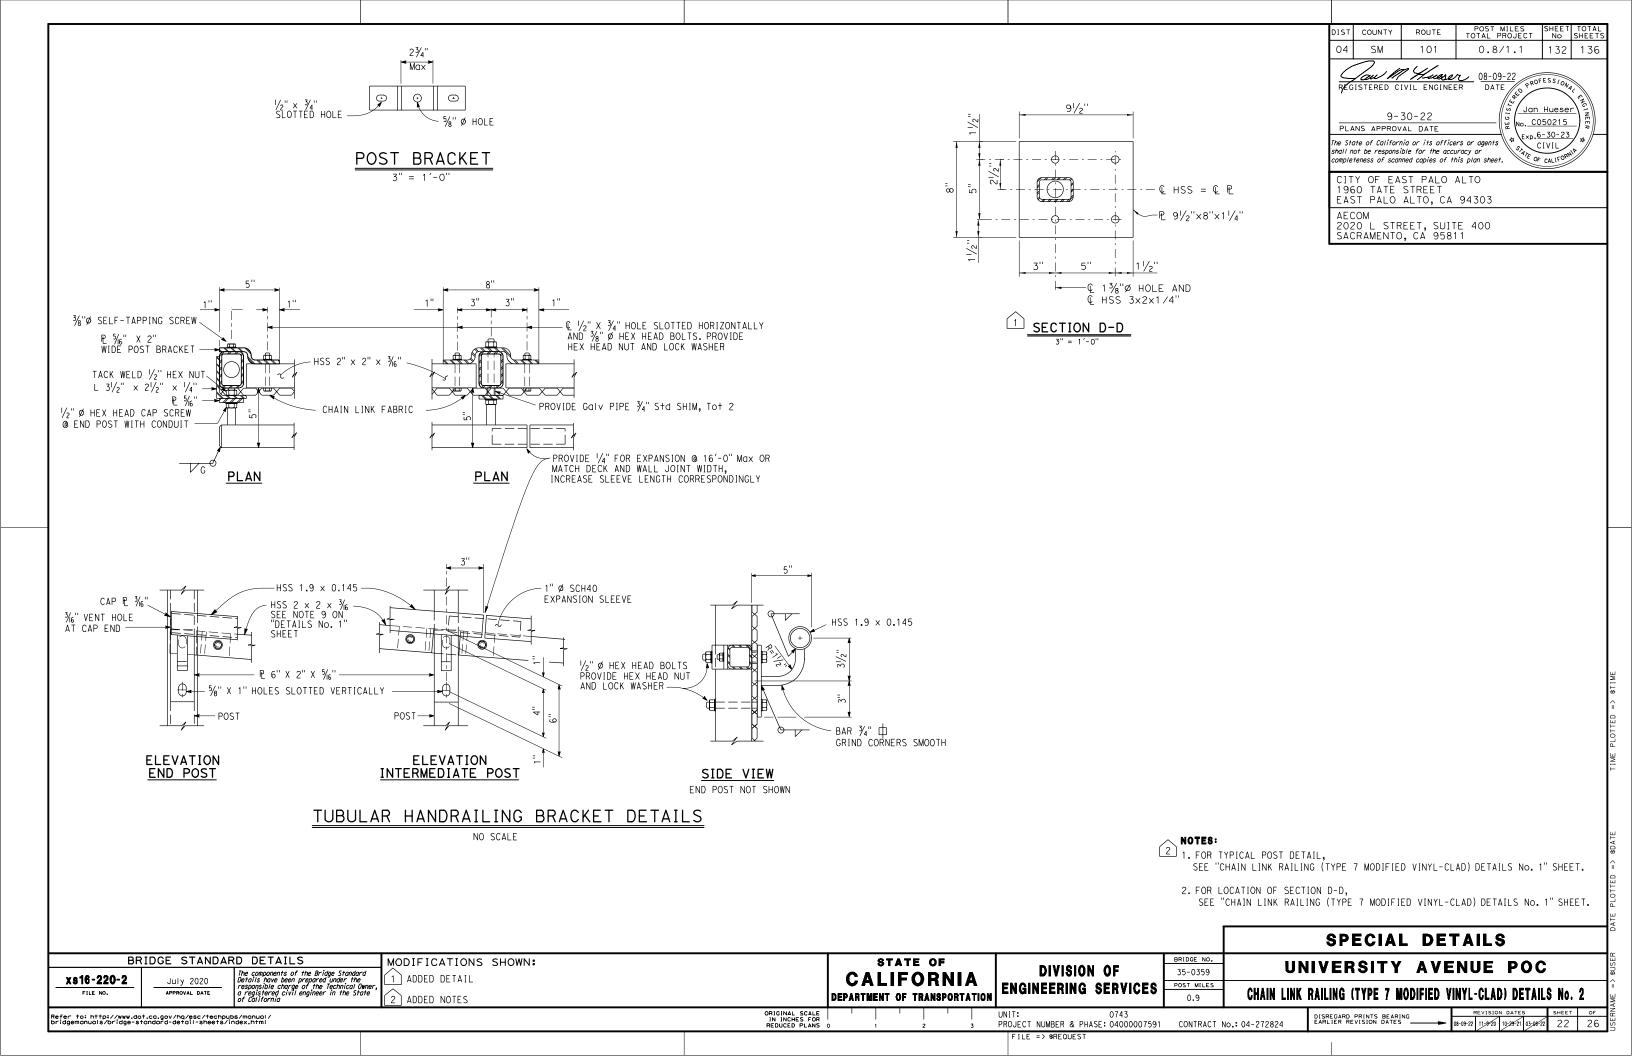


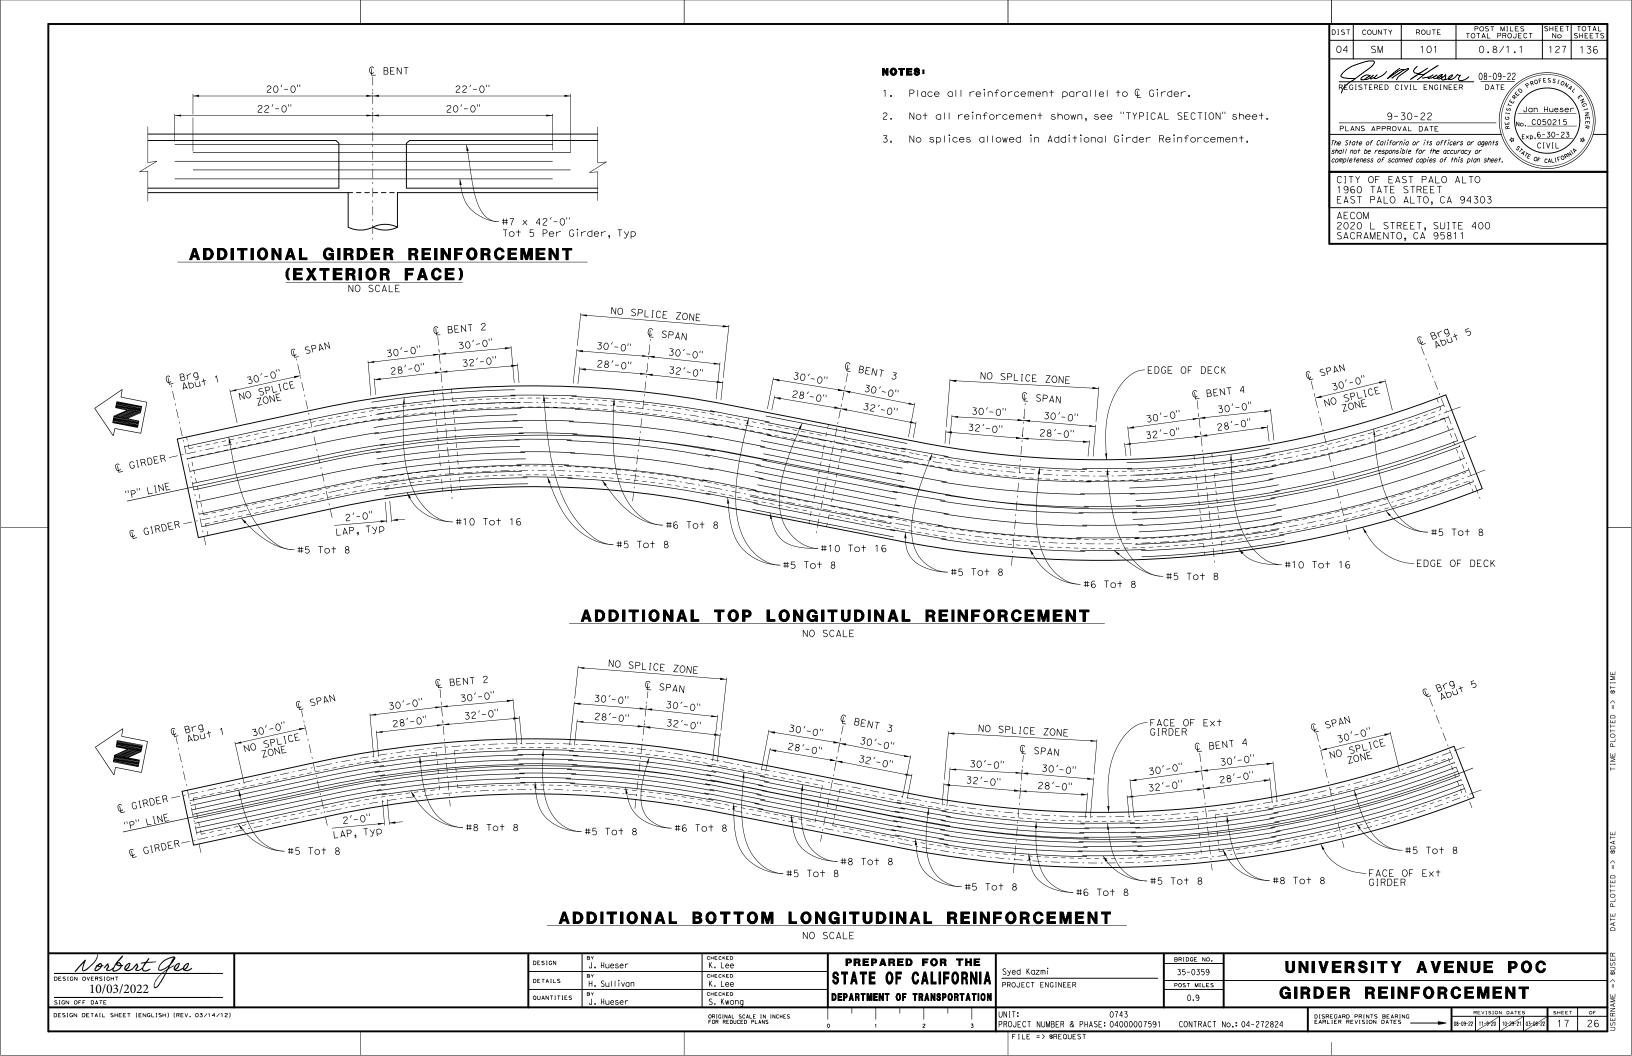


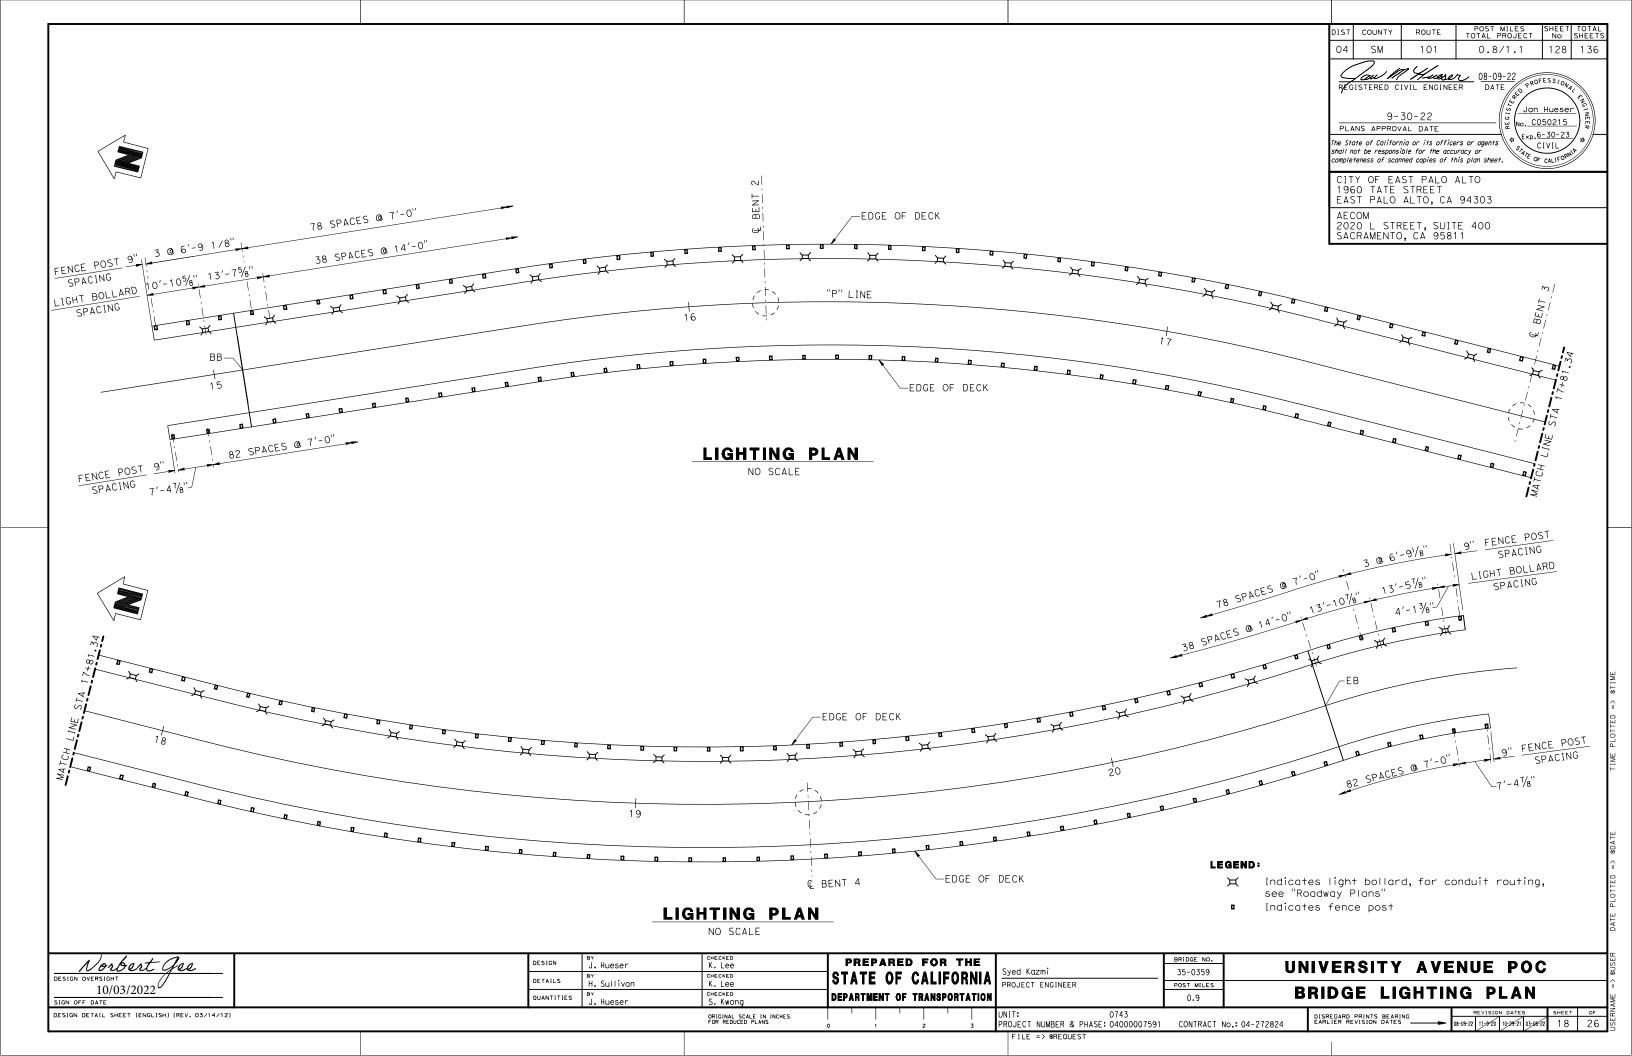


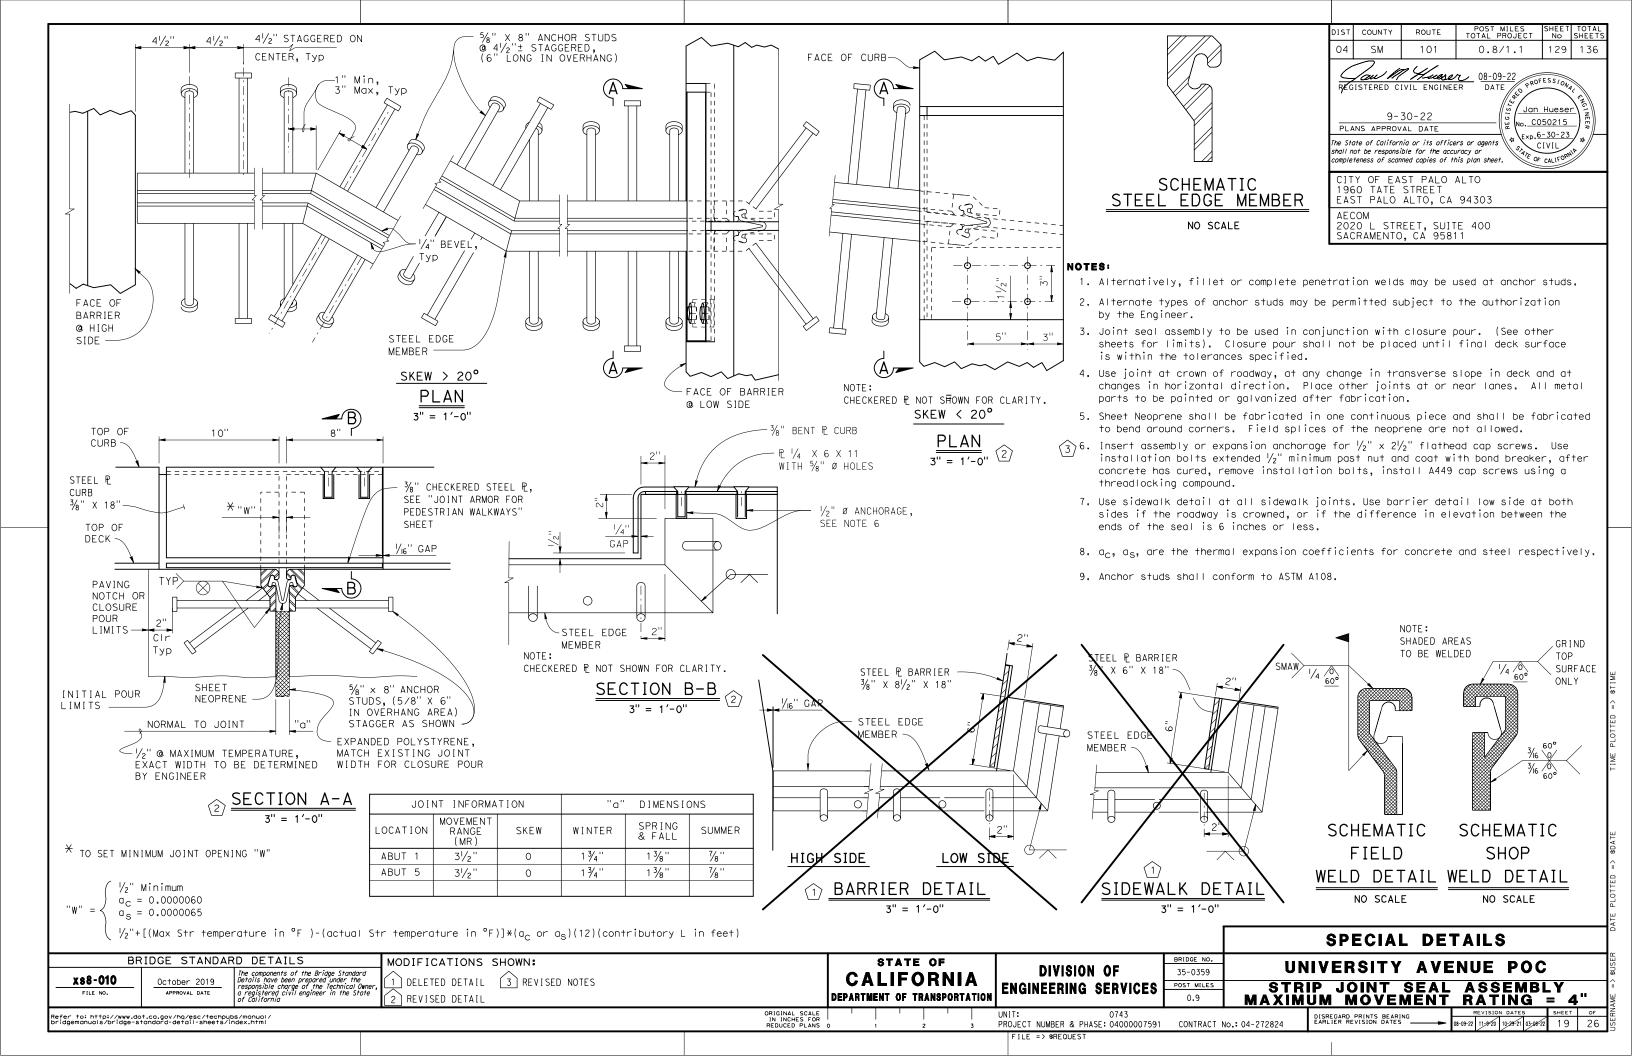


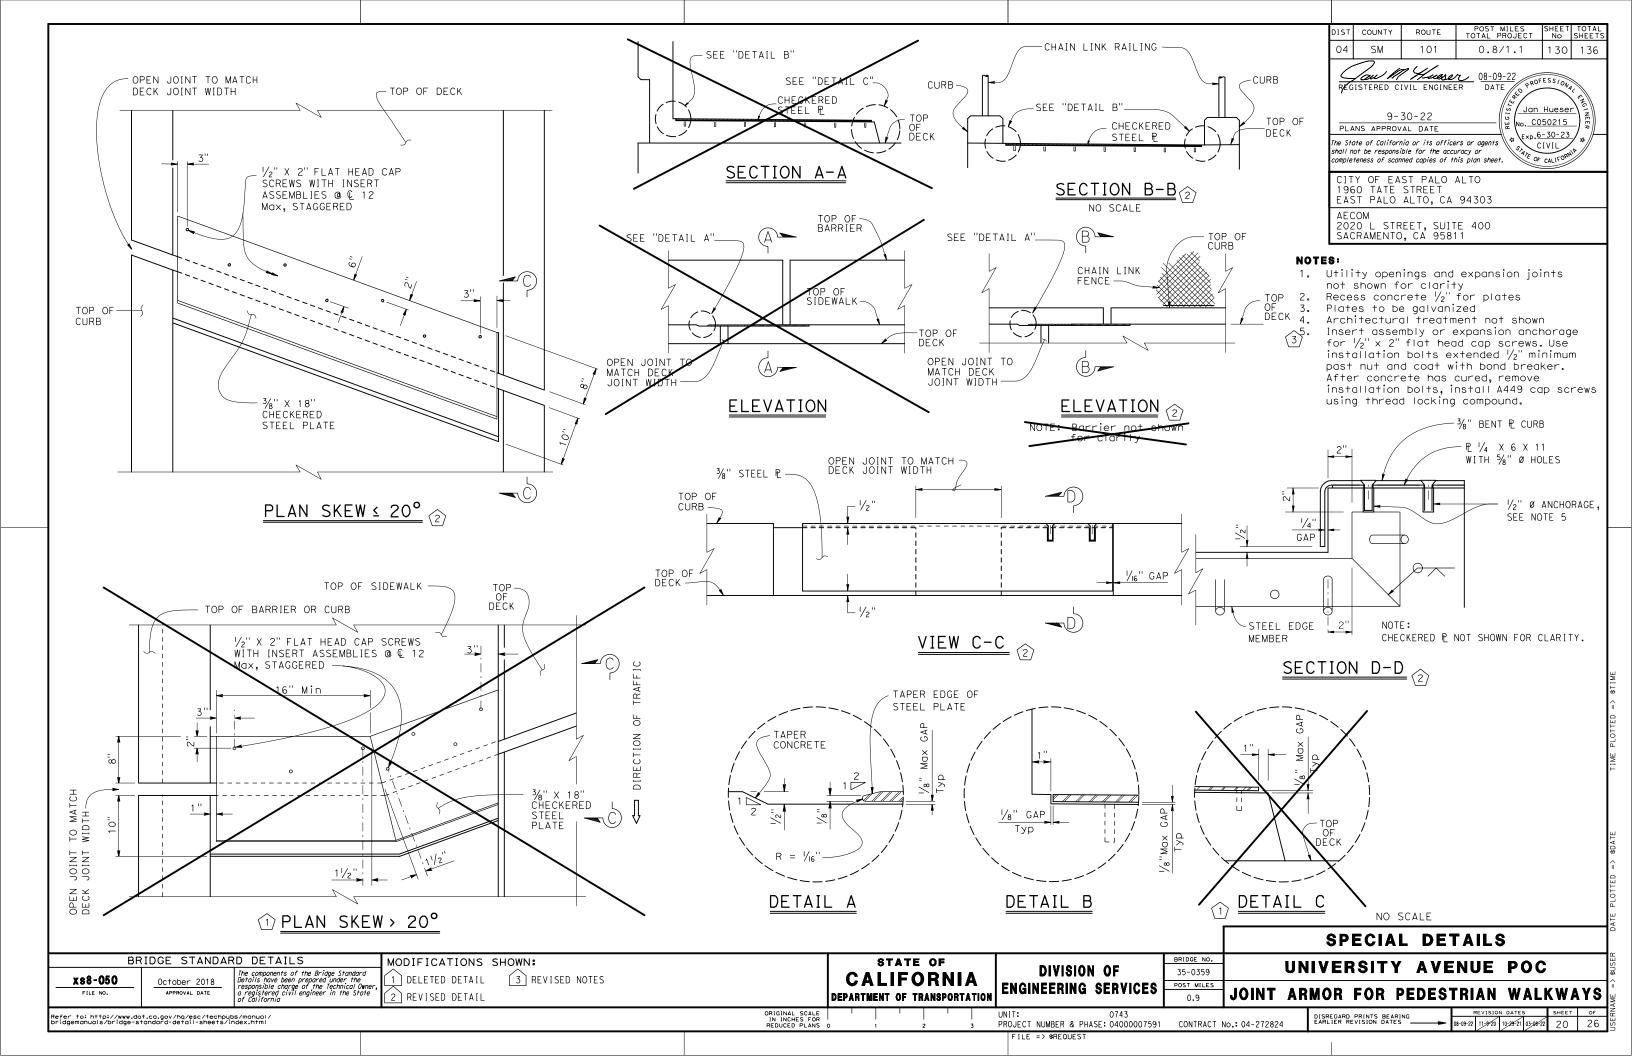

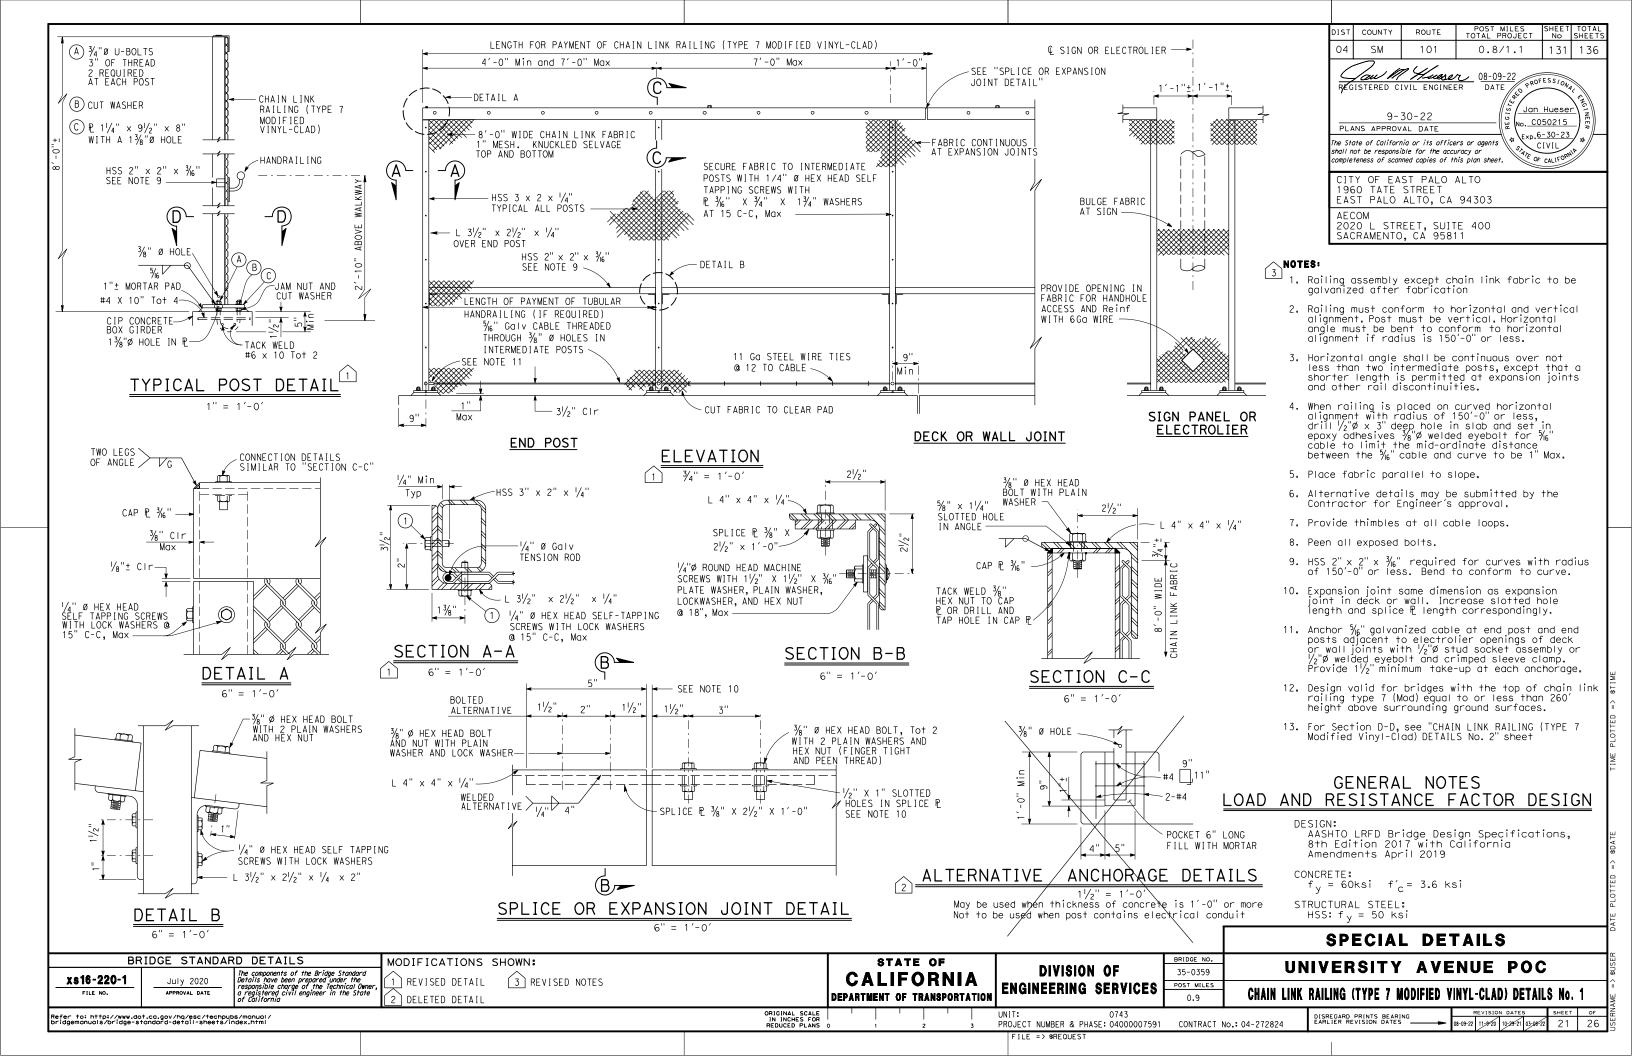

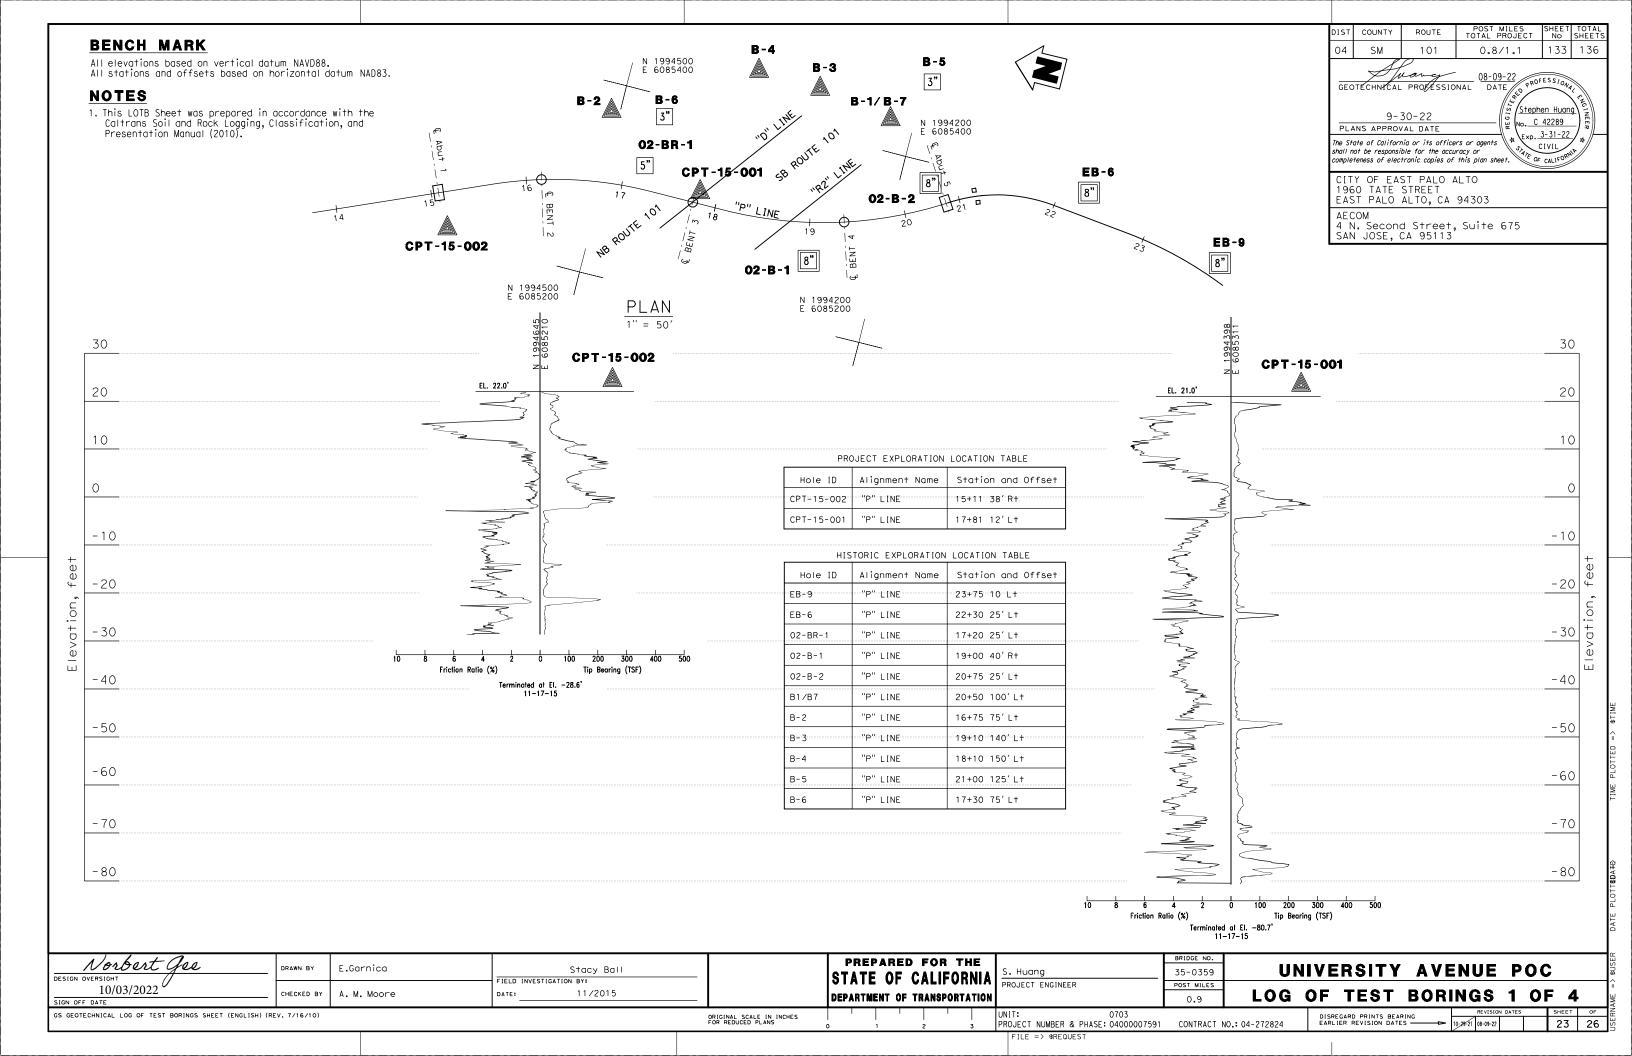

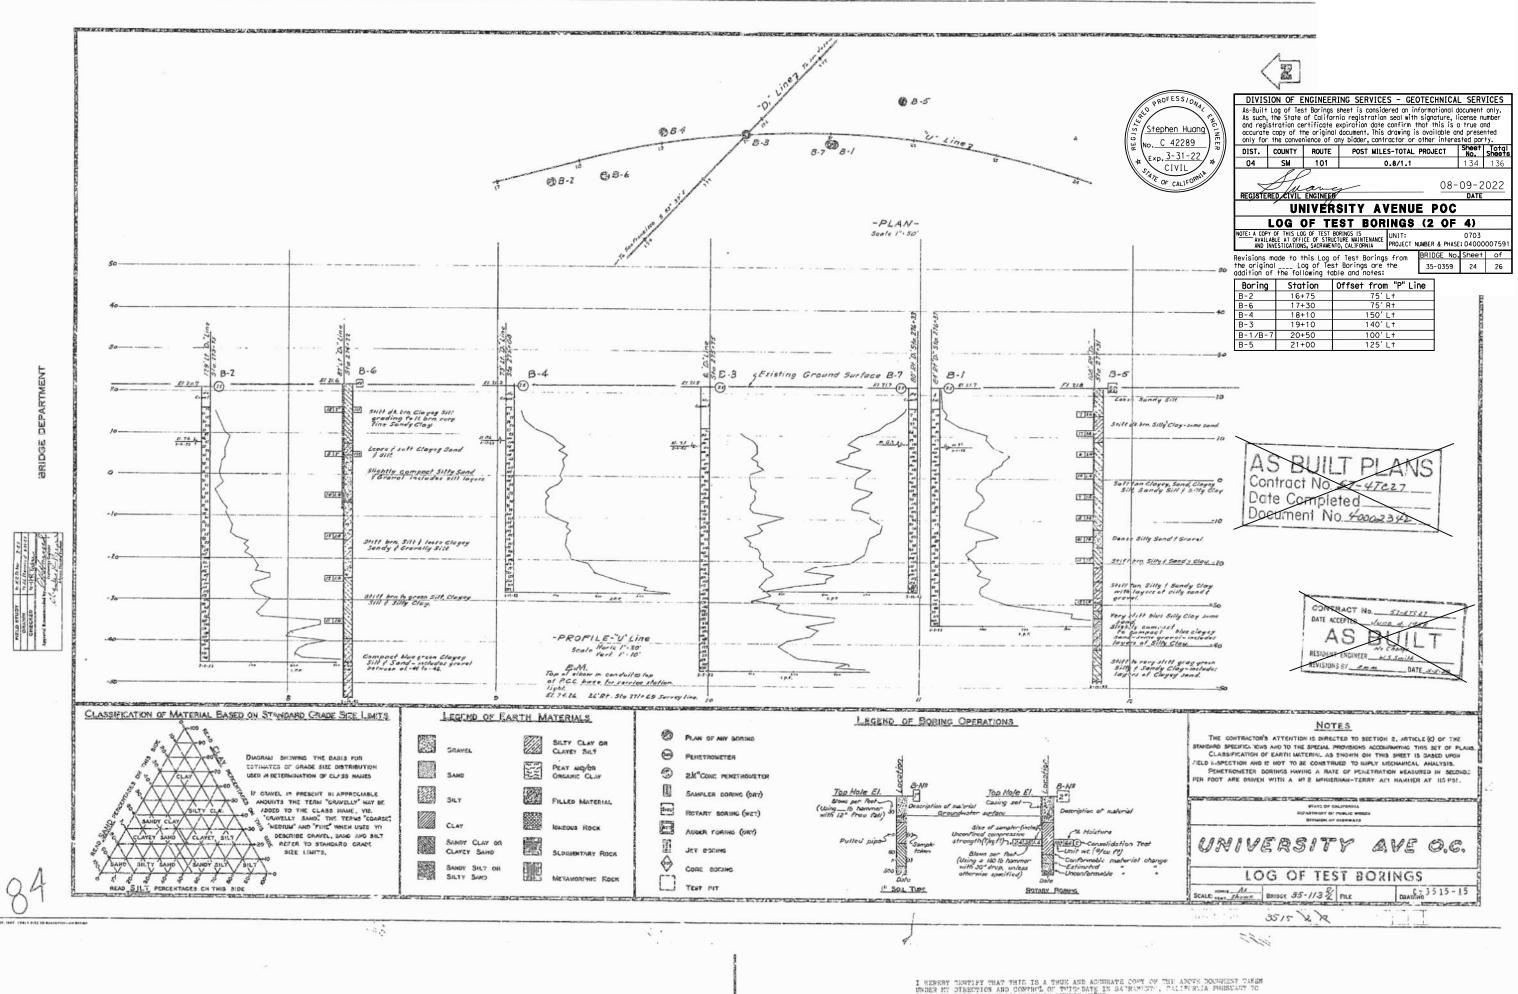

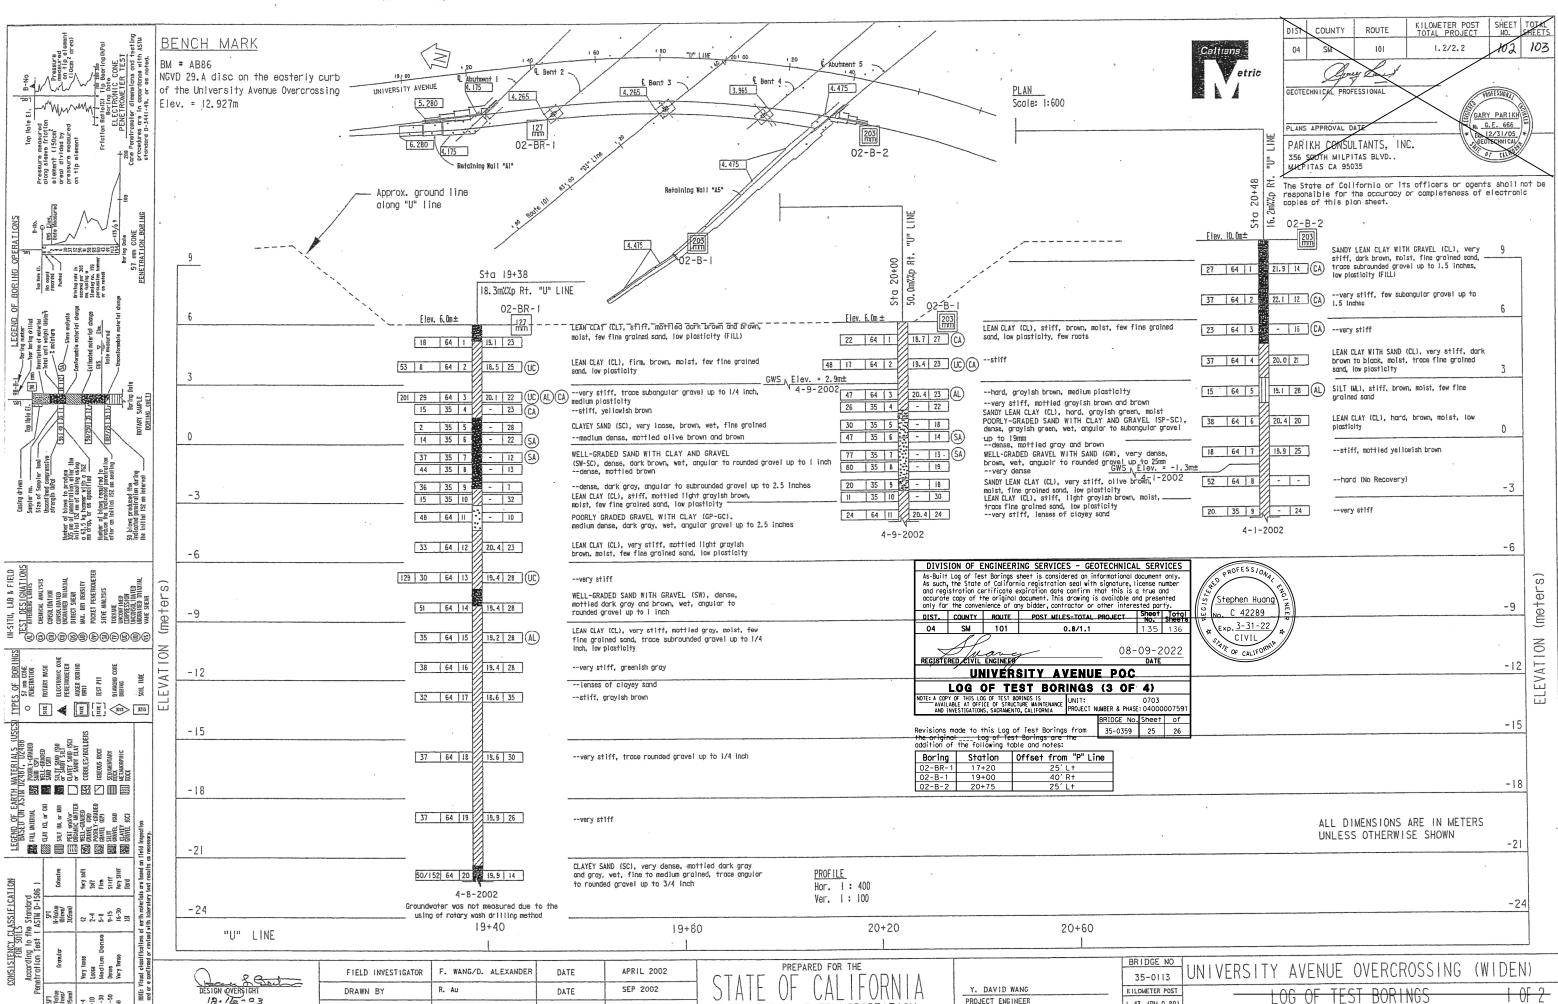I HEREBY DESTITY THAT THIS IS A TRUE AND ADDURATE COPY OF THE ARCYS DOCUMENT TAKEN UNDER MY DIRECTION AND CONTROL OF THIS DATE IN SATRAMENT, CALIFORNIA PHRECAUT TO AUTHORIZATION BY THE DIRECTOR OF FUEL OF UNDER A DATE AND ADDURANT OF THE CONTROL


CHECKED BY

Y. DAVID WANG

ORIGINAL SCALE IN MILLIMETERS

REVISION DATES (PRELIMINARY STAGE ONLY) SHEET OF

.43 (PM 0.89)

CII 04245

DISREGARD PRINTS BEARING

